

PROPOSED SUBDIVISION LOTS 429 AND 501  
KRUGER AVENUE, WINDANG, NSW, 2528




LOCALITY PLAN  
SCALE 1:1000

DRAWING LIST


No.	DRAWING TITLE
C001	COVER SHEET AND LOCALITY PLAN
C002	GENERAL NOTES
C010	EROSION AND SEDIMENT CONTROL PLAN
C011	EROSION AND SEDIMENT CONTROL DETAILS
C100	CAPPING PLAN - BULK EARTHWORKS
C101	CAPPING - BULK EARTHWORKS SECTIONS - SHEET 1
C102	CAPPING - BULK EARTHWORKS SECTIONS - SHEET 2
C103	CAPPING - BULK EARTHWORKS SECTIONS - SHEET 3
C200	FLOOD STORAGE PLAN - EXISTING
C201	FLOOD STORAGE PLAN - EXISTING LOT 501
C202	FLOOD STORAGE PLAN - EXISTING LOT 429
C203	FLOOD STORAGE PLAN - DESIGN
C204	FLOOD STORAGE PLAN - DESIGN 501
C205	FLOOD STORAGE PLAN - DESIGN 429
C300	SITEWORKS PLAN
C301	CAPPING LAYER MAKE UP LAYOUT PLAN
C400	VEHICLE TURNING PATH PLAN - SHEET 1
C401	VEHICLE TURNING PATH PLAN - SHEET 2

LOCALITY PLAN LEGEND

- APPROXIMATE EXTENT OF WORKS

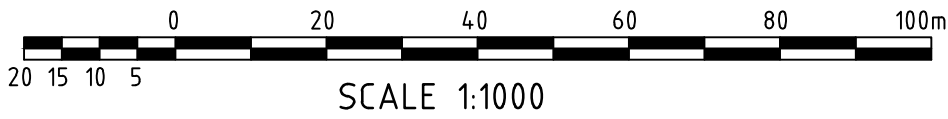

NOT TO BE USED FOR CONSTRUCTION			
AMDT	DATE	DESCRIPTION	BY
2	29.11.21	ISSUED FOR DA	DM
1	05.08.21	PRELIMINARY ISSUE	LAP

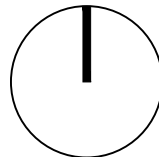

CLIENT  
WINDANG KRUGER UNIT TRUST  
STATUS  
PRELIMINARY DA ISSUE

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DISCIPLINE  
CIVIL DESIGN  
DRAWING TITLE  
COVER SHEET AND LOCALITY PLAN

PROJECT  
PROPOSED SUBDIVISION LOTS 429 AND 501  
ADDRESS  
KRUGER AVENUE, WINDANG NSW, 2528

PROJECT DETAILS  
DESIGN DM  
DRAWN DM  
DATE JUL 2021  
DRG SIZE A1  
SCALE AS SHOWN  
PROJECT BA  
MGR  
WWW.JN.COM.AU  
N0210053  
C001 2



# PROPOSED SUBDIVISION LOTS 429 AND 501

## KRUGER AVENUE, WINDANG, NSW, 2528

### GENERAL

- ALL WORKS SHALL BE CARRIED OUT IN ACCORDANCE WITH THE NOMINATED OR APPLICABLE COUNCIL SPECIFICATION, WHERE A SPECIFICATION HAS NOT BEEN NOMINATED THEN THE CURRENT NSW DEPARTMENT OF HOUSING CONSTRUCTION SPECIFICATION IS TO BE USED. THE NOMINATED SPECIFICATION SHALL TAKE PRECEDENCE TO THESE NOTES.
- ALL DRAWINGS SHOULD BE READ IN CONJUNCTION WITH THE RELEVANT ARCHITECTURAL DRAWINGS & DRAWINGS FROM OTHER CONSULTANTS.
- THE CONTRACTOR SHOULD REPORT ANY DISCREPANCIES ON THE DRAWINGS TO THE ENGINEER RESPONSIBLE FOR THE DESIGN.
- THE CONTRACTOR SHOULD LOCATE AND LEVEL ALL EXISTING SERVICES PRIOR TO COMMENCING CONSTRUCTION AND PROTECT AND MAKE ARRANGEMENTS WITH THE RELEVANT AUTHORITY TO RELOCATE AND/OR ADJUST IF NECESSARY. INFORMATION GIVEN ON THE DRAWINGS IN RESPECT TO SERVICES IS FOR GUIDANCE ONLY AND IS NOT GUARANTEED COMPLETE NOR CORRECT.
- CONTRACTOR IS NOT TO ENTER UPON NOR DO ANY WORK WITHIN ADJACENT LANDS WITHOUT THE PERMISSION OF THE OWNER.
- SURPLUS EXCAVATED MATERIAL SHALL BE PLACED WHERE DIRECTED.
- ALL NEW WORKS SHALL MAKE A SMOOTH JUNCTION WITH EXISTING.
- ALL DRAINAGE LINES THOUGH ADJACENT LOTS SHALL BE CONTAINED WITHIN EASEMENTS CONFORMING TO COUNCIL'S STANDARDS.
- THE CONTRACTOR SHALL CLEAR THE SITE BY REMOVING ALL RUBBISH, FENCES AND DEBRIS ETC. TO THE EXTENT SPECIFIED.
- PRIOR TO COMMENCEMENT OF WORK, THE CONTRACTOR SHALL PROVIDE A TRAFFIC MANAGEMENT PLAN PREPARED BY AN ACCREDITED PERSON IN ACCORDANCE WITH RMS REQUIREMENTS, FOR ANY WORK ON OR ADJACENT TO PUBLIC ROADS, PLAN TO BE SUBMITTED TO COUNCIL & RMS.

### SURVEY

- JIN ARE NOT RESPONSIBLE FOR THE ACCURACY OF ANY 3RD PARTY INFORMATION PROVIDED ON THIS DRAWING.
- ALL LEVELS ARE TO A.H.I.D.
- ALL CHAINAGES AND LEVELS ARE IN METRES, AND DIMENSIONS IN MILLIMETRES.
- SET OUT COORDINATES ARE BASED ON SURVEY DRAWINGS PROVIDED FOR THE PURPOSE OF CARRYING OUT THE ENGINEERING DESIGN.
- CONTRACTOR SHALL VERIFY ALL SET OUT COORDINATES SHOWN ON THE PLANS WITH A REGISTERED SURVEYOR.
- CONTRACTOR SHALL ARRANGE FOR THE WORKS TO BE SET OUT BY A REGISTERED SURVEYOR.
- ANY DISCREPANCIES SHOULD BE CLARIFIED IN WRITING WITH THE ENGINEER PRIOR TO COMMENCEMENT OF THE WORK FOR CONFIRMATION OF THE SURVEY.

### EARTHWORKS

- PROVIDE PROTECTION BARRIERS TO PROTECTED/SENSITIVE AREAS PRIOR TO ANY BULK EXCAVATION.
- PRIOR TO ANY FILLING IN AREAS OF CUT OR IN EXISTING GROUND, PROOF ROLL THE EXPOSED SURFACE WITH A ROLLER OF MINIMUM WEIGHT OF 5 TONNES WITH A MINIMUM OF 10 PASSES.
- FILL IN 200mm MAXIMUM (LOOSE THICKNESS) AND COMPACTED TO 98% STANDARD (AS 1289 5.1.1), MAXIMUM DRY DENSITY AT OPTIMUM MOISTURE CONTENT  $\pm 2\%$ .
- COMPACTION TESTING SHALL BE CARRIED OUT AT THE RATE OF 2 TESTS PER 1000SQ METRES PER LAYER BY A REGISTERED NATA LABORATORY. THE COSTS OF TESTING AND RE-TESTING ARE TO BE ALLOWED FOR BY THE BUILDER.
- BATTERS TO BE AS SHOWN, OR MAXIMUM 1 VERT : 4 HORIZ.
- ALL BATTERS AND FOOTPATHS ADJACENT TO ROADS SHALL BE TOP SOILED WITH 150mm APPROVED LOAM AND SEEDED UNLESS OTHERWISE SPECIFIED.

### DRAWING STATUS

#### PRELIMINARY

PRELIMINARY DRAWINGS ARE NOT TO BE USED FOR TENDER OR CONSTRUCTION PURPOSES.

#### TENDER

TENDER DRAWINGS ARE NOT TO BE USED FOR CONSTRUCTION PURPOSES AND ARE INTENDED FOR AN EXTENT OF WORKS. ALL OTHER CONSULTANT DRAWINGS AND CONTRACT DOCUMENTS SHOULD BE READ IN CONJUNCTION WITH THESE DOCUMENTS TO DETERMINE THE FULL EXTENT OF WORKS.

#### CONSTRUCTION CERTIFICATE

CONSTRUCTION CERTIFICATE DRAWINGS ARE NOT TO BE USED FOR CONSTRUCTION UNLESS APPROVED & STAMPED BY THE PCA.

#### CONSTRUCTION

CONSTRUCTION DRAWINGS CAN BE USED FOR CONSTRUCTION PURPOSES AND/OR FOR THE CREATION OF FABRICATION DRAWINGS.

### PROJECT INFORMATION TABLE

THE TABLES BELOW ARE TO BE READ IN CONJUNCTION WITH THE ADJACENT NOTES.

#### SITE AUDITOR INFORMATION

COMPANY	REPORT No.	DATED
C.M. JEWELL & ASSOCIATES PTY LTD.	J1755-5L	11.03.2020

#### SURVEY INFORMATION

COMPANY	DATED
C. ROBSON & ASSOCIATES PTY. LTD.	12.12.19

#### PROOF ROLLING

##### PROOF ROLLING SPECIFICATION

(min) ROLLER WEIGHT	(min) NUMBER OF PASSES
5 TONNE	10

#### COMPACTION TESTING

RATE OF TESTS	TEST AREA PER LAYER
2	1000m <sup>2</sup>

- TESTING SHALL BE CARRIED OUT BY A REGISTERED NATA LABORATORY

#### RIGID PAVEMENT DESIGN

- DESIGN LIFE 40 YEARS

DESIGN VEHICLE	DESIGN CBR	DESIGN TRAFFIC
MRV	-----	___ESA

#### FLEXIBLE PAVEMENT DESIGN

- DESIGN LIFE 20 YEARS

DESIGN VEHICLE	DESIGN CBR	DESIGN TRAFFIC
MRV	-----	___ESA

### STORMWATER DRAINAGE

- STORMWATER DRAINAGE SHALL BE GENERALLY IN ACCORDANCE WITH CURRENT AUSTRALIAN STANDARDS AND COUNCIL'S SPECIFICATION.
- PIPES OF 225mm DIA. AND UNDER SHALL BE UPVC.
- PIPES OF 300mm DIA. AND LARGER SHALL BE FRC OR CONCRETE CLASS 2 RUBBER RING JOINTED UNO.
- ALL FRC OR RCP STORMWATER PIPES WITHIN ROAD RESERVE AREAS TO BE CLASS 3 U.N.O.
- PIPES SHALL GENERALLY BE LAID AT THE GRADES INDICATED ON THE DRAWINGS.
- MINIMUM COVER TO PIPES 300mm DIA. AND OVER GENERALLY SHALL BE 600mm IN CARPARK & ROADWAY AREAS UNO.
- PIPES UP TO 150mm DIA SHALL BE LAID AT 1.0% MIN. GRADE U.N.O.
- PIPES 225mm DIA AND OVER SHALL BE LAID AT 0.5% MIN. GRADE U.N.O.
- BACKFILL TRENCHES WITH APPROVED FILL COMPACTED IN 200mm LAYERS TO 98% OF STANDARD DENSITY.
- ANY PIPES OVER 16% GRADE SHALL HAVE CONCRETE BULKHEADS AT ALL JOINTS.
- PITS SHALL BE AS DETAILED WITH METAL GRATES AT LEVELS INDICATED. ALL PITS DEEPER THAN 1000mm TO HAVE CLIMB IRONS.
- BUILD INTO UPSTREAM FACE OF ALL PITS A 3.0m SUBSOIL LINE FALLING TO PITS TO MATCH PIT INVERTS.
- ALL COURTYARD & LANDSCAPED PITS TO BE 450 SQUARE. LOAD CLASS A, UNLESS NOTED OTHERWISE.
- ALL DRIVEWAY & OSD PITS TO BE 600 SQUARE. LOAD CLASS D, UNLESS NOTED OTHERWISE.
- INSTALL TEMPORARY SEDIMENT BARRIERS TO INLET PITS, TO COUNCIL'S STANDARDS UNTIL SURROUNDING AREAS ARE PAVED OR GRASSED.
- PITS & DOWNPIPE LOCATIONS AND LEVELS MAY BE VARIED TO SUIT SITE CONDITIONS AFTER CONSULTING THE ENGINEER.
- DOWNPIPES SHOWN ARE INDICATIVE ONLY. ALL ROOF GUTTERING AND DOWNPIPES TO THE CURRENT AUSTRALIAN STANDARDS.
- ALL PLANTER BOXES AND BALCONIES TO BE CONNECTED TO THE PROPOSED STORMWATER DRAINAGE LINE.
- HAND-EXCAVATE STORMWATER PIPES IN VICINITY OF TREE ROOTS.
- FOOTPATH CROSSING LEVELS SHOWN ARE TO BE ADJUSTED TO FINAL COUNCIL'S ISSUED LEVELS.
- GEOTEXTILE FABRIC TO BE PLACED UNDER RIP RAP SCOUR PROTECTION.
- ALL BASES OF PITS TO BE BENCHMARKED TO HALF PIPE DEPTH AND PROVIDE GALVANISED ANGLE SURROUNDINGS TO GRATE.
- SUBSOIL LINE:
  - PIPES AND FITTINGS SHALL BE PERFORATED PLASTIC TO CURRENT AUSTRALIAN STANDARDS, LAY PIPES ON FLOOR OF TRENCH GRADED AT 1% MIN. AND OVERLAY WITH FILTER MATERIAL EXTENDING TO WITHIN 200mm OF SURFACE. PROVIDE FILTER FABRIC OF PERMEABLE POLYPROPYLENE BETWEEN FILTER MATERIAL AND TOPSOIL. PROVIDE FLUSHING EYES AT HIGH POINTS OR TO COUNCILS REQUIREMENTS.
- SHOULD THE CONTRACTOR ELECT TO INSTALL PRECAST STORMWATER PITS AND THEY ARE PERMITTED BY COUNCIL AND THE CLIENT, THE PRECAST PITS ARE TO BE CONSTRUCTED IN ACCORDANCE WITH RMS STANDARDS INCLUDING:
  - SEAL THE SEGMENTS TOGETHER USING A SITE-APPROVED NON-SHRINK GROUT OR MASTIC-TYPE PRODUCT. APPLY THE SEALANT IN ACCORDANCE WITH THE PRODUCT MANUFACTURER'S REQUIREMENTS.
  - ENSURE THAT NO GAPS REMAIN AND THAT A SMOOTH FACE EXISTS BETWEEN MULTIPLE UNITS.
  - LEAVE THE SEGMENTS UNDISTURBED UNTIL THE PERIOD OF CURING IS COMPLETED IN ACCORDANCE WITH THE GROUT OR SEALANT PRODUCT MANUFACTURER'S REQUIREMENTS.

### DRAINAGE INSTALLATION

#### RCP CONVENTIONAL INSTALLATIONS & ROAD CROSSINGS

- SUPPLY & INSTALLATION OF DRAINAGE WORKS TO BE IN ACCORDANCE WITH THESE DRAWINGS, THE COUNCIL SPECIFICATION AND THE CURRENT APPLICABLE AUSTRALIAN STANDARDS.
- BEDDING OF THE PIPELINES IS TO BE TYPE 'HS2' IN ACCORDANCE WITH THE STANDARDS AND AS FOLLOWS:
  - COMPACTED GRANULAR MATERIAL IS TO COMPLY WITH THE FOLLOWING GRADINGS:

SIEVE SIZE (mm)	19	2.36	0.60	0.30	0.15	0.075
% MASS PASSING	100	50-100	20-90	10-60	0-25	0-10

- AND THE MATERIAL PASSING THE 0.075 SIEVE HAVING LOW PLASTICITY AS DESCRIBED IN APPENDIX D OF AS1726.

- BEDDING DEPTH UNDER THE PIPE TO BE 100mm.
- BEDDING MATERIAL TO BE EXTENDED FROM THE TOP OF THE BEDDING ZONE UP TO 0.3 TIMES PIPE OUTSIDE DIAMETER. THIS REPRESENTS THE 'HAUNCH ZONE'.
- THE BEDDING & HAUNCH ZONE MATERIAL IS TO BE COMPACTED TO A MINIMUM RELATIVE COMPACTION OF 98% WITHIN ROAD RESERVES AND TRAFFICABLE AREAS AND 95% ELSEWHERE FOR COHESIVE MATERIAL OR A MINIMUM DENSITY INDEX OF 70% IN ACCORDANCE WITH THE STANDARDS FOR COHESIONLESS MATERIAL.
- COMPACTION TESTING SHALL BE CARRIED OUT BY AN APPROVED ORGANISATION WITH A NATA CERTIFIED LABORATORY FOR ALL DRAINAGE LINES LAID WHOLLY OR IN PART UNDER THE KERB & GUTTER OR PAVEMENT.
- BACKFILL SHALL BE PLACED & COMPACTED IN ACCORDANCE WITH THE SPECIFICATION. A GRANULAR GRAVEL AGGREGATE MATERIAL (<10mm) BACKFILL IS RECOMMENDED FOR THE BEDDING, HAUNCH SUPPORT AND SIDE ZONE DUE TO ITS SELF COMPACTING ABILITY.
- A MINIMUM OF 150mm CLEARANCE IS TO BE PROVIDED BETWEEN THE OUTSIDE OF THE PIPE BARREL AND THE TRENCH WALL FOR PIPES < 600 DIA. 200mm CLEARANCE FOR PIPES 600 TO 1200 DIA AND D/6 CLEARANCE FOR PIPES > 1200 DIA.

### SAFETY IN DESIGN

- THERE ARE INHERENT RISKS WITH CONSTRUCTING, MAINTAINING, OPERATING, DEMOLISHING, DISMANTLING AND DISPOSING THIS DESIGN THAT ARE TYPICAL OF SIMILAR DESIGNS. AS FAR AS IS REASONABLY PRACTICABLE RISKS HAVE BEEN ELIMINATED OR MINIMISED THROUGH THE DESIGN PROCESS. HAZARD CONTROLS MUST STILL BE IMPLEMENTED BY THE CONTRACTOR, OWNER OR OPERATOR TO ENSURE THE SAFETY OF WORKERS.
- JN'S ASSESSMENT DID NOT IDENTIFY ANY UNIQUE RISKS ASSOCIATED WITH THE DESIGN.

### PAVEMENT - FLEXIBLE

- THE PAVEMENT DESIGN AS DETAILED ASSUMES A PROPERLY PREPARED UNIFORM AND STABLE

- SUBGRADE. CONFIRMATION OF DESIGN CBR RATIO IS REQUIRED BY A GEOTECHNICAL ENGINEER PRIOR TO WORKS COMMENCING.
- ASSUMED DESIGN CBR TO BE CONFIRMED ONSITE DURING CONSTRUCTION PRIOR TO PLACEMENT OF PAVEMENT MATERIALS. THE CONTRACTOR IS TO UNDERTAKE SUFFICIENT CBR TESTING TO CONFIRM THE ASSUMED VALUE. WHERE LESSER VALUE HAS BEEN DETERMINED, THE SUPERVISING ENGINEER IS TO BE NOTIFIED TO DETERMINE A REVISED PAVEMENT DESIGN.
  - PAVEMENT TO BE CONSTRUCTED AS FOLLOWS:
    - SURFACE COURSE - DENSE GRADED ASPHALT
    - PRIMERSEAL - EMULSION BASED HOT BITUMEN
    - BASE COURSE - DGB 20
    - SUB BASE - DCS 40
  - SUBGRADE SHALL BE COMPACTED TO 100% STANDARD MAXIMUM DRY DENSITY RATIO AT OPTIMUM MOISTURE CONTENT  $\pm 2\%$  IN ACCORDANCE WITH CURRENT AUSTRALIAN STANDARDS.
  - SUBBASE COURSE SHALL BE COMPACTED TO 95% MODIFIED MAXIMUM DRY DENSITY.
  - BASECOURSE SHALL BE COMPACTED TO 98% MODIFIED MAXIMUM DRY DENSITY.
  - PRIOR TO THE PLACEMENT OF THE PRIMERSEAL AND AFTER THE REQUIRED DENSITY IS ACHIEVED, THE PAVEMENT IS TO BE ALLOWED TO DRY BACK TO APPROXIMATELY 60% TO 70% OPTIMUM MOISTURE CONTENT.
  - ALL SUBGRADES TO BE ROOF ROLLED & APPROVED BY SUPERVISING ENGINEER.
  - COMPACTION TESTS ARE TO BE UNDERTAKEN FOR ALL PAVEMENT LAYERS INCLUDING SUBGRADE AT A RATE TO BE DETERMINED BY THE SUPERVISING ENGINEER & THE RESULTS TO BE SUPPLIED TO THE ENGINEER PRIOR TO PLACEMENT OF THE NEXT PAVEMENT LAYER.

### PAVEMENT - RIGID

- PREPARATION FOR PAVEMENT: CLEAR SITE, STRIP TOPSOIL, CUT AND FILL AND PREPARATION OF SUBGRADE SHALL BE AS DESCRIBED IN 'EARTHWORKS' NOTES.
- SUBGRADE SHALL BE COMPACTED TO 98% STANDARD MAXIMUM DRY DENSITY AT OPTIMUM MOISTURE CONTENT  $\pm 2\%$  IN ACCORDANCE WITH AS 1289 5.1.1.
- BASE COURSE SHALL BE CONSTRUCTED FROM FINE CRUSHED ROCK DGB20 COMPACTED TO 100% STANDARD MAXIMUM DRY DENSITY AT OPTIMUM MOISTURE CONTENT  $\pm 2\%$  IN ACCORDANCE WITH AS 1289 5.1.1.
- CONCRETE PAVEMENT SLABS SHALL BE AS DETAILED ON THE DRAWINGS.
- ALL WORKMANSHIP AND MATERIALS FOR CONCRETE WORK SHALL BE IN ACCORDANCE WITH AS 3600 AND AS 3610 CURRENT EDITIONS WITH AMENDMENTS, EXCEPT WHERE VARIED BY THE CONTRACT DOCUMENTS.
- CONCRETE QUALITY ALL CEMENT SHALL BE TYPE SL SHRINKAGE LIMITED CEMENT IN ACCORDANCE WITH AS3972

ELEMENT	STRENGTH GRADE (MPa)	SLUMP	MAXIMUM AGGREG. SIZE (mm)
PAVEMENT	32	80	20

- PROJECT CONTROL TESTING SHALL BE CARRIED OUT IN ACCORDANCE WITH AS 3600.
- NO ADMIXTURES SHALL BE USED IN CONCRETE UNLESS APPROVED IN WRITING.
- CLEAR CONCRETE COVER TO ALL REINFORCEMENT FOR DURABILITY SHALL BE 40mm.
- CONSTRUCTION JOINTS WHERE NOT SHOWN SHALL BE LOCATED TO THE APPROVAL OF THE ENGINEER.
- THE FINISHED CONCRETE SHALL BE MECHANICALLY VIBRATED TO ACHIEVE A DENSE HOMOGENEOUS MASS. COMPLETELY FILLING THE FORMWORK THOROUGHLY BEDDING THE REINFORCEMENT AND FREE OF STONE POCKETS. CONCRETE SHALL BE COMPACTED WITH MECHANICAL VIBRATORS.
- CURING OF ALL CONCRETE IS TO BE ACHIEVED BY KEEPING SURFACES CONTINUOUSLY WET FOR A PERIOD OF THREE DAYS, AND THE PREVENTION OF LOSS OF MOISTURE FOR A TOTAL OF 7 DAYS FOLLOWED BY A GRADUAL DRYING OUT.
- REPAIRS TO CONCRETE SHALL NOT BE ATTEMPTED WITHOUT THE PERMISSION OF THE ENGINEER.

### ENVIRONMENTAL SITE MANAGEMENT

- EROSION & SEDIMENT CONTROLS TO BE INSTALLED IN ACCORDANCE WITH COUNCIL'S SPECIFICATION & THE NSW DEPARTMENT OF HOUSING 'BLUE BOOK' - SOILS AND CONSTRUCTION - MANAGING URBAN STORMWATER, 2004. REFER TO THE BLUE BOOK FOR STANDARD DRAWINGS 'SD'.
- SEDIMENT & EROSION CONTROLS MUST BE IN PLACE PRIOR TO THE COMMENCEMENT OF ANY EARTHWORKS OR DEMOLITION ACTIVITY. THE LOCATION OF SUCH DEVICES IS INDICATIVE ONLY AND FINAL POSITION SHOULD BE DETERMINED ON SITE.
- IT IS THE RESPONSIBILITY OF THE CONTRACTOR TO ENSURE THAT ALL MEASURES ARE TAKEN DURING THE COURSE OF CONSTRUCTION TO PREVENT SEDIMENT EROSION AND POLLUTION OF THE DOWNSTREAM SYSTEM. SUPERVISING ENGINEER SHOULD BE CONTACTED IF IN DOUBT. ALL SEDIMENT CONTROL STRUCTURES TO BE INSPECTED AFTER EACH RAINFALL EVENT FOR STRUCTURAL DAMAGE AND ALL TRAPPED SEDIMENT TO BE REMOVED TO A NOMINATED SOIL STOCKPILE SITE.
- RETAIN ALL EXISTING GRASS COVER WHEREVER POSSIBLE. A SEDIMENT FENCE TO BE PLACED DOWNHILL OF STOCKPILE.
- AREAS OF SITE REGRADING ARE TO BE COMPLETED PROGRESSIVELY DURING THE WORKS AND STABILISED AS EARLY AS POSSIBLE. THE SUPERVISING ENGINEER MAY DIRECT THE CONTRACTOR TO HAVE AREAS OF DISTURBANCE COMPLETED AND STABILISED DURING THE COURSE OF THE WORKS.
- INSTALL TEMPORARY SEDIMENT BARRIERS TO ALL INLET PITS LIKELY TO COLLECT SILT LADEN WATER. UNTIL SURROUNDING AREAS ARE PAVED OR REGRADED, GRAVEL OR GEOTEXTILE INLET FILTERS TO SD6-11 & SD6-12.
- NO SILT FENCES & BARRIERS ARE TO BE MAINTAINED IN GOOD ORDER & REGULARLY DESILTED DURING THE CONSTRUCTION PERIOD. SILT FENCES TO SD4-8 OR SD4-9.
- STOCKPILES OF LOOSE MATERIALS SUCH AS SAND, SOIL, GRAVEL MUST BE COVERED WITH GEOTEXTILE SILT FENCE MATERIAL. PLASTIC SHEETING OR MEMBRANE MUST NOT BE USED. SAFETY BARRICADING SHOULD BE USED TO ISOLATE STOCKPILES OF SOLID MATERIALS SUCH AS STEEL REINFORCING, FORMWORK AND SCAFFOLDING.
- WASTE MATERIALS ARE TO BE STOCKPILED OR LOADED INTO SKIP-BINS LOCATED ON SITE AS SHOWN ON PLAN.
- NO MORE THAN 150m OF TRENCHING TO BE OPEN AT ANY ONE TIME. IMMEDIATELY AFTER TRENCH BACKFILLING, PROVIDE SANDBAGS OR SAUSAGE FILTERS ACROSS EACH TRENCH AT MAXIMUM 20m SPACINGS. FILTERS TO REMAIN IN PLACE UNTIL REVEGETATION HAS OCCURRED.
- ALL VEHICLES LEAVING THE SITE MUST PASS OVER THE STABILISED SITE ACCESS BALLAST AREA (SIMILAR TO SD6-14) TO SHAKE OFF SITE CLAY AND SOIL. IF NECESSARY WHEELS AND AXLES ARE TO BE HOSED DOWN. BALLAST IS TO BE MAINTAINED & REPLACED AS NECESSARY DURING THE CONSTRUCTION PERIOD.
- THE HEAD CONTRACTOR IS TO INFORM ALL SITE STAFF AND SUB-CONTRACTORS OF THEIR OBLIGATIONS UNDER THE EROSION AND SEDIMENT CONTROL PLAN.
- ANY SEDIMENT DEPOSITED ON THE PUBLIC WAY, INCLUDING FOOTPATH RESERVE AND ROAD SURFACE, IS TO BE REMOVED IMMEDIATELY.
- PROVIDE BARRIERS AROUND ALL CONSTRUCTION WORKS WITHIN THE FOOTPATH AREA TO PROVIDE SAFE ACCESS FOR PEDESTRIANS.
- CONCRETE PUMPS AND CRANES ARE TO OPERATE FROM WITHIN THE BALLAST ENTRY DRIVEWAY AREA AND ARE NOT TO OPERATE FROM THE PUBLIC ROADWAY UNLESS SPECIFIC COUNCIL PERMISSION IS OBTAINED.
- DELIVERY VEHICLES MUST NOT STAND WITHIN THE PUBLIC ROADWAY.
- TRUCKS REMOVING EXCAVATED / DEMOLISHED MATERIAL SHOULD TRAVEL ON STABILISED CONSTRUCTION PATHS. MATERIAL TO BE TAKEN TO THE TRUCK TO REDUCE TRUCK MOVEMENT ON SITE. TRUCKS TO BE LIMITED TO TRUCK AND DOG HEAVY RIGID VEHICLES.
- ANY EXCAVATION WORK ADJACENT TO ADJOINING PROPERTIES OR THE PUBLIC ROADWAY IS NOT TO BE COMMENCED UNTIL THE STRUCTURAL ENGINEER IS CONSULTED AND SPECIFIC INSTRUCTIONS RECEIVED FROM THE ENGINEER.
- TOILET FACILITIES MUST BE EITHER A FLUSHING TYPE OR APPROVED PORTABLE CHEMICAL CLOSET. CHEMICAL CLOSETS ARE TO BE MAINTAINED & SERVICED ON A REGULAR BASIS SO THAT OFFENSIVE ODOUR IS NOT EMITTED.
- DURING TRENCH EXCAVATION ALL SPOIL SHALL BE MOUNDING ON THE UPHILL SIDE OF TRENCHES AND PLACEMENT IS TO COMPLY WITH THE SUPERINTENDENT'S REQUIREMENT.
- DIVERSION BANKS SHOULD BE CONSTRUCTED BY MOUNDING STRIPPED TOPSOIL (MIN HEIGHT 600mm) WHERE DIRECTED. MATERIAL TO BE RESPREAD ON FOOTWAYS AFTER FINAL TRIMMING.
- TRAFFIC MANAGEMENT MEASURES ARE REQUIRED TO BE IMPLEMENTED AND MAINTAINED DURING CONSTRUCTION. IN ACCORDANCE WITH R.T.A. TRAFFIC CONTROL AT WORK SITES - CURRENT EDITION' AND AS 1742 'MANUAL OF UNIFORM TRAFFIC CONTROL DEVICES.'
- PEDESTRIAN CONTROL MEASURES ARE REQUIRED TO BE IMPLEMENTED AND MAINTAINED DURING CONSTRUCTION. IN ACCORDANCE WITH AS 1742 'MANUAL OF UNIFORM TRAFFIC CONTROL DEVICES.'
- NUISANCE DUST TO BE KEPT TO A MINIMUM VIA THE USE OF A WATER CART AND SPRINKLER SYSTEM ON SITE.

NOT TO BE USED FOR CONSTRUCTION

AMDT	DATE	DESCRIPTION	BY
2	29.11.21	ISSUED FOR DA	DM
1	05.08.21	PRELIMINARY ISSUE	LAP

CLIENT

WINDANG KRUGER UNIT TRUST

STATUS

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DISCIPLINE

CIVIL DESIGN

DRAWING TITLE

GENERAL NOTES

PROJECT

PROPOSED SUBDIVISION

LOTS 429 AND 501

ADDRESS

KRUGER AVENUE, WINDANG

NSW, 2528

PROJECT DETAILS

DESIGN DM

DRAWN DM

DATE JUL 2021

DRG SIZE A1

SCALE AS SHOWN

PROJECT BA

MGR


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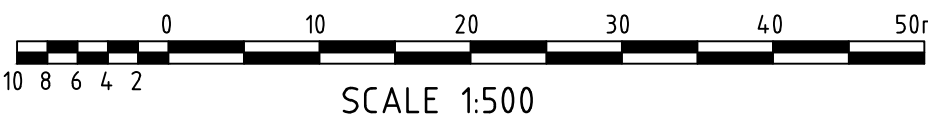
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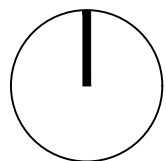


EROSION AND SEDIMENT CONTROL LEGEND	
SYMBOL	DESCRIPTION
	PROPRIETARY SILT FENCE
	PROVIDE TEMPORARY CHAIN WIRE FENCING (HOARDING) ALONG THE SITE BOUNDARY
	SANDBAG SEDIMENT TRAP
	DIRECTION OF FLOW
	TRUCK DIP
	TEMPORARY STABILISED CONSTRUCTION ENTRY/EXIT, (SHAKER PAD)
	SWALE DRAIN
	CRUSHED CONCRETE / ROAD BASE
	EXISTING SURVEY CONTOUR
	MAJOR DESIGN CONTOUR
	MINOR DESIGN CONTOUR
	STRAW BALE SEDIMENT FENCE

EROSION AND SEDIMENT CONTROL PLAN  
SCALE 1:500



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AMDT	DATE	DESCRIPTION	BY
2	29.11.21	ISSUED FOR DA	DM
1	05.08.21	PRELIMINARY ISSUE	LAP

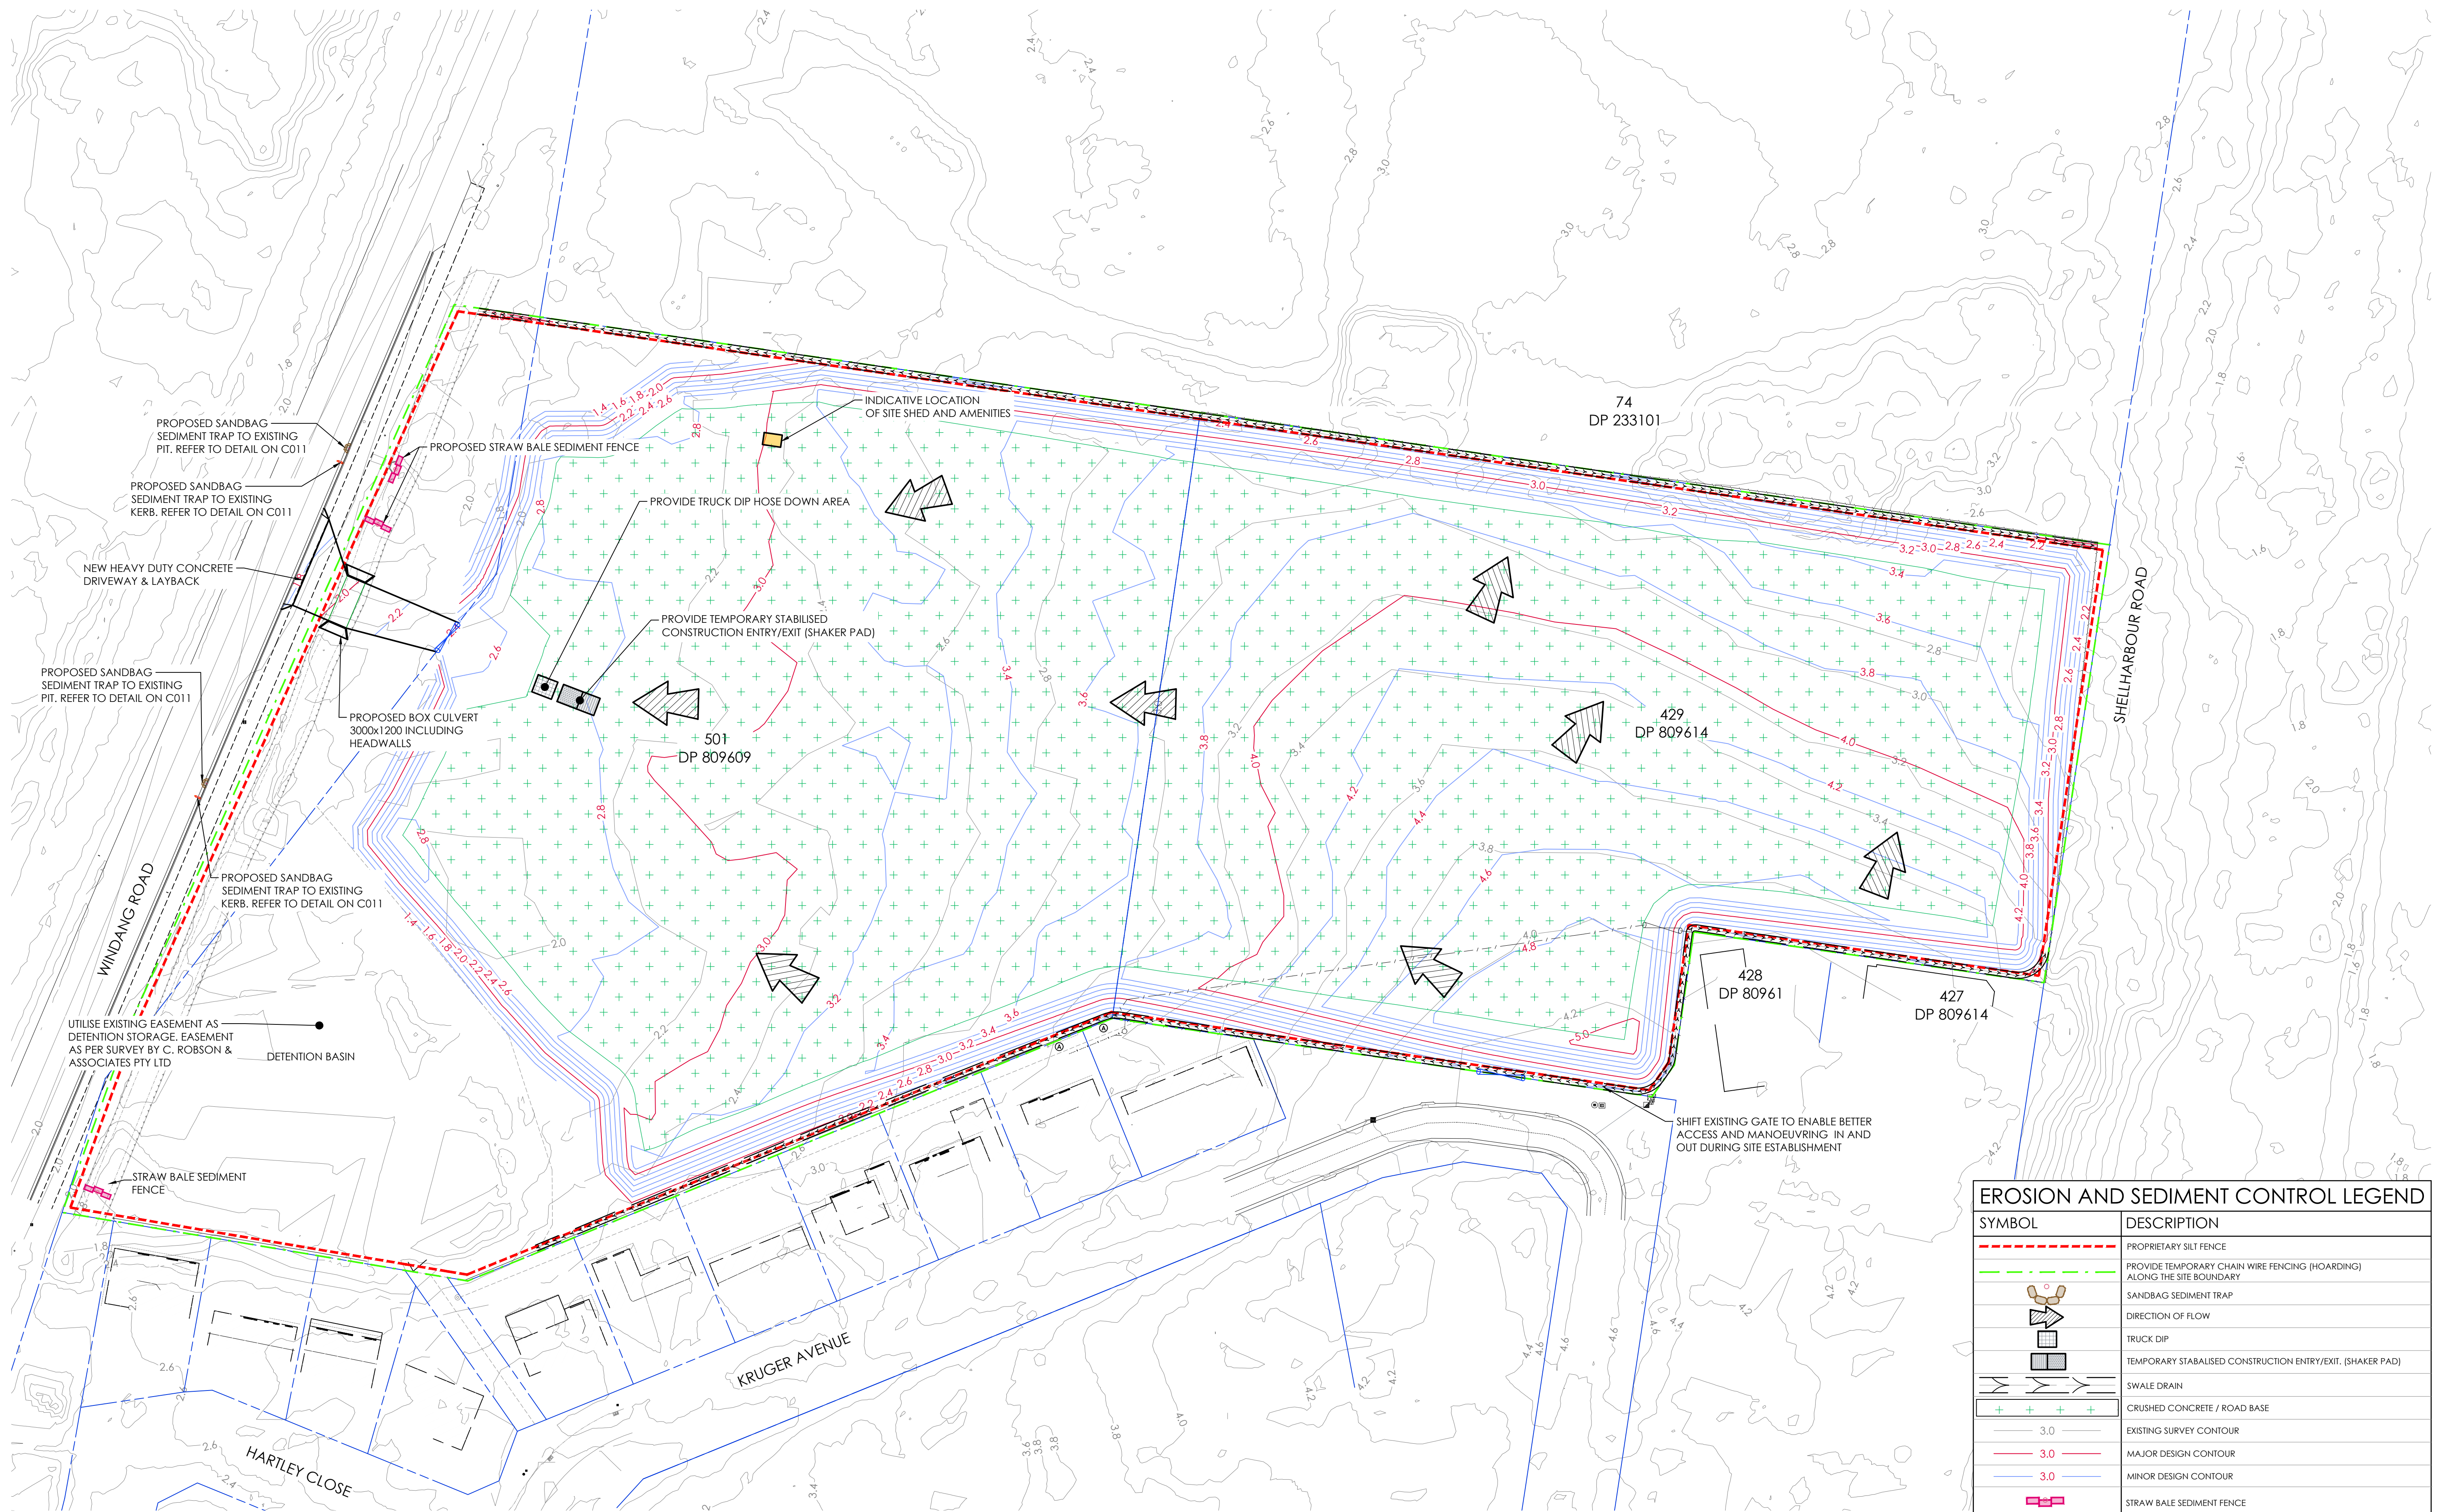





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WINDANG KRUGER UNIT TRUST  
STATUS  
PRELIMINARY DA ISSUE  
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DISCIPLINE  
CIVIL DESIGN  
DRAWING TITLE  
EROSION AND SEDIMENT CONTROL PLAN

PROJECT  
PROPOSED SUBDIVISION  
LOTS 429 AND 501  
ADDRESS  
KRUGER AVENUE, WINDANG  
NSW, 2528


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DESIGN DM  
DRAWN DM  
DATE JUL 2021  
DRG SIZE A1  
SCALE 1:500  
PROJECT BA  
MGR  
WWW.JN.COM.AU  
N0210053  
C010 2



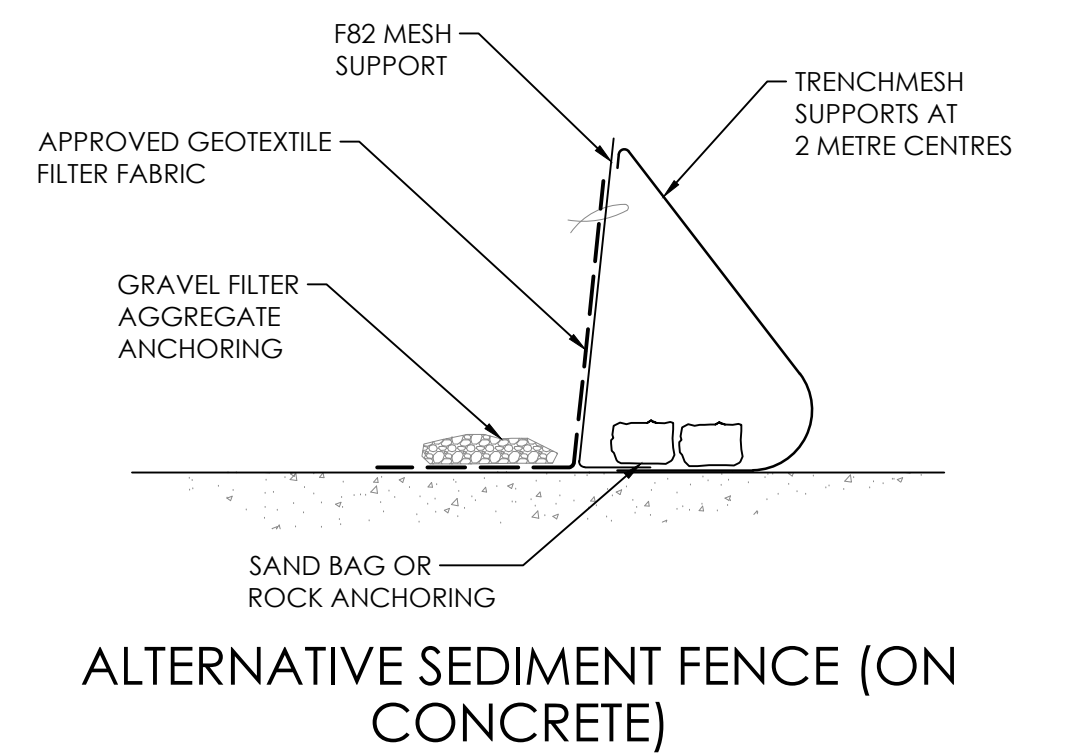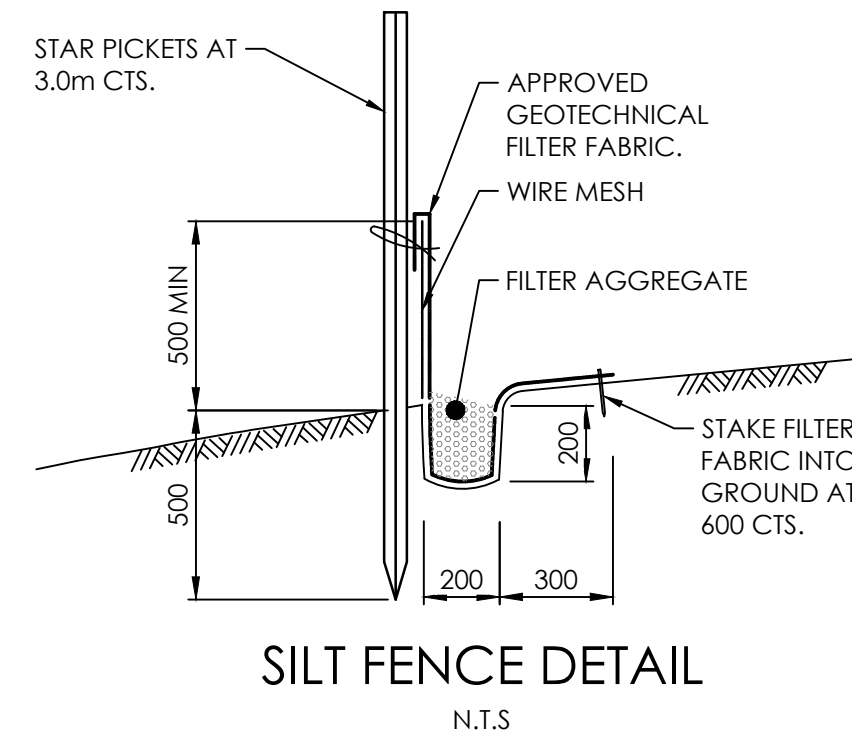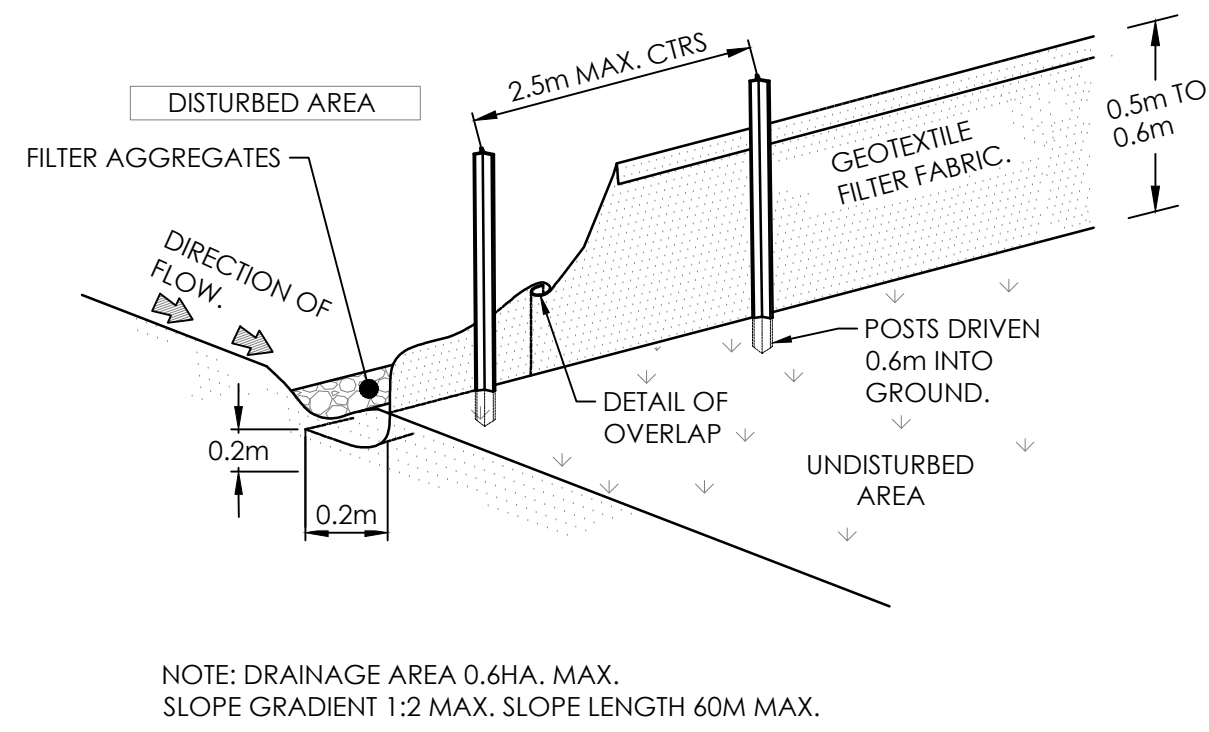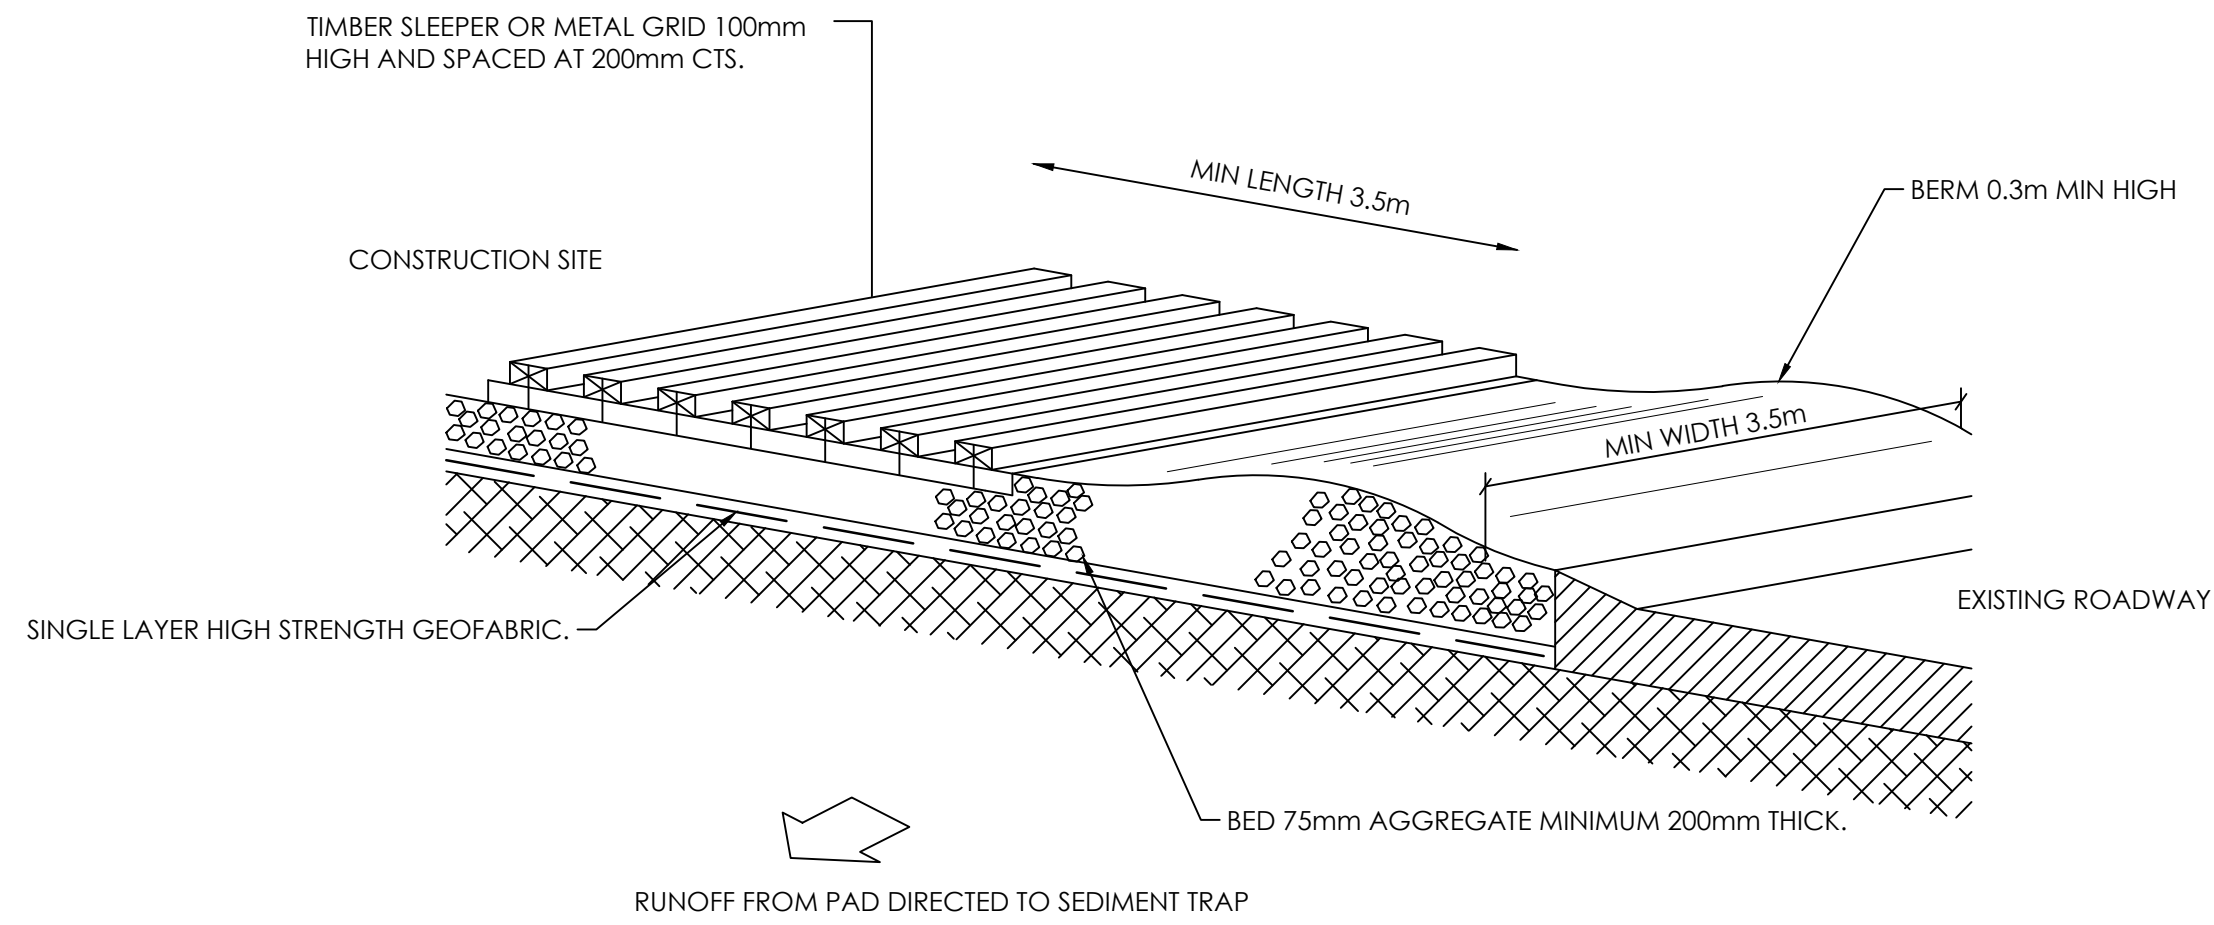



#### GENERAL CONSTRUCTION NOTES

1. CONSTRUCT SEDIMENT FENCE AS CLOSE AS POSSIBLE TO PARALLEL TO THE CONTOURS OF THE SITE.
2. DRIVE 1.5m LONG STAR PICKETS IN GROUND 3m APART.
3. DIG A 200mm DEEP TRENCH ALONG THE UPSLOPE LINE OF THE FENCE FOR THE FABRIC TO BE ENTRENCHED.
4. BACKFILL TRENCH OVER BASE OF FABRIC
5. FIX SELF-SUPPORTING GEOTEXTILE TO UPSLOPE SIDE OF POSTS WITH WIRE TIES OR AS RECOMMENDED BY GEOTEXTILE MANUFACTURER.
6. JOIN SECTIONS OF FABRIC AT A SUPPORT WITH A 150mm OVERLAP.

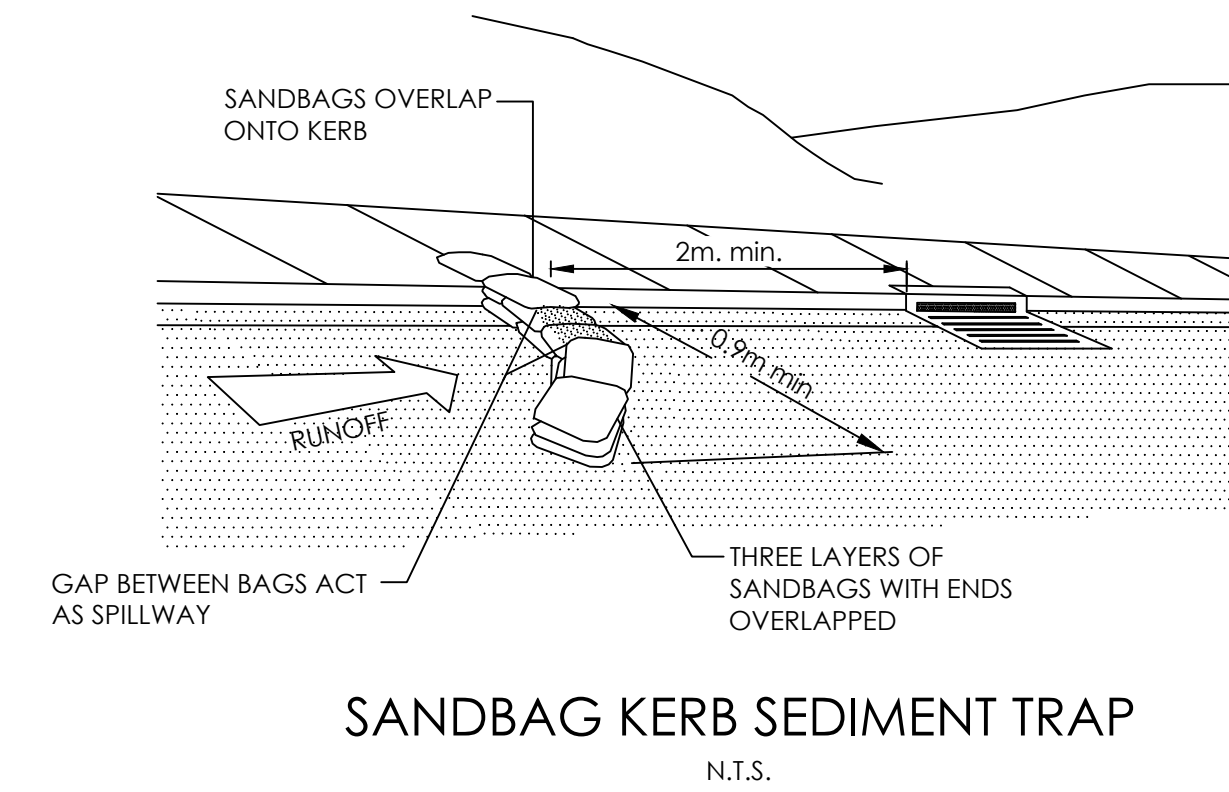

#### GENERAL CONSTRUCTION NOTES




1. CONSTRUCT SEDIMENT FENCE AS CLOSE AS POSSIBLE TO PARALLEL TO THE CONTOURS OF THE SITE.
2. FIX SELF-SUPPORTING GEOTEXTILE TO UPSLOPE SIDE OF POSTS WITH WIRE TIES OR AS RECOMMENDED BY GEOTEXTILE MANUFACTURER.
3. JOIN SECTIONS OF FABRIC AT A SUPPORT WITH A 150mm OVERLAP.

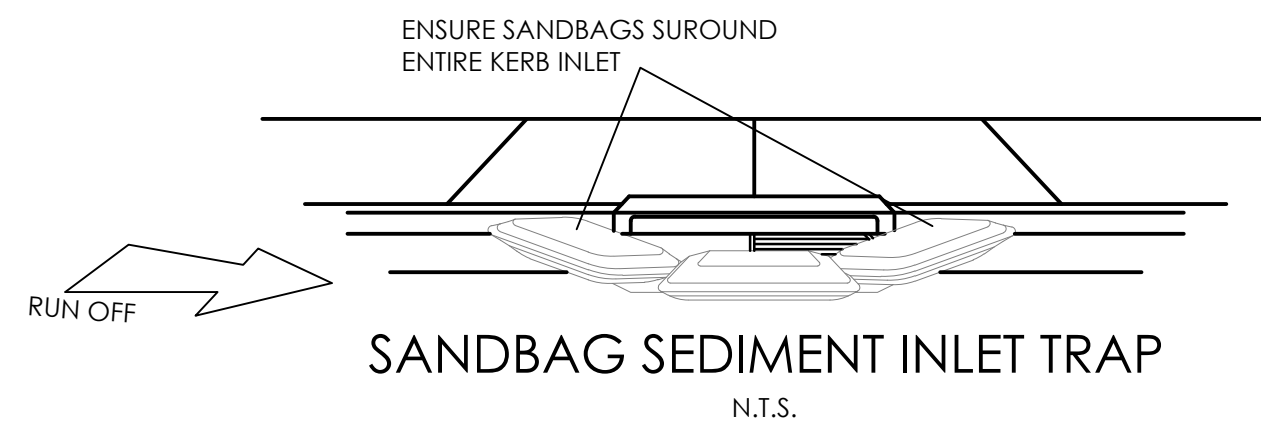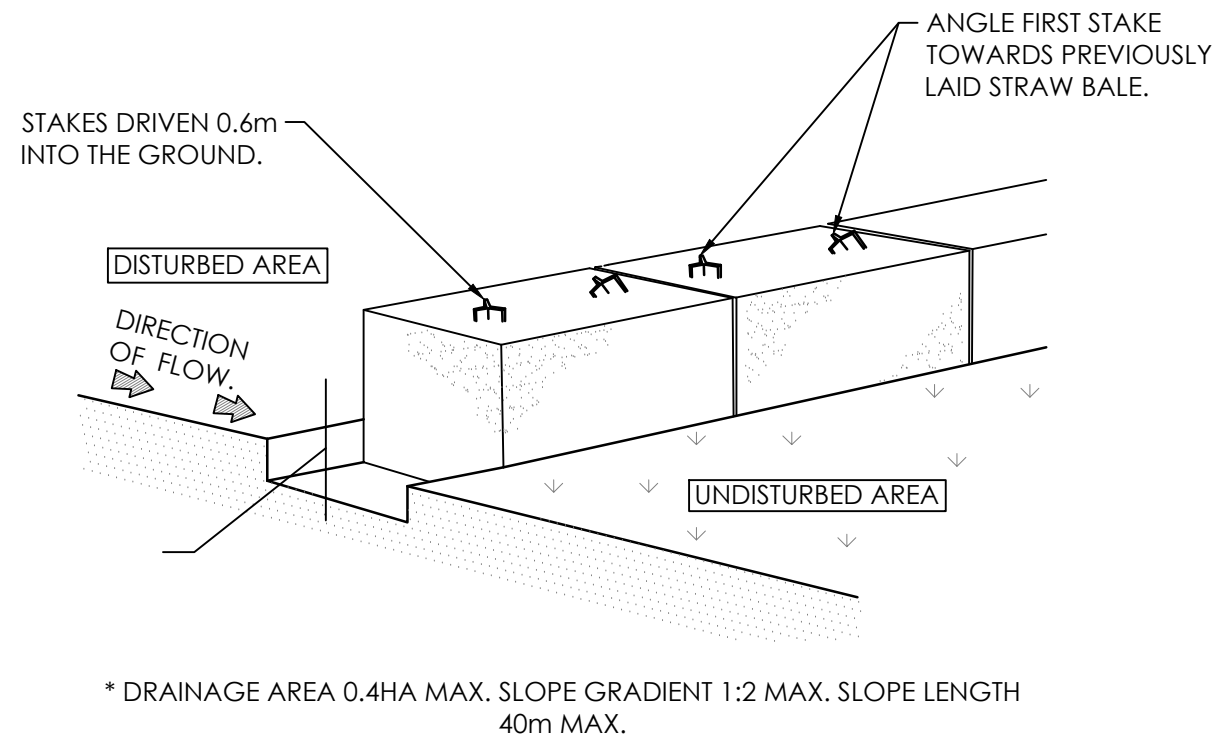

1. FABRICATE A SLEEVE MADE FROM GEOTEXTILE OR WIRE MESH LONGER THAN THE LENGTH OF THE INLET PIT.
2. FILL THE SLEEVE WITH 25mm TO 50mm GRAVEL.
3. FORM AN ELIPTICAL CROSS SECTION ABOUT 150mm HIGH X 400mm WIDE.
4. PLACE THE FILTER AT THE OPNEING OF THE KERB INLET LEAVING A 100MM GAP AT THE TOP TO ACT AS AN EMERGENCY SPILL WAY.
5. MAINTAIN A CLEAR DISTANCE AWAY FROM THE PIT WITH SPACER BLOCKS.
6. FORM A SEAL WITH THE KERBING AND PREVENT SEDIMENT BYPASSING THE FILTER.
7. FIT TO ALL KERB INLETS AS SHOWN.

#### STRAW BALE CONSTRUCTION NOTES

1. CONSTRUCT STRAW BALE FILTER AS CLOSE AS POSSIBLE TO PARALLEL TO THE CONTOURS OF THE SITE OR THE TOE OF A SLOPE.
2. PLACE BALES LENGTHWISE IN A ROW WITH ENDS TIGHTLY ABUTTING. USE STRAW TO FILL ANY GAPS BETWEEN BALES. STRAWS TO BE PLACED PARALLEL TO GROUND.
3. MAXIMUM HEIGHT OF FILTER IS ONE BALE.
4. ON SOFT MATERIALS EMBED EACH BALE IN THE GROUND 75mm TO 100mm AND ANCHOR WITH TWO 1.2m STAR PICKETS. ANGLE THE FIRST STAKE IN EACH BALE TOWARDS THE PREVIOUSLY LAID BALE. DRIVE STAKES 600mm INTO THE GROUND AND FLUSH WITH THE TOP OF THE BALES.
5. WHERE A STRAW BALE FILTER IS CONSTRUCTED DOWNSLOPE FROM A DISTURBED BATTER THE BALES SHOULD BE LOCATED 1.5 TO 2m DOWNSLOPE FROM THE TOE OF THE BATTER.
6. STRAW BALES TO BE WRAPPED IN APPROVED GEOTEXTILE FABRIC.

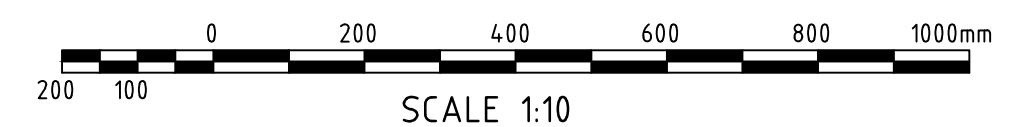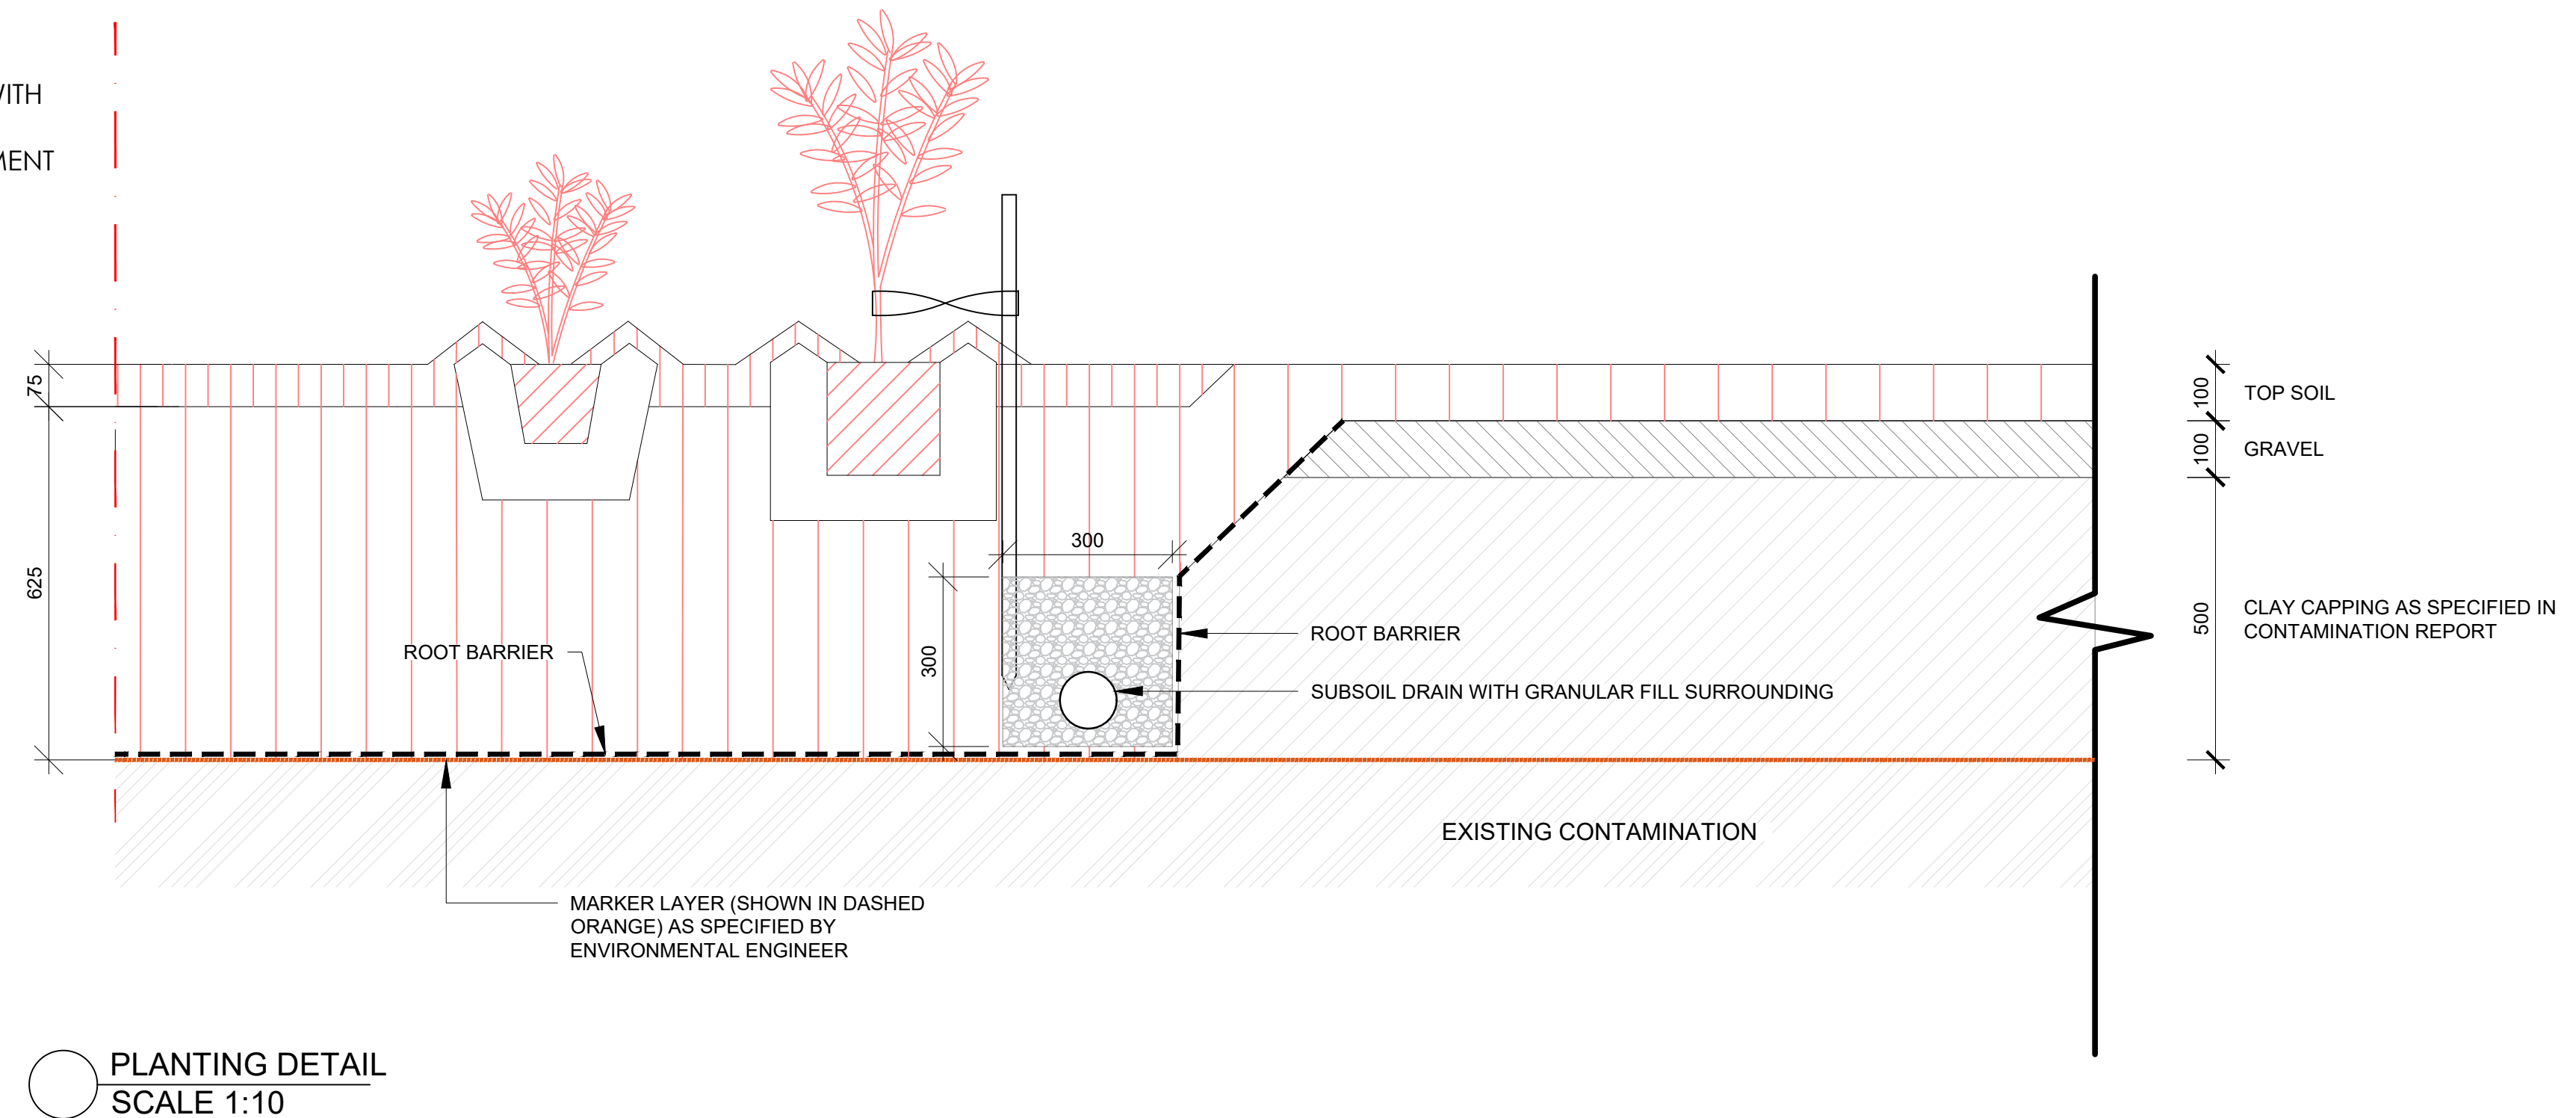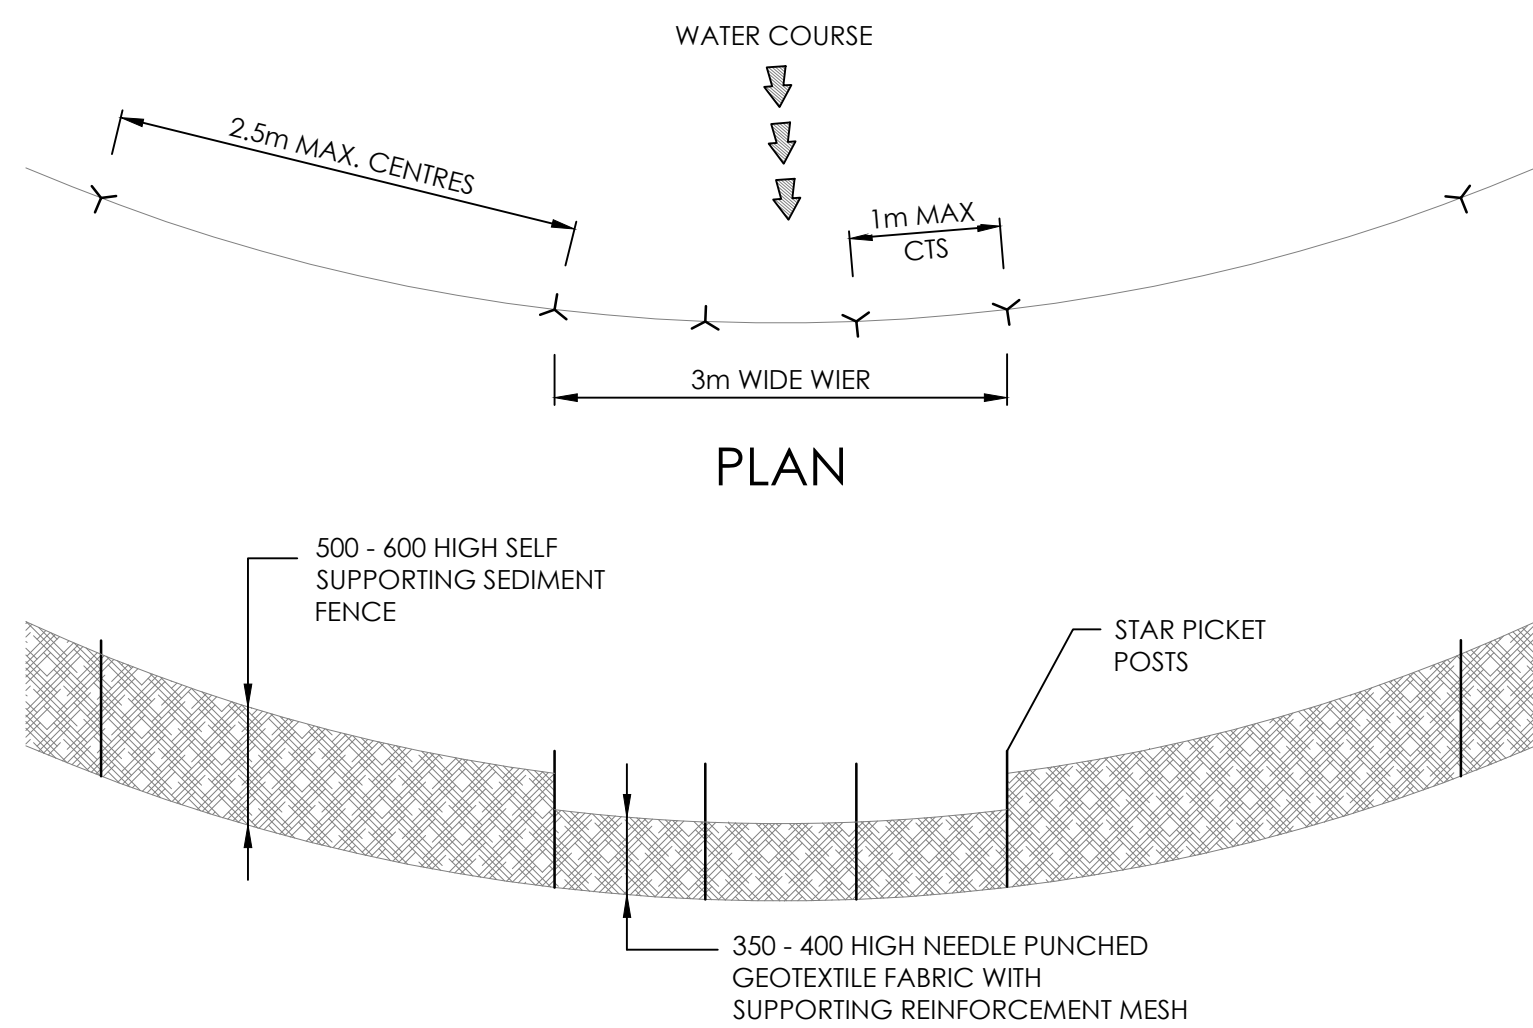

#### NOT TO BE USED FOR CONSTRUCTION

AMDT	DATE	DESCRIPTION	BY
3	09.12.21	RE-ISSUED FOR DA	DM
2	29.11.21	ISSUED FOR DA	DM
1	05.08.21	PRELIMINARY ISSUE	LAP



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WINDANG KRUGER UNIT TRUST  
STATUS  
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DISCIPLINE  
CIVIL DESIGN  
DRAWING TITLE  
EROSION AND SEDIMENT DETAILS

PROJECT  
PROPOSED SUBDIVISION  
LOTS 429 AND 501  
ADDRESS  
KRUGER AVENUE, WINDANG  
NSW, 2528

PROJECT DETAILS  
DESIGN DM  
DRAWN DM  
DATE JUL 2021  
DRG SIZE A1  
SCALE AS SHOWN  
PROJECT BA  
MGR  
WWW.JN.COM.AU  
N0210053  
C011 3



LEVELS TABLE		
MIN. LEVEL	MAX. LEVEL	COLOUR
-300	-1.0	
-1.0	-0.9	
-0.9	-0.8	
-0.8	-0.7	
-0.7	-0.6	
-0.6	-0.5	
-0.5	-0.4	
-0.4	-0.3	
-0.3	-0.2	
-0.2	-0.1	
-0.1	0	
0.0	0.1	
0.1	0.2	
0.2	0.3	
0.3	0.4	
0.4	0.5	
0.5	0.6	
0.6	0.7	
0.7	300	

VOLUMES

CUT VOLUME: -1,118.579m<sup>3</sup>  
FILL VOLUME: 16,565.371m<sup>3</sup>  
BALANCE: 15,446.792m<sup>3</sup> (FILL)




(C) EASEMENT FOR DRAINAGE AND DETENTION (D.P. 789855) DENSELY VEGETATED AREA CONTAINING MOSTLY DRY WATERCOURSE


HARTLEY CLOSE

CAPPING PLAN - BULK EARTHWORKS  
SCALE 1:500

CAPPING PLAN LEGEND	
SYMBOL	DESCRIPTION
	MAJOR DESIGN CONTOUR
	MINOR DESIGN CONTOUR

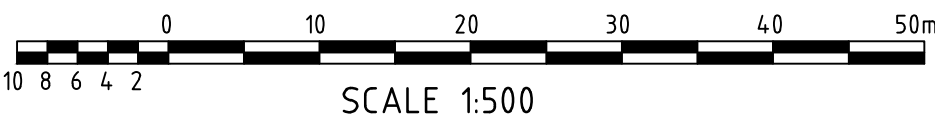

NOT TO BE USED FOR CONSTRUCTION			
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DISCIPLINE  
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DRAWING TITLE  
CAPPING PLAN  
BULK EARTHWORKS

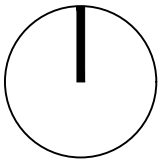PROJECT  
PROPOSED SUBDIVISION  
LOTS 429 AND 501  
ADDRESS  
KRUGER AVENUE, WINDANG  
NSW, 2528






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DESIGN DM  
DRAWN DM  
DATE JUL 2021  
DRG SIZE A1  
SCALE 1:500  
PROJECT BA  
MGR  
WWW.JN.COM.AU  
N0210053  
C100 2



LEGEND

DESIGN SURFACE

EXISTING SURFACE

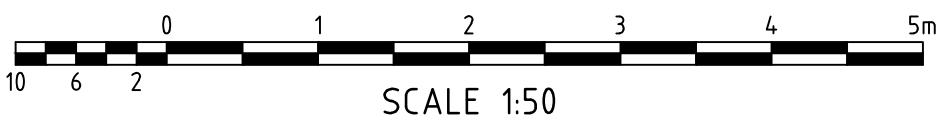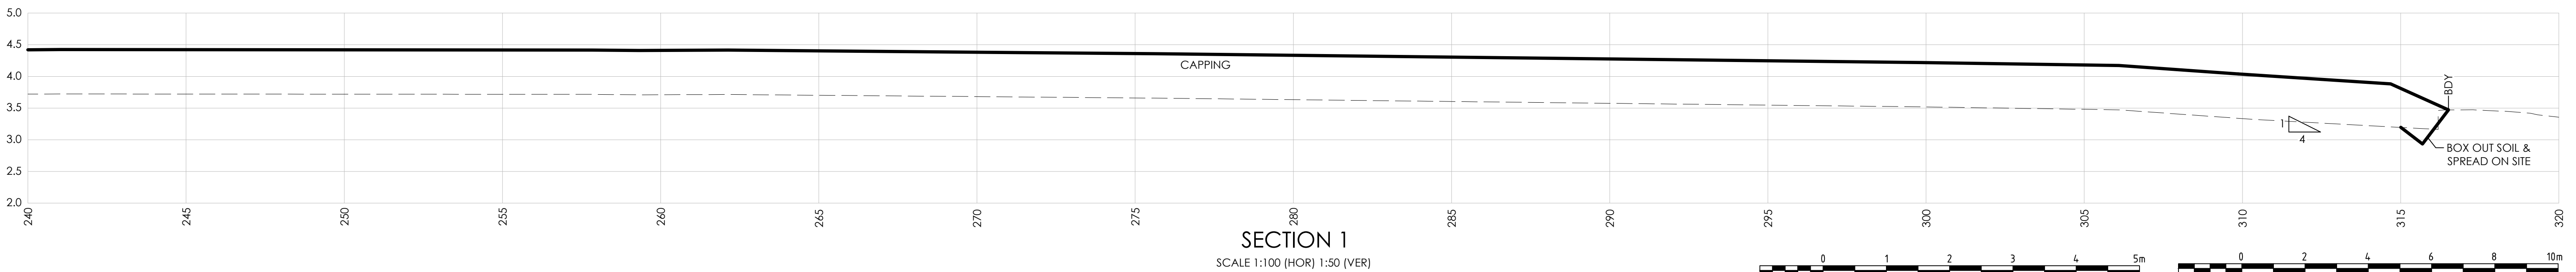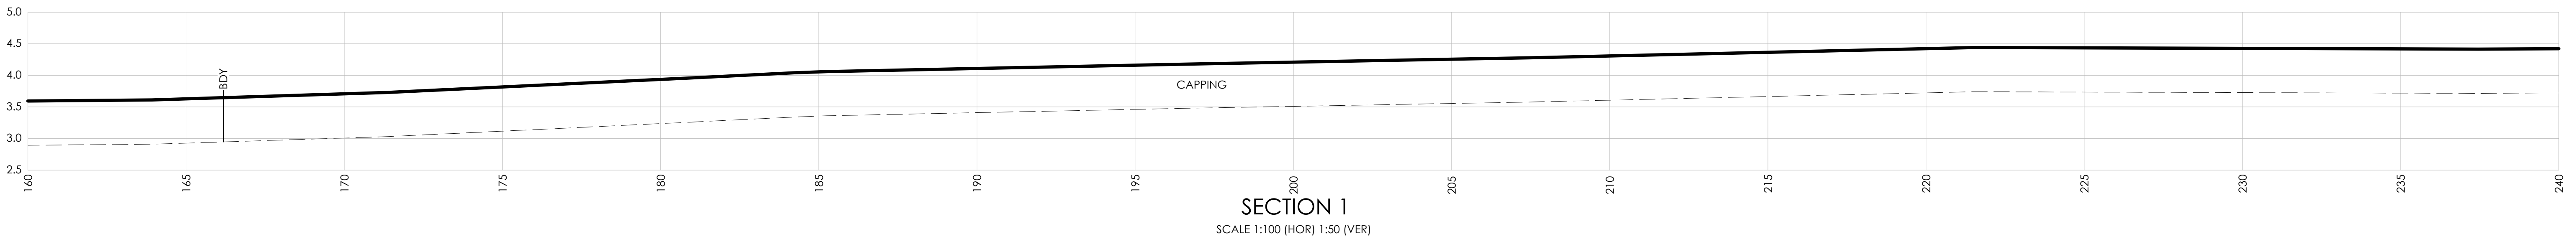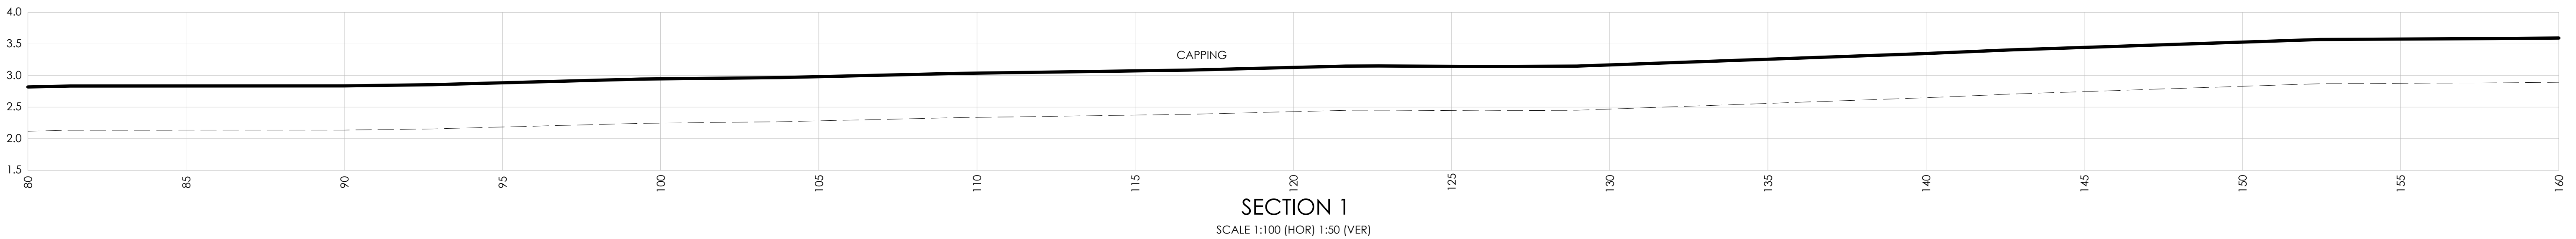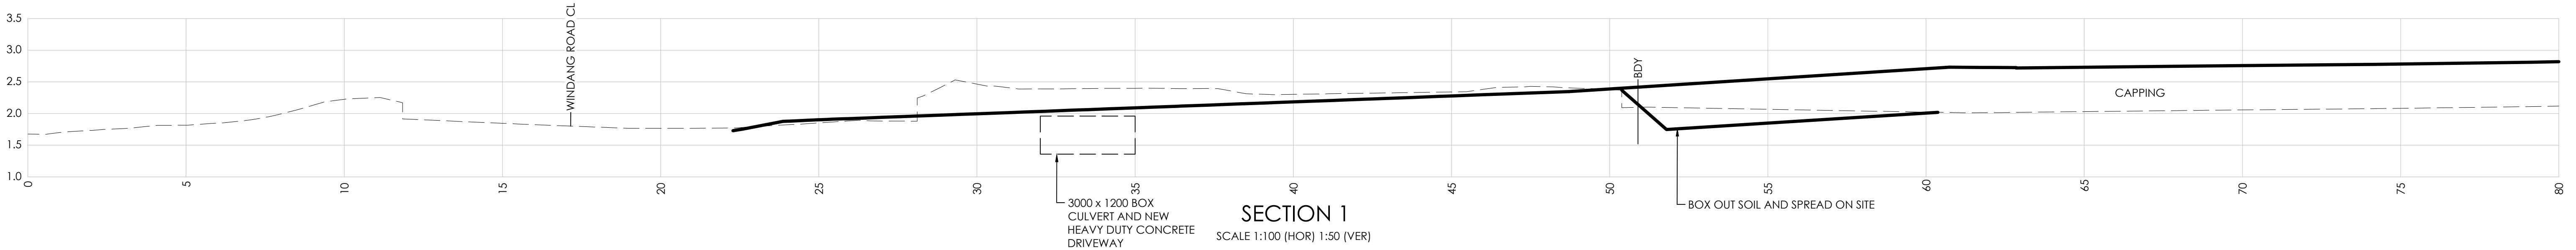

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

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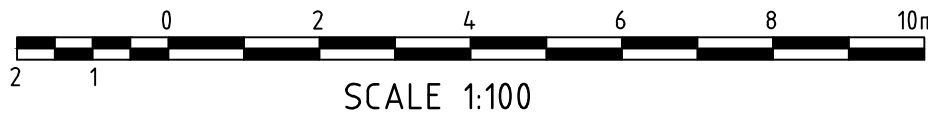
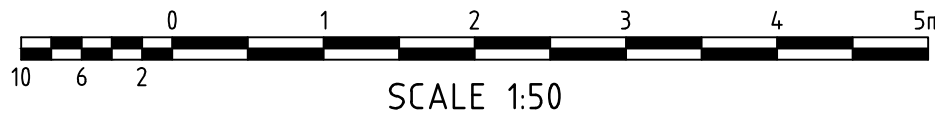
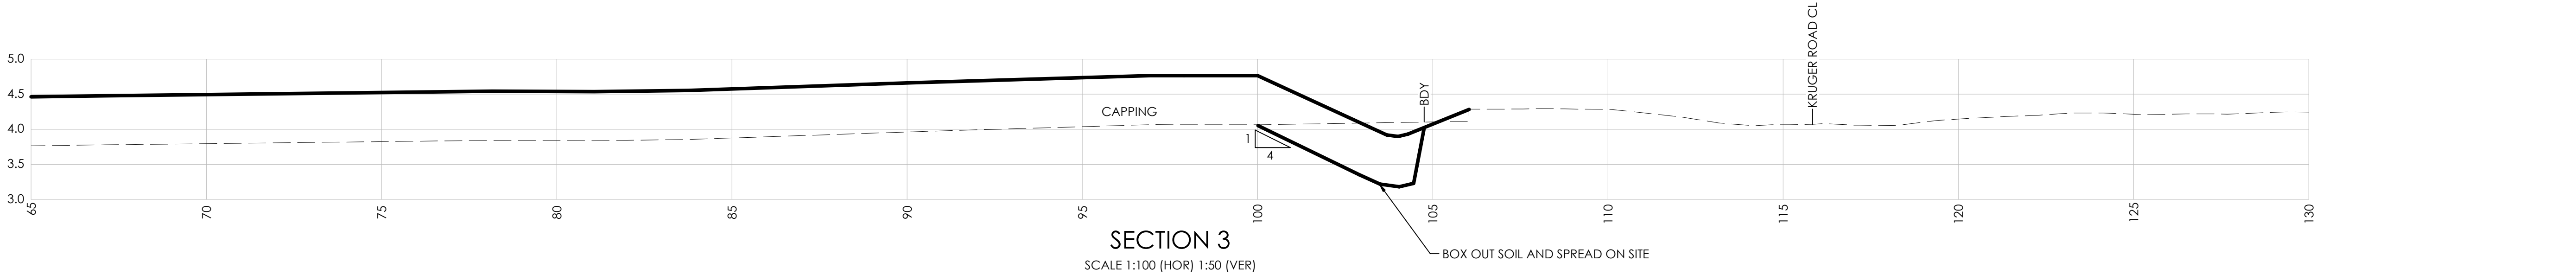
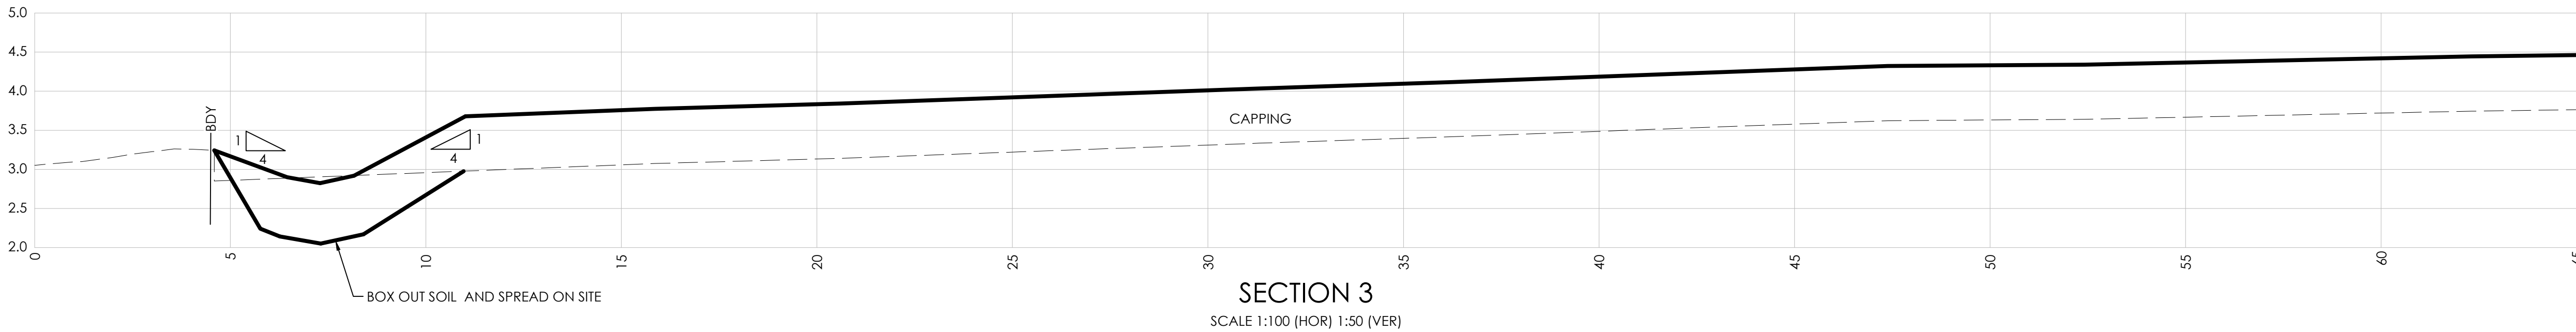
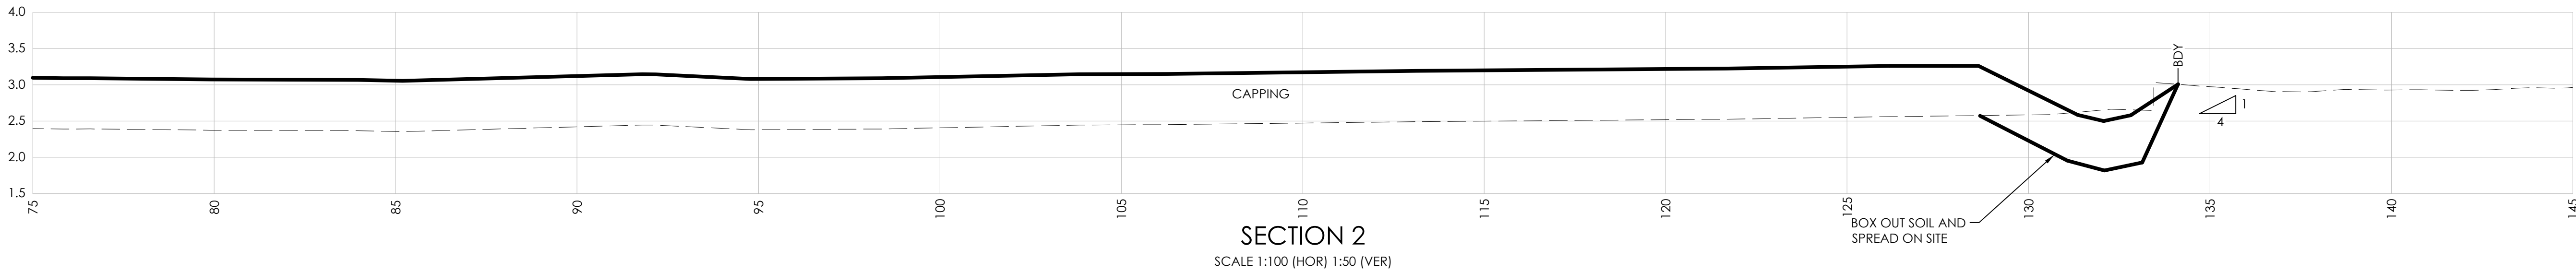
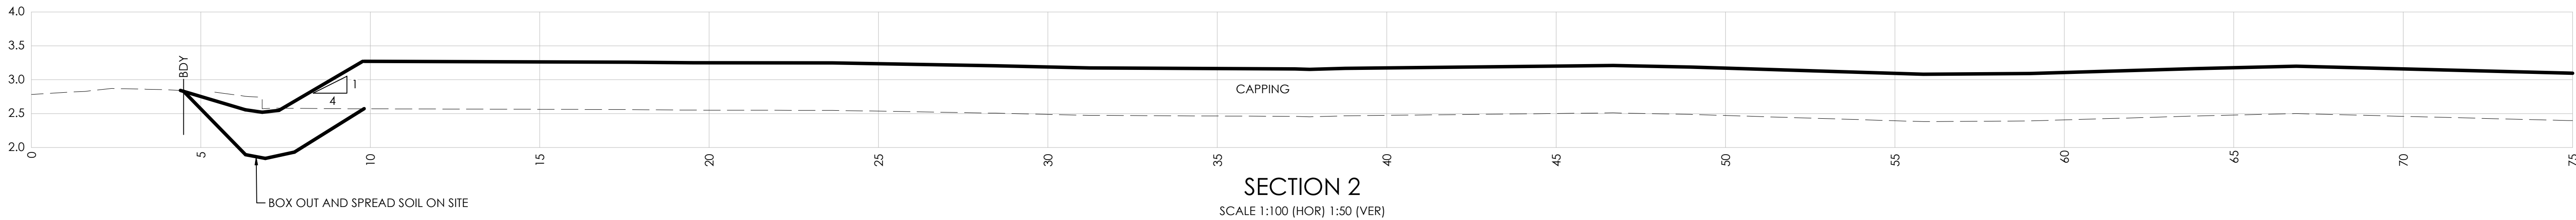
DRAWING TITLE  
CAPPING BULK EARTHWORKS  
SECTIONS - SHEET 1

PROJECT  
PROPOSED SUBDIVISION  
LOTS 429 AND 501  
ADDRESS  
KRUGER AVENUE, WINDANG  
NSW, 2528

PROJECT DETAILS  
DESIGN DM  
DRAWN DM  
DATE JUL 2021  
DRG SIZE A1  
SCALE AS SHOWN  
PROJECT BA  
MGR  
WWW.JN.COM.AU  
N0210053  
C101 2



LEGEND	
	DESIGN SURFACE
	EXISTING SURFACE



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

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WINDANG KRUGER UNIT TRUST  
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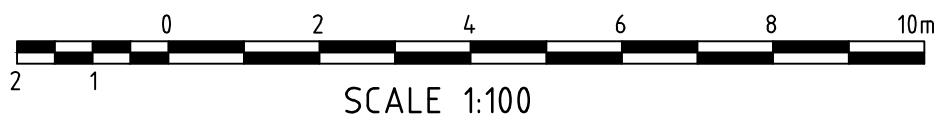
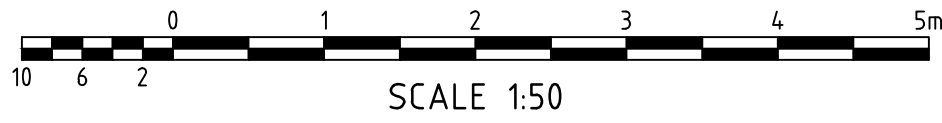
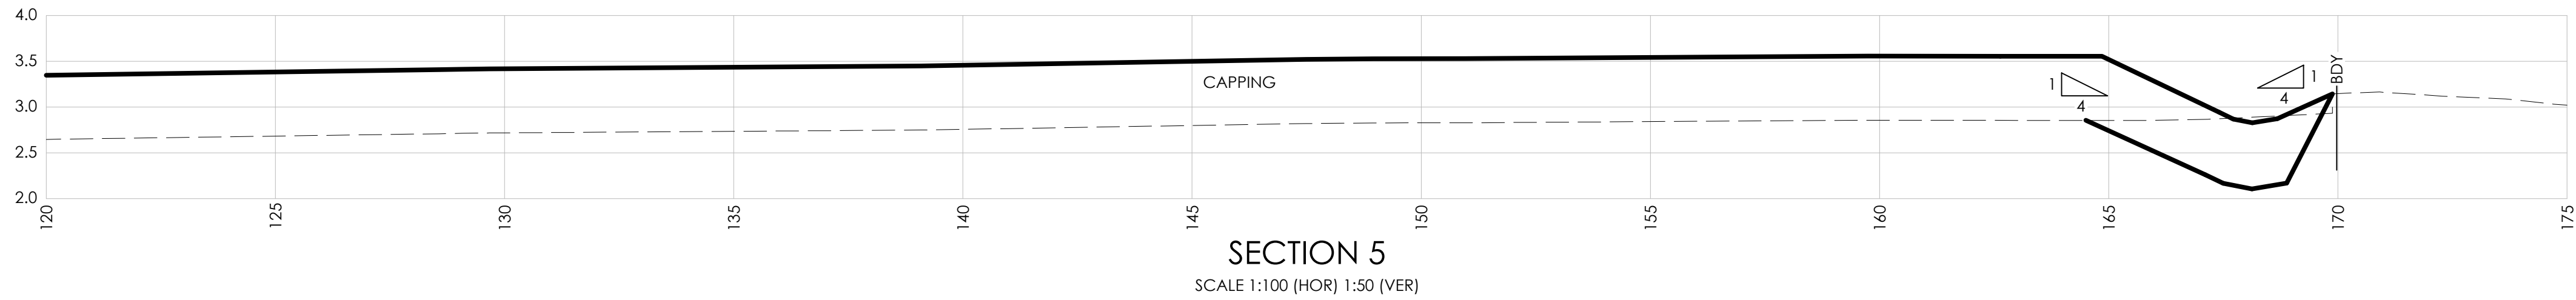
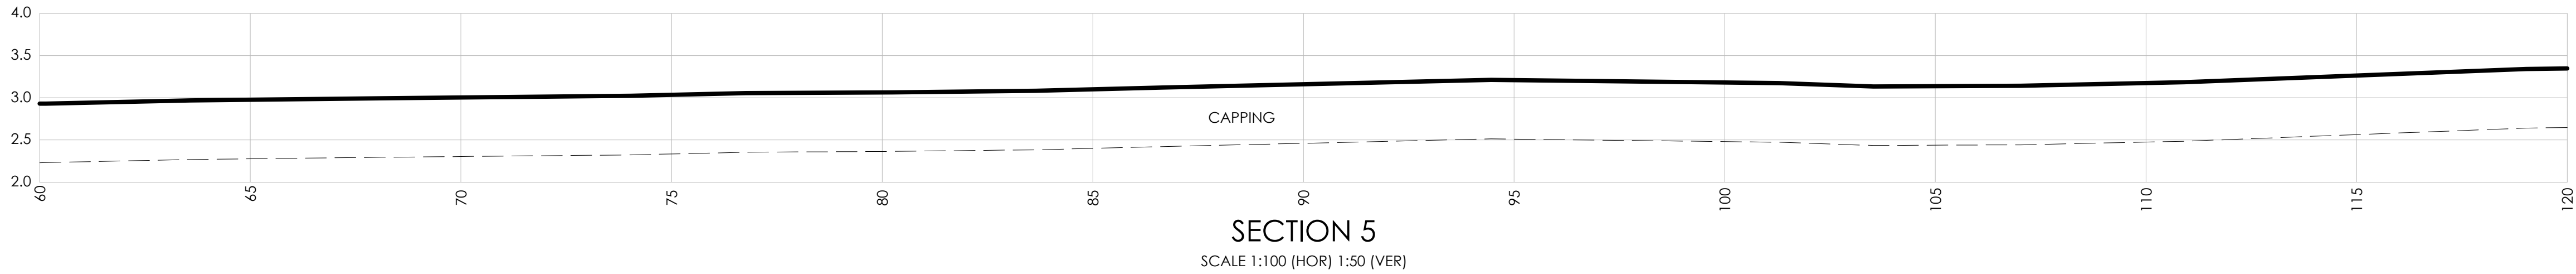
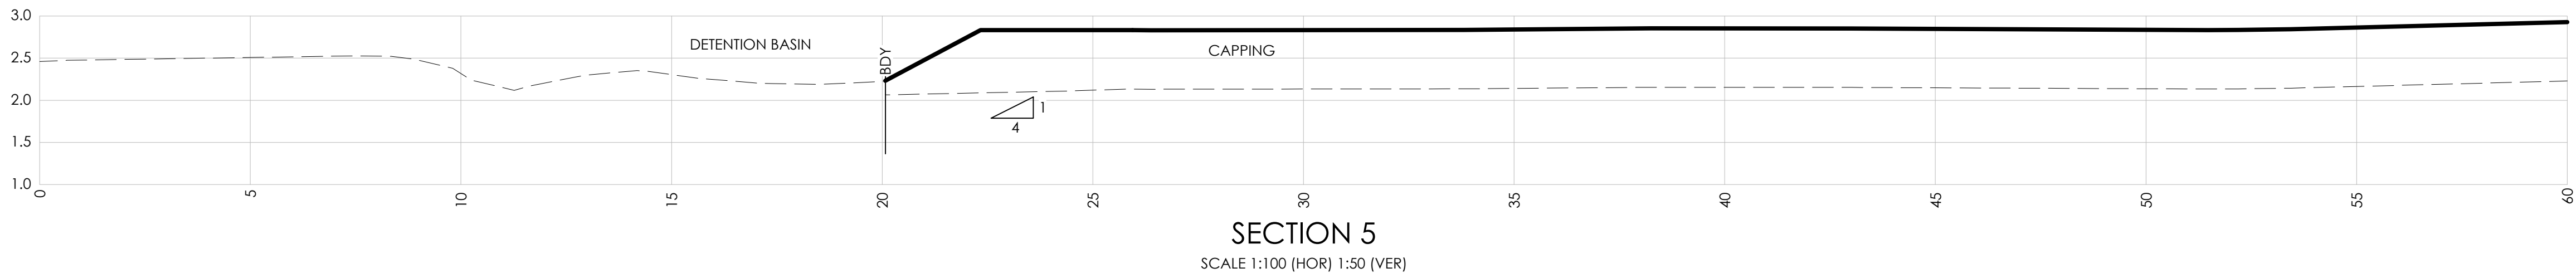
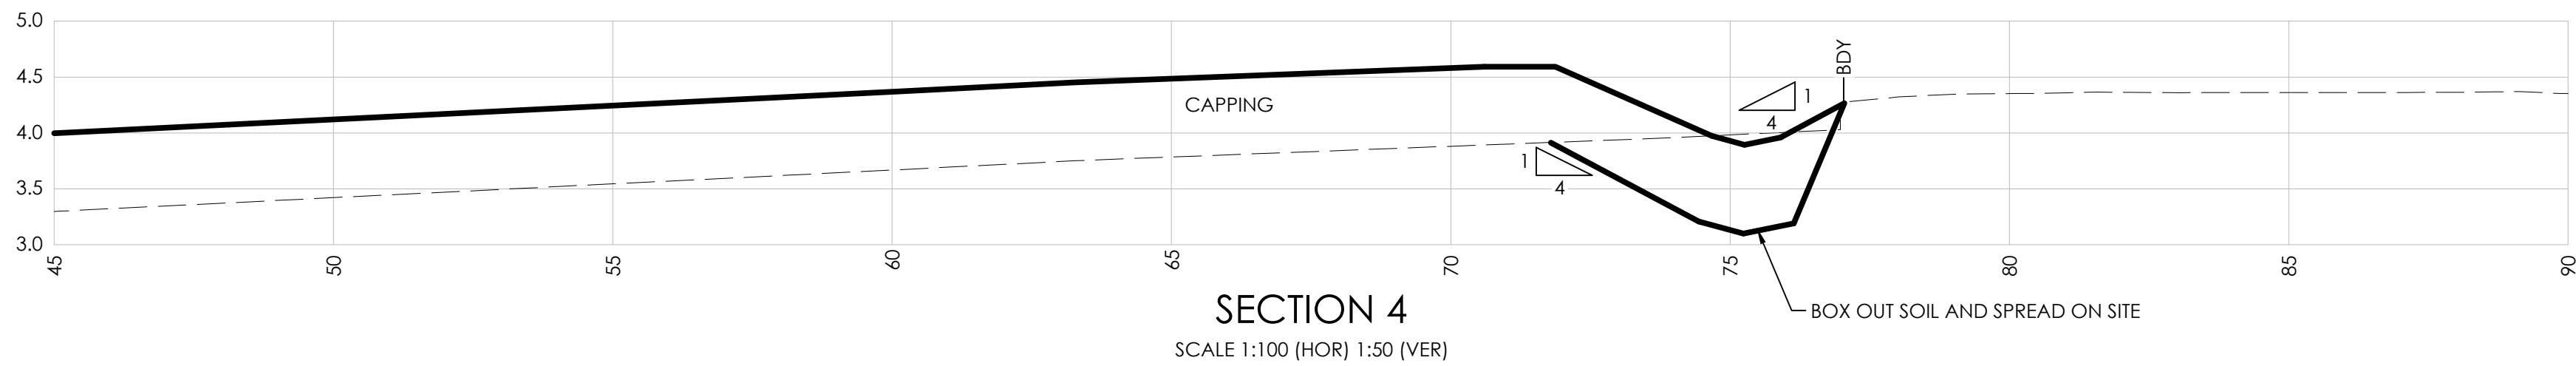
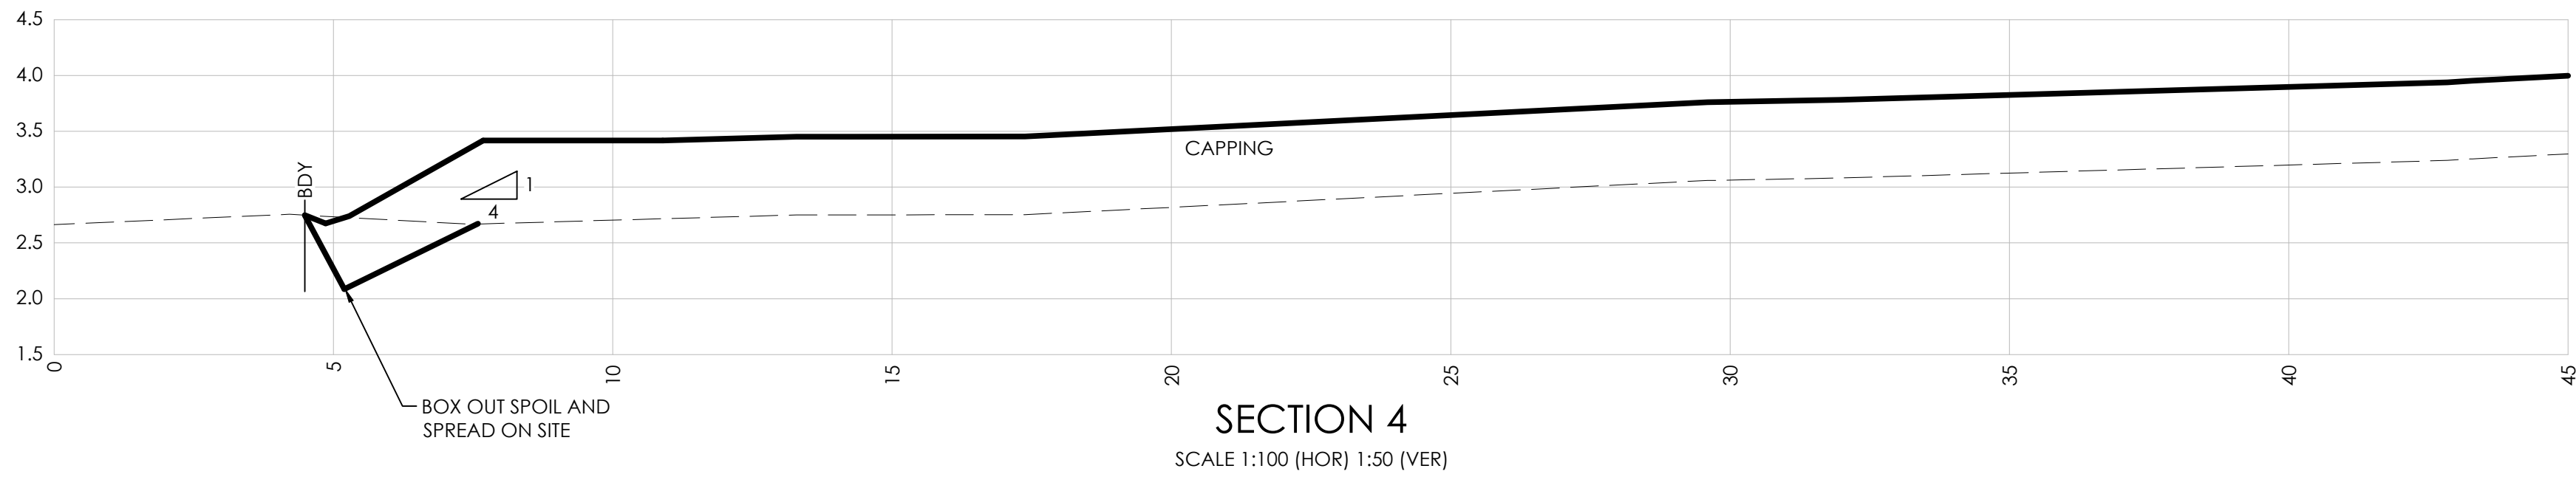
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PROJECT  
PROPOSED SUBDIVISION  
LOTS 429 AND 501  
ADDRESS  
KRUGER AVENUE, WINDANG  
NSW, 2528

PROJECT DETAILS  
DESIGN DM  
DRAWN DM  
DATE JUL 2021  
DRG SIZE A1  
SCALE AS SHOWN  
PROJECT BA  
MGR  
WWW.JN.COM.AU  
N0210053  
C102 2



LEGEND	
	DESIGN SURFACE
	EXISTING SURFACE



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DISCIPLINE  
CIVIL DESIGN

DRAWING TITLE  
CAPPING BULK EARTHWORKS  
SECTIONS - SHEET 3

PROJECT  
PROPOSED SUBDIVISION  
LOTS 429 AND 501  
ADDRESS  
KRUGER AVENUE, WINDANG  
NSW, 2528

PROJECT DETAILS  
DESIGN DM  
DRAWN DM  
DATE JUL 2021  
DRG SIZE A1  
SCALE AS SHOWN  
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WWW.JN.COM.AU  
N0210053  
C103 2




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DESCRIPTION	COLOUR
NATURAL SURFACE UNDER RL 2.24	
NATURAL SURFACE UNDER RL 3.24	

1 IN 100 YEAR FLOOD STORAGE

FILL VOLUME: 712.303m³

PMF FLOOD STORAGE

FILL VOLUME: 13,255.328m³

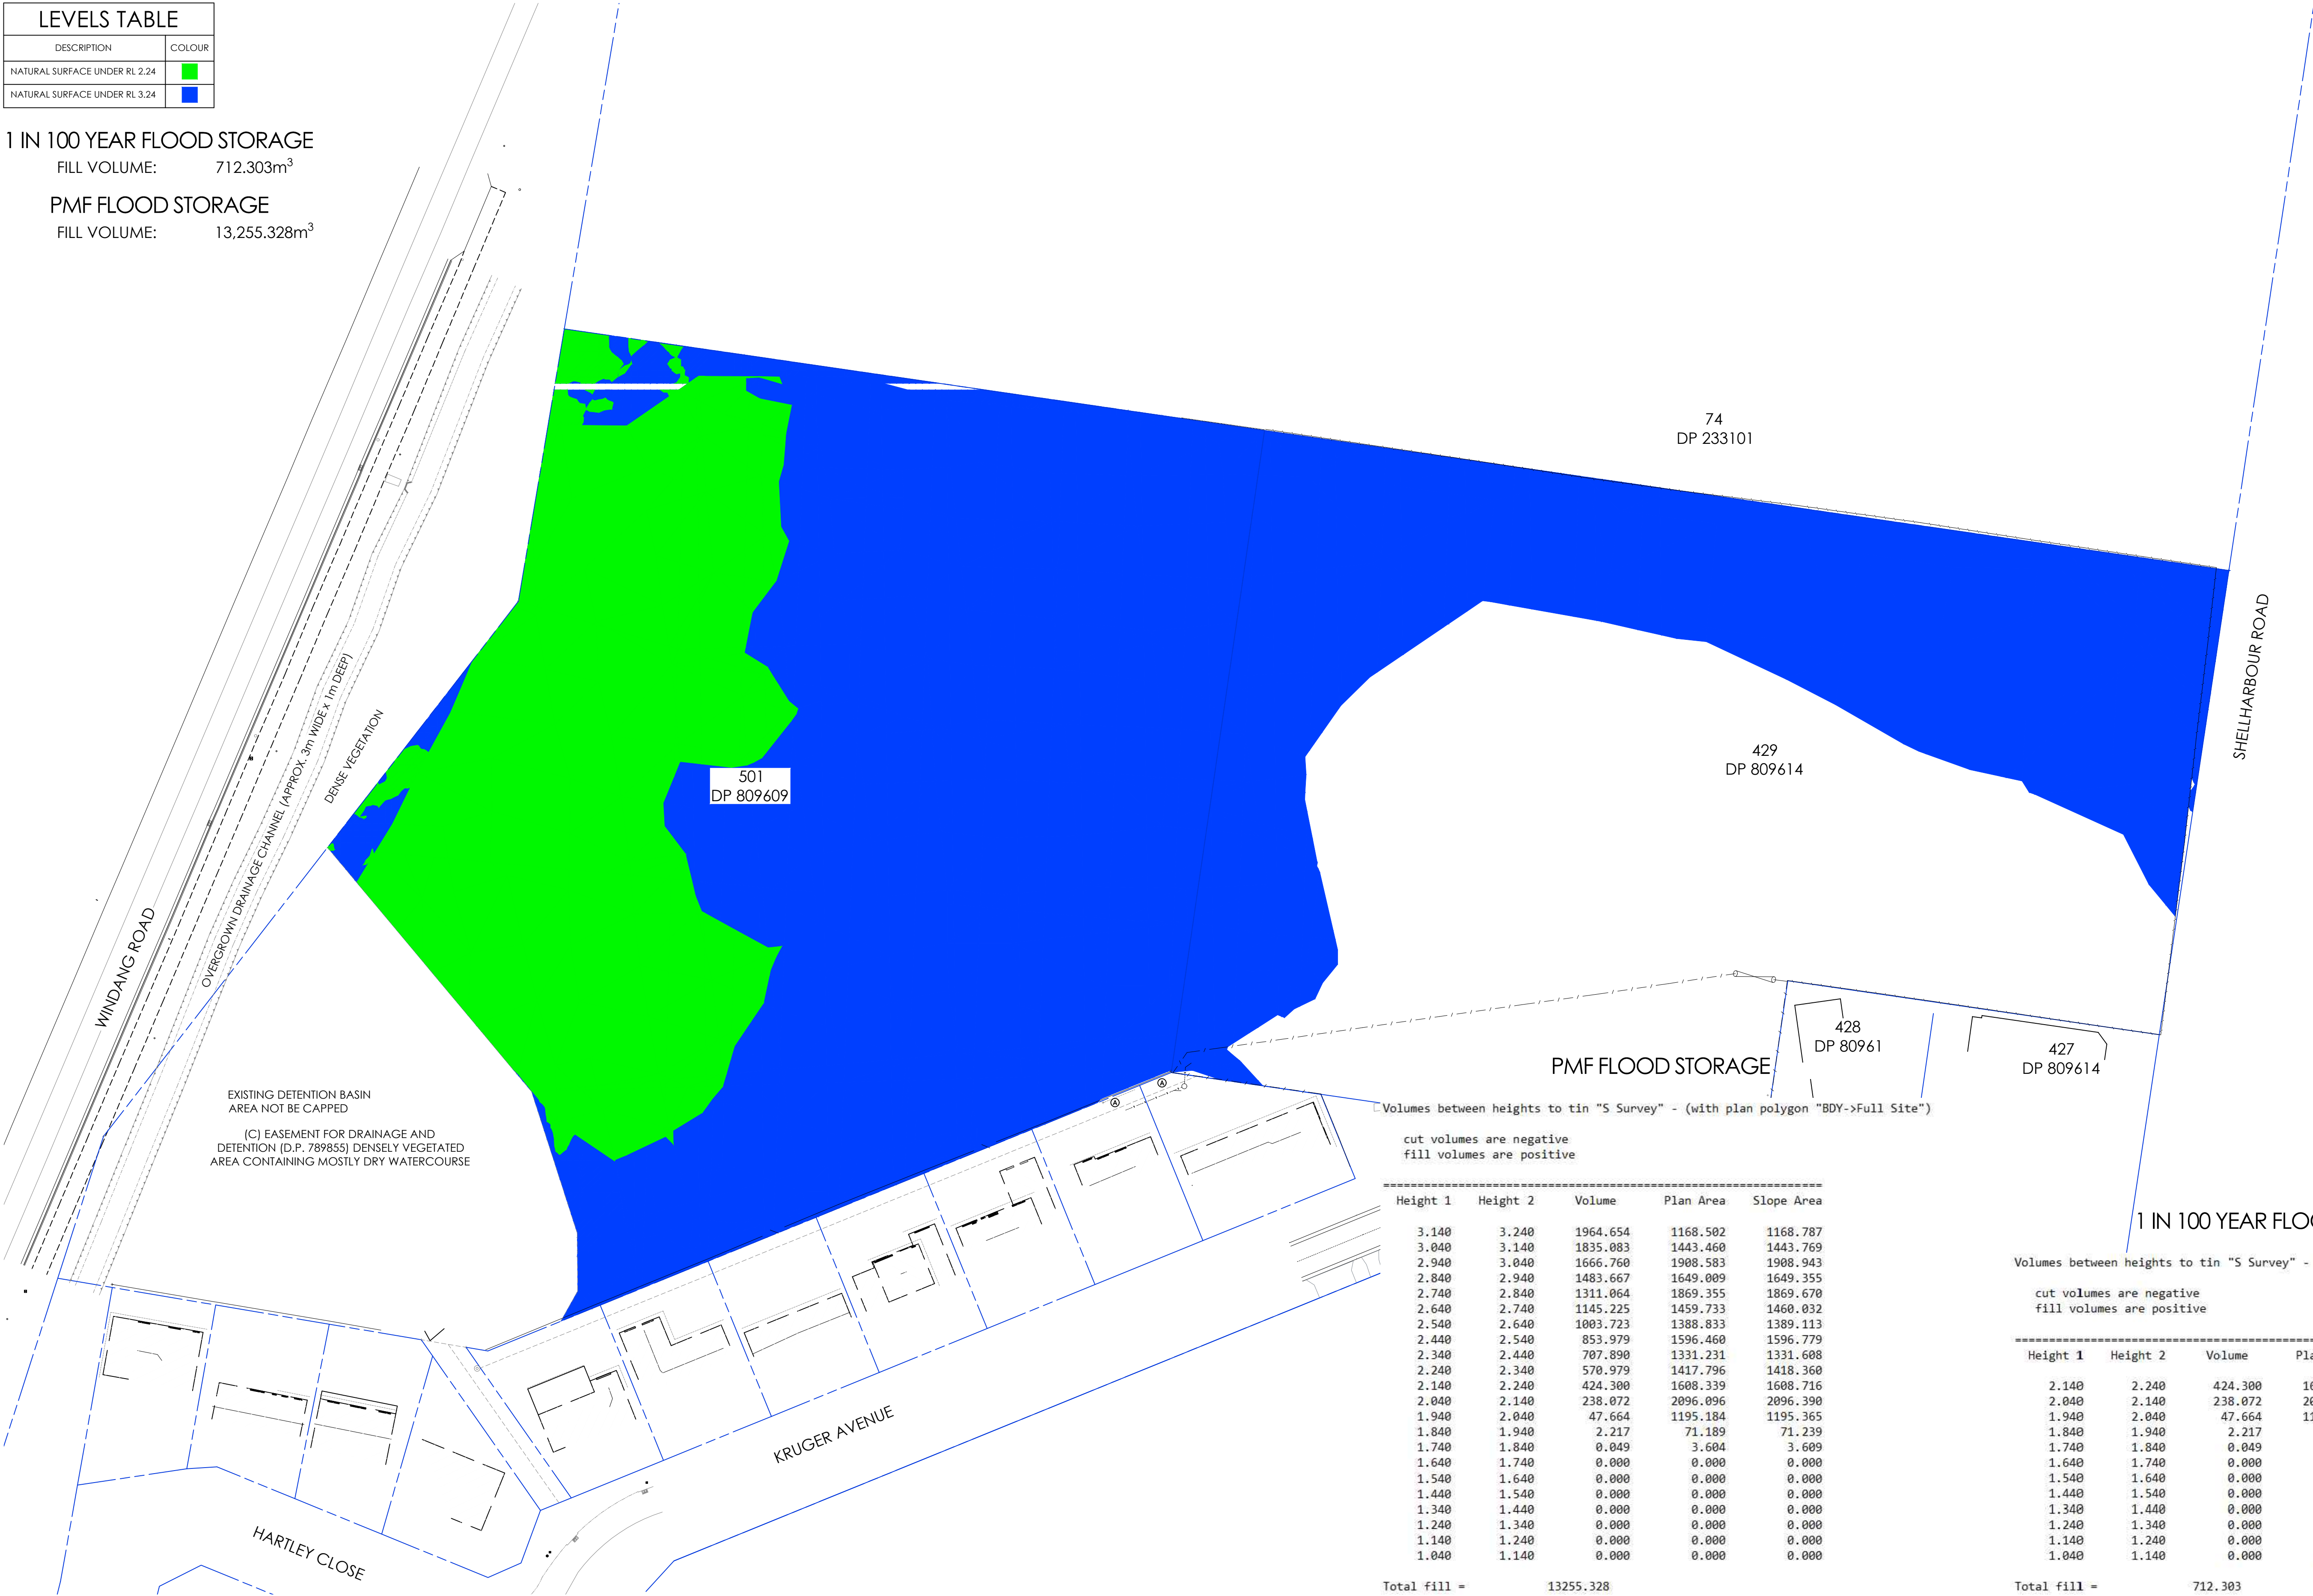


FLOOD STORAGE PLAN - EXISTING

SCALE 1:500

NOT TO BE USED FOR CONSTRUCTION

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2	29.11.21	ISSUED FOR DA	DM
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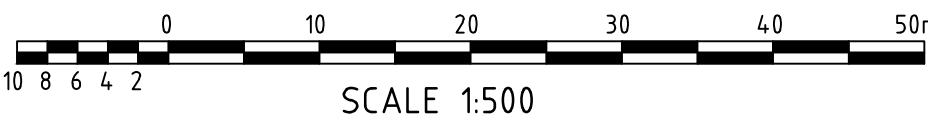
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DISCIPLINE  
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FLOOD STORAGE PLAN  
EXISTING

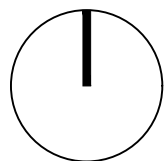PROJECT  
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LOTS 429 AND 501  
ADDRESS  
KRUGER AVENUE, WINDANG  
NSW, 2528

PROJECT DETAILS  
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PROJECT BA  
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WWW.JN.COM.AU  
N0210053  
C200 2






LEVELS TABLE	
DESCRIPTION	COLOUR
NATURAL SURFACE UNDER RL 2.24	
NATURAL SURFACE UNDER RL 3.24	


1 IN 100 YEAR FLOOD STORAGE  
FILL VOLUME: 712.303m<sup>3</sup>

PMF FLOOD STORAGE  
FILL VOLUME: 11,831.653m<sup>3</sup>

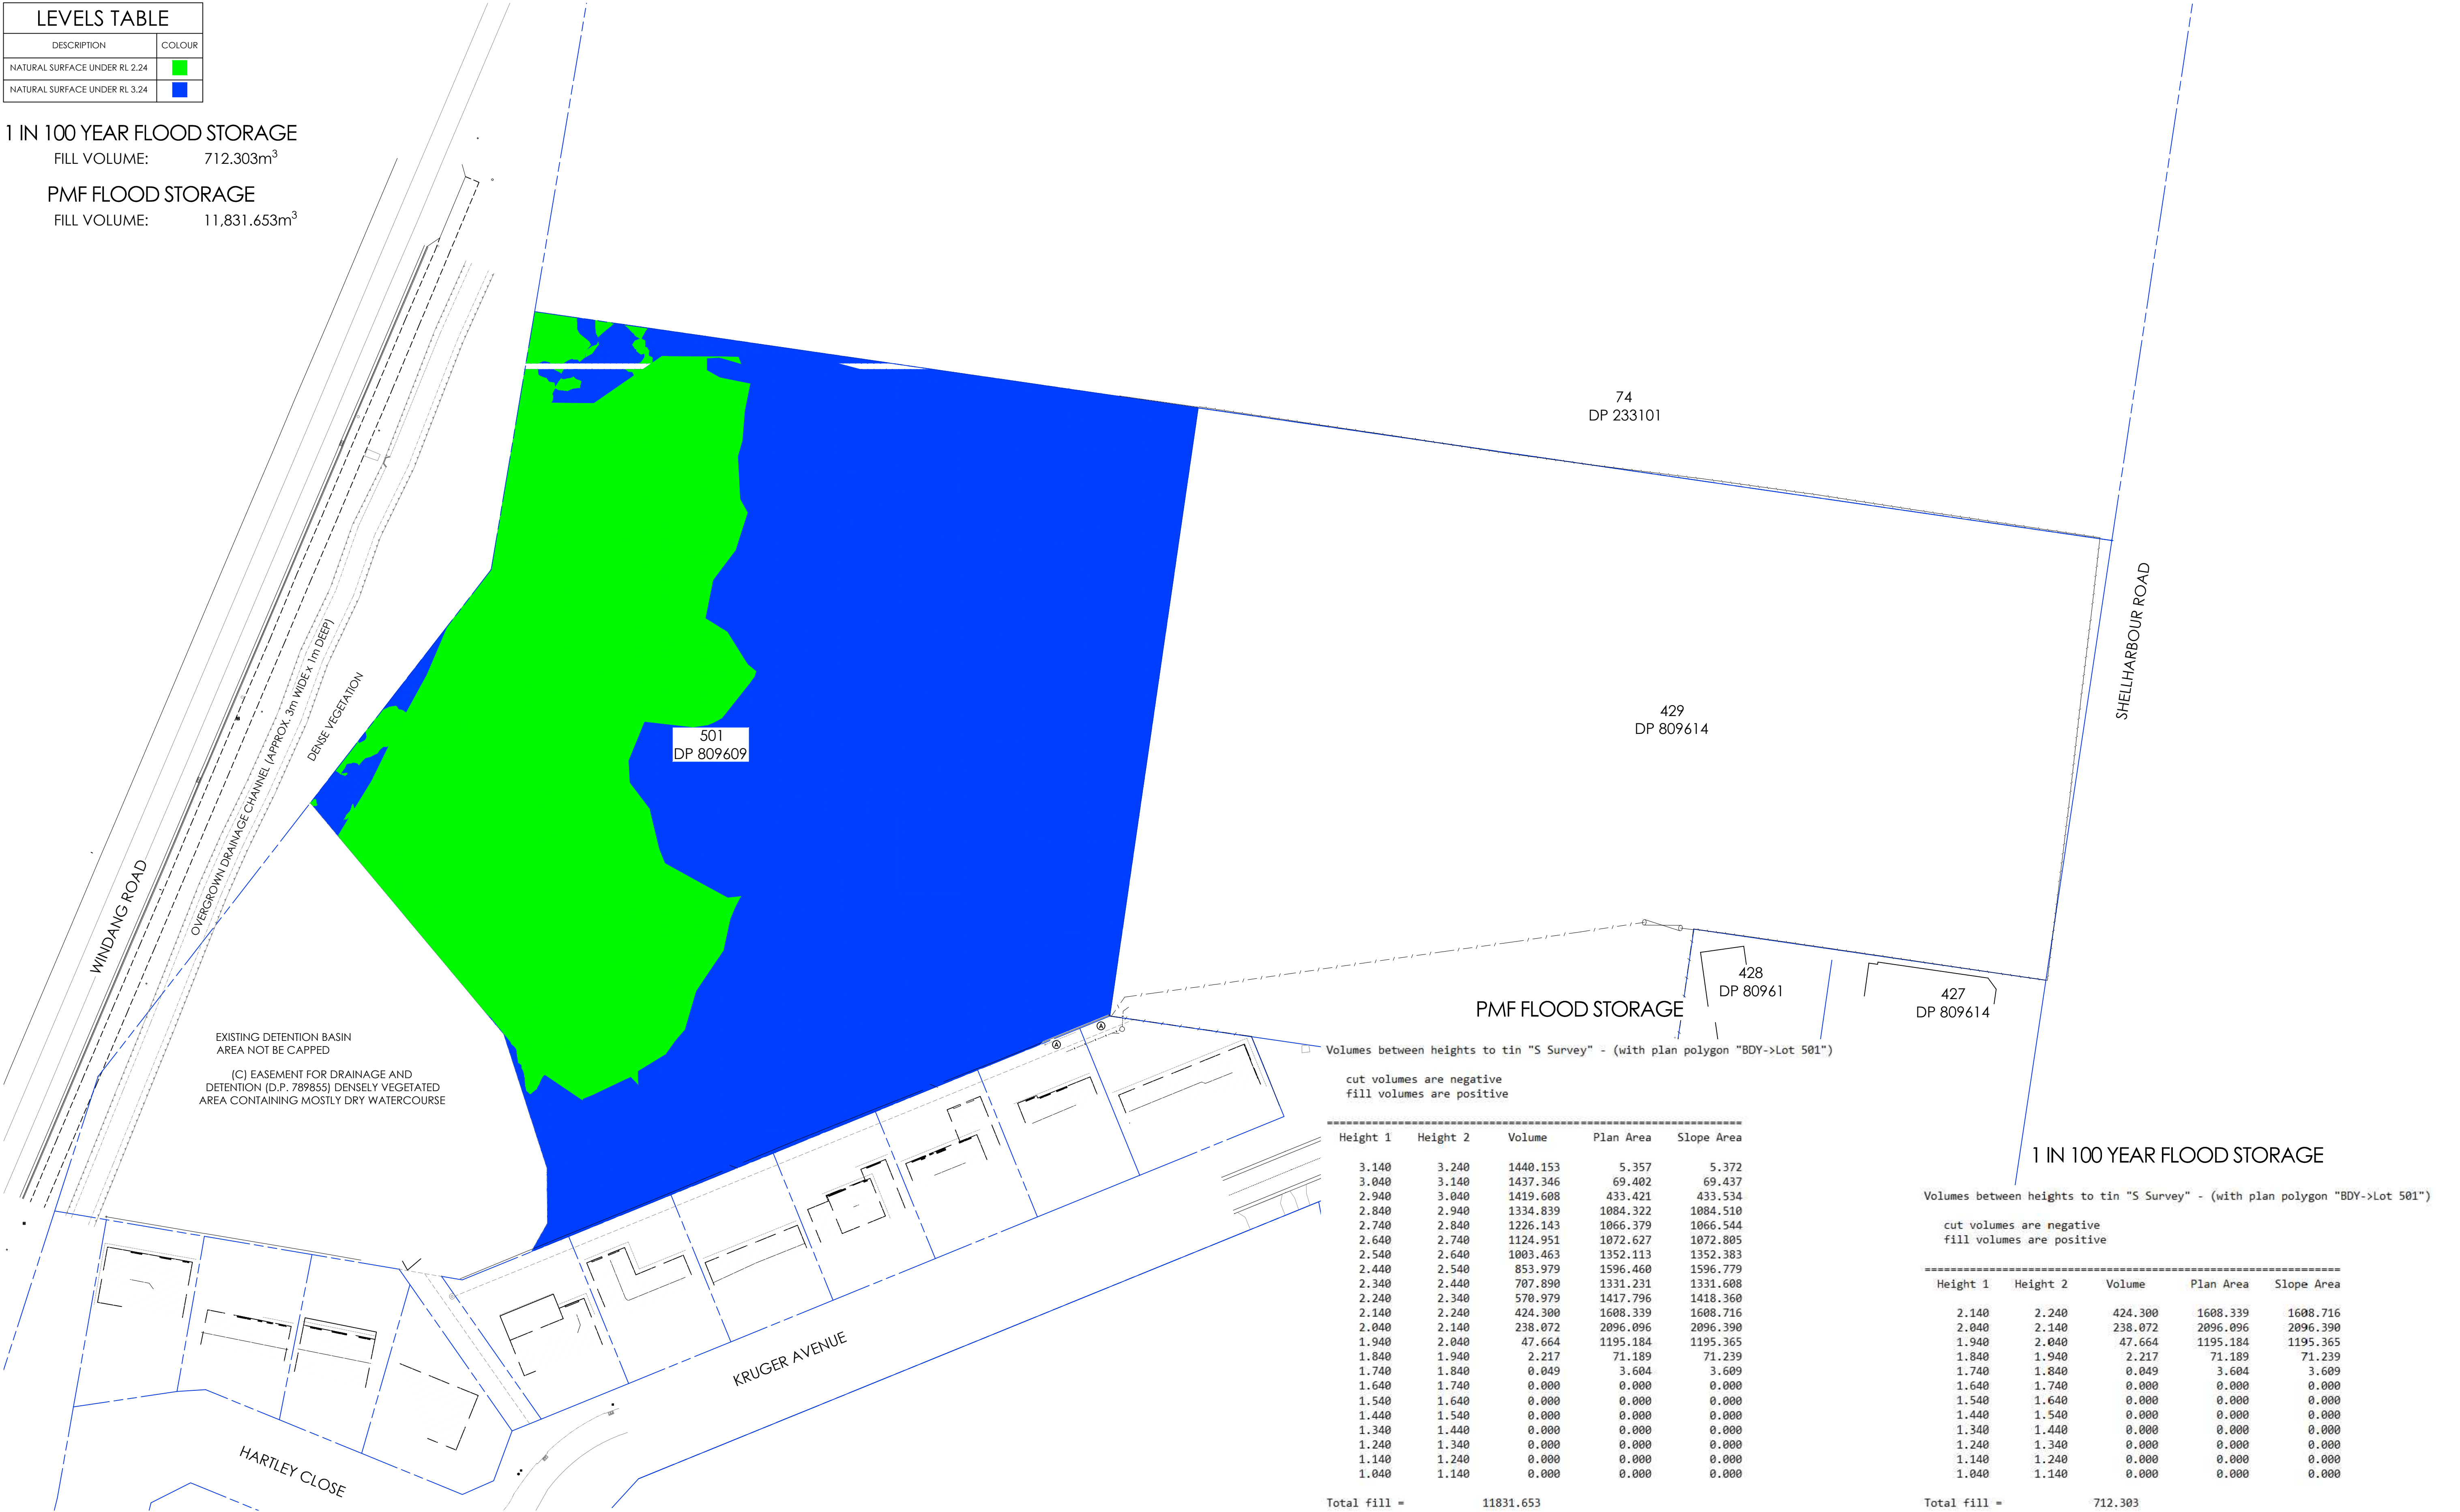

FLOOD STORAGE PLAN - EXISTING LOT 501  
SCALE 1:500

NOT TO BE USED FOR CONSTRUCTION			
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2	29.11.21	ISSUED FOR DA	DM
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CLIENT  
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DISCIPLINE  
CIVIL DESIGN

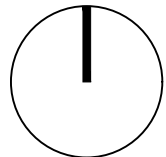DRAWING TITLE  
FLOOD STORAGE PLAN  
EXISTING LOT 501

PROJECT  
PROPOSED SUBDIVISION  
LOTS 429 AND 501

ADDRESS  
KRUGER AVENUE, WINDANG  
NSW, 2528

PROJECT DETAILS  
DESIGN DM  
DRAWN DM  
DATE JUL 2021  
DRG SIZE A1  
SCALE 1:500  
PROJECT BA  
MGR  
WWW.JN.COM.AU

N0210053  
C201 2




LEVELS TABLE	
DESCRIPTION	COLOUR
NATURAL SURFACE UNDER RL 3.24	<div></div>

1 IN 100 YEAR FLOOD STORAGE

FILL VOLUME: 0.000m<sup>3</sup>


PMF FLOOD STORAGE

FILL VOLUME: 1,423.674m<sup>3</sup>

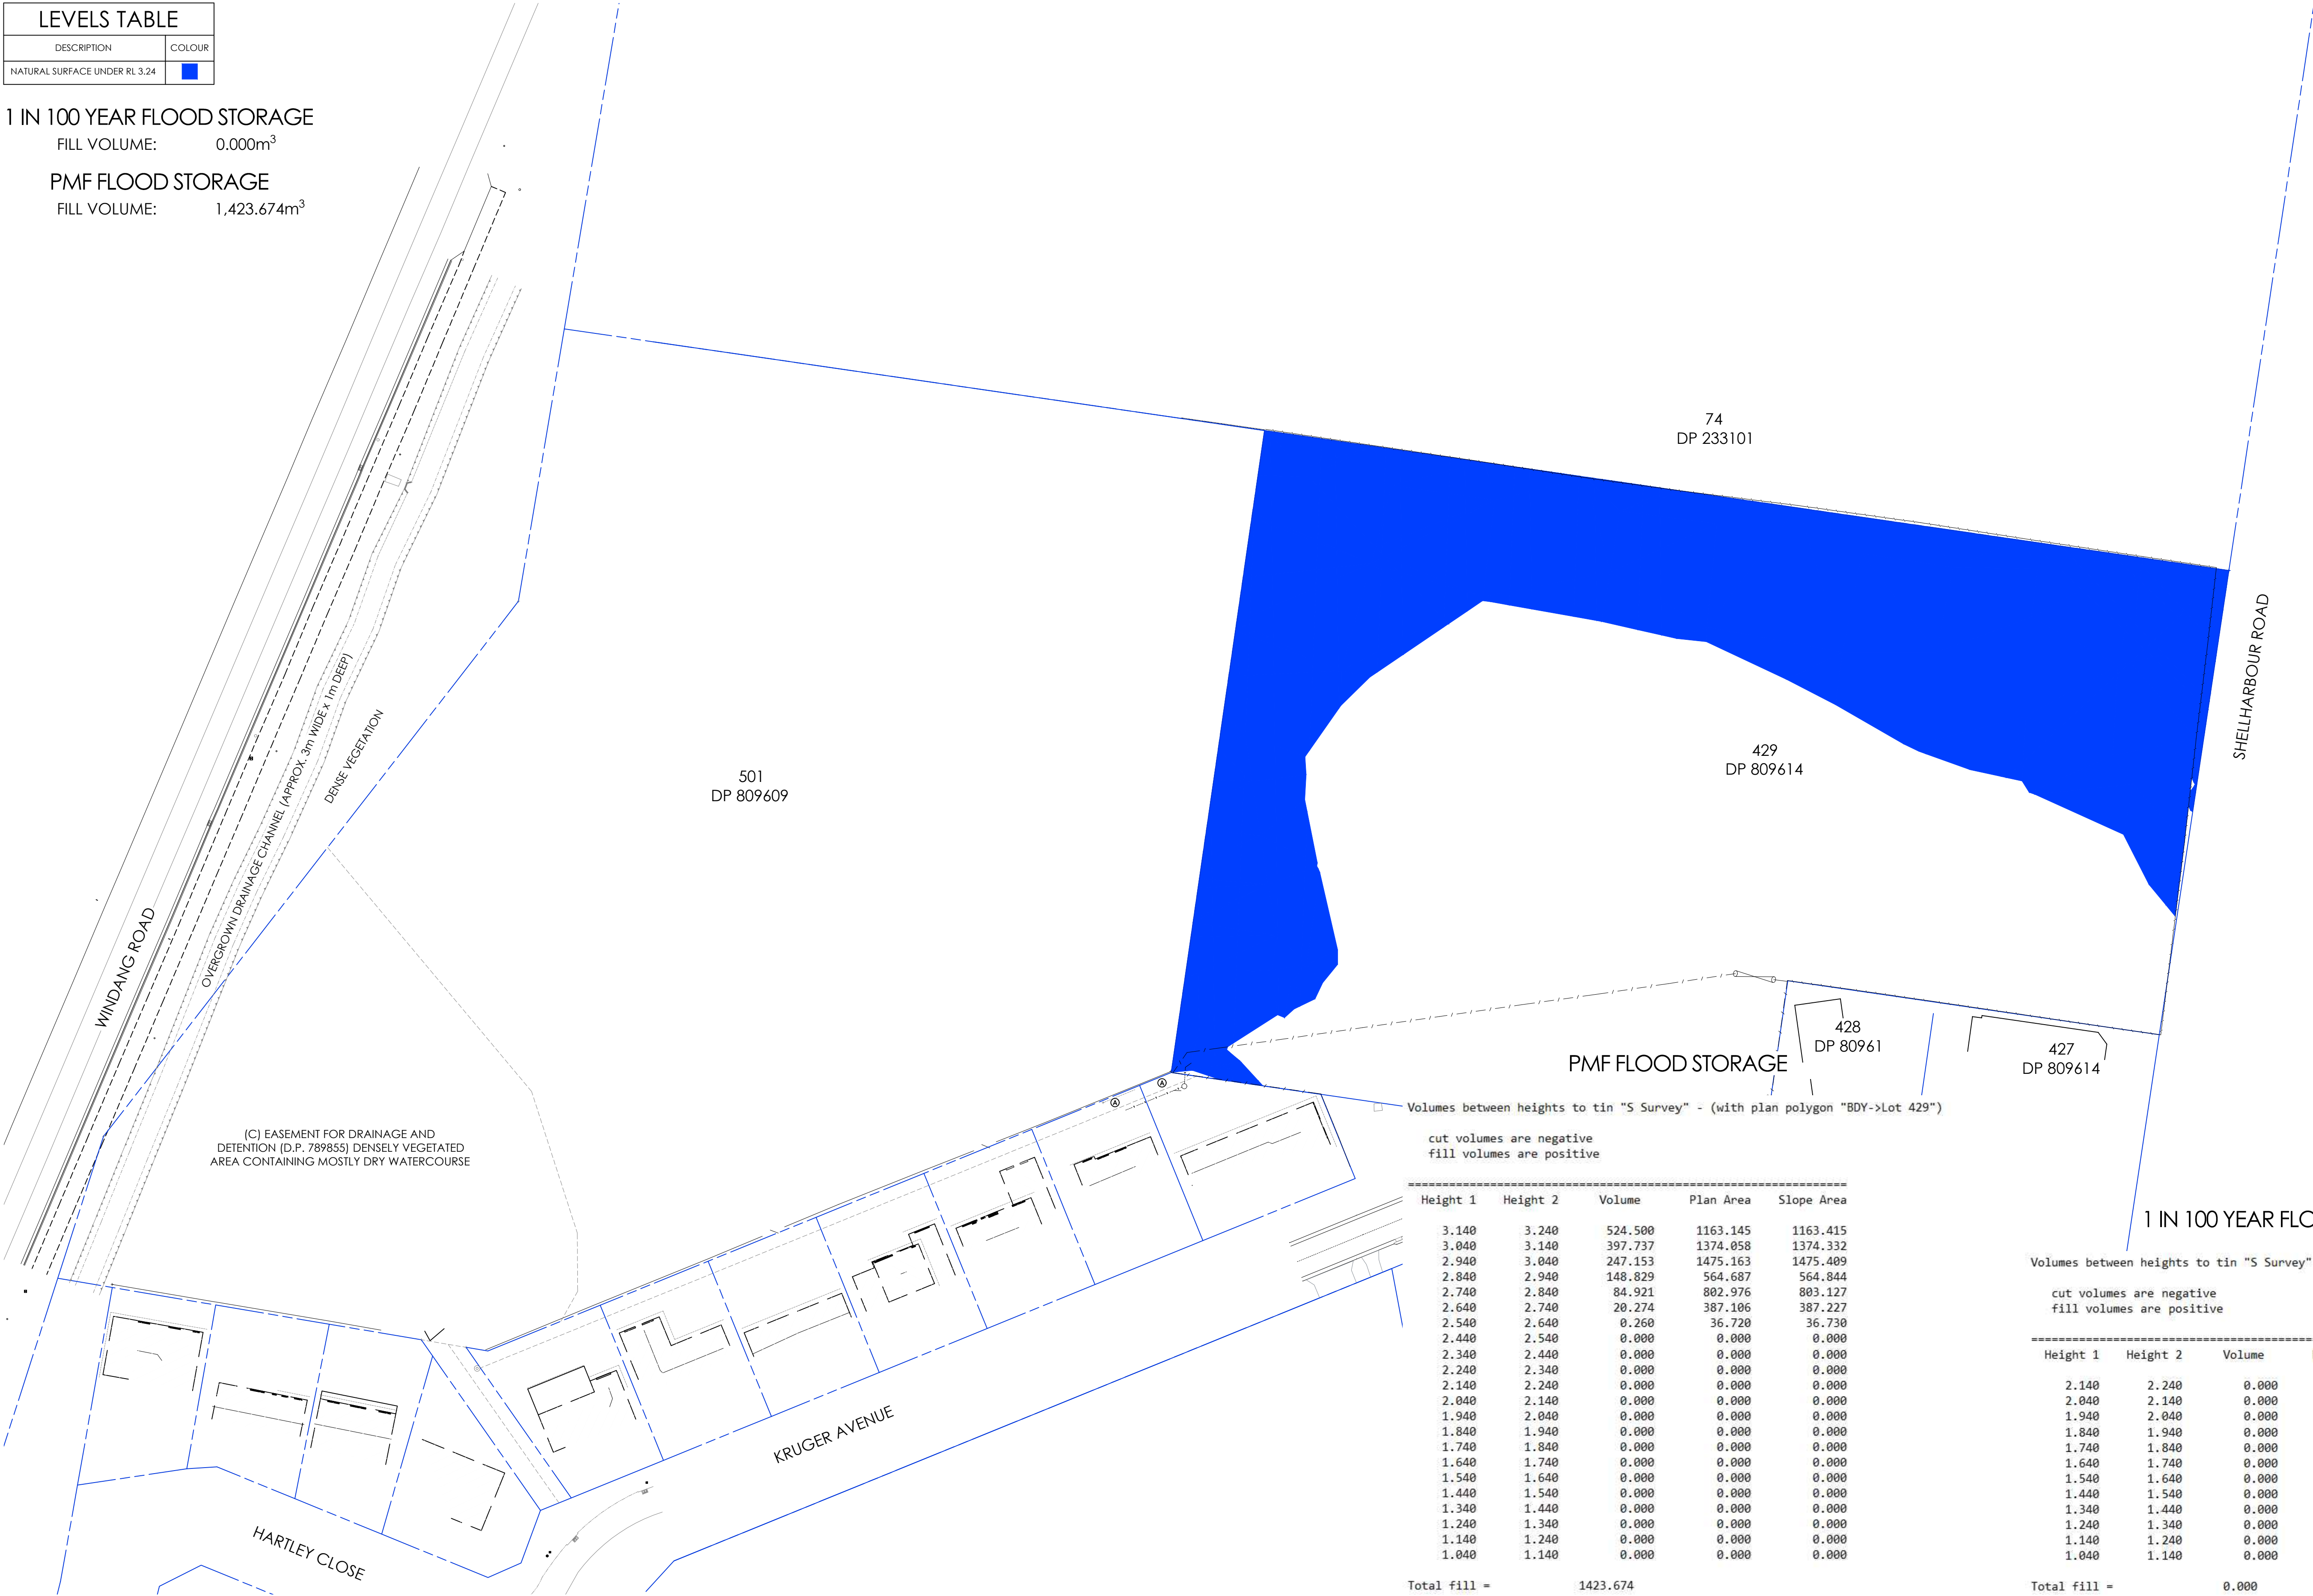

FLOOD STORAGE PLAN - EXISTING LOT 429


SCALE 1:500

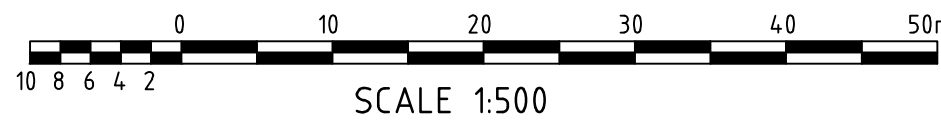

SCALE 1:500

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AMDT	DATE	DESCRIPTION	BY
2	29.11.21	ISSUED FOR DA	DM
1	05.08.21	PRELIMINARY ISSUE	LAP

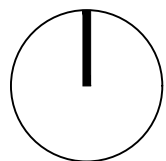

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WINDANG KRUGER UNIT TRUST  
STATUS  
PRELIMINARY DA ISSUE

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DISCIPLINE  
CIVIL DESIGN  
DRAWING TITLE  
FLOOD STORAGE PLAN  
EXISTING LOT 429

PROJECT  
PROPOSED SUBDIVISION  
LOTS 429 AND 501  
ADDRESS  
KRUGER AVENUE, WINDANG  
NSW, 2528

PROJECT DETAILS  
DESIGN DM  
DRAWN DM  
DATE JUL 2021  
DRG SIZE A1  
SCALE 1:500  
PROJECT BA  
MGR  
WWW.JN.COM.AU  
N0210053  
C202 2




LEVELS TABLE	
DESCRIPTION	COLOUR
DESIGN SURFACE UNDER RL 2.24	■
DESIGN SURFACE UNDER RL 3.24	■

1 IN 100 YEAR FLOOD STORAGE

FILL VOLUME: 348.494m³


PMF FLOOD STORAGE

FILL VOLUME: 5,323.637m³

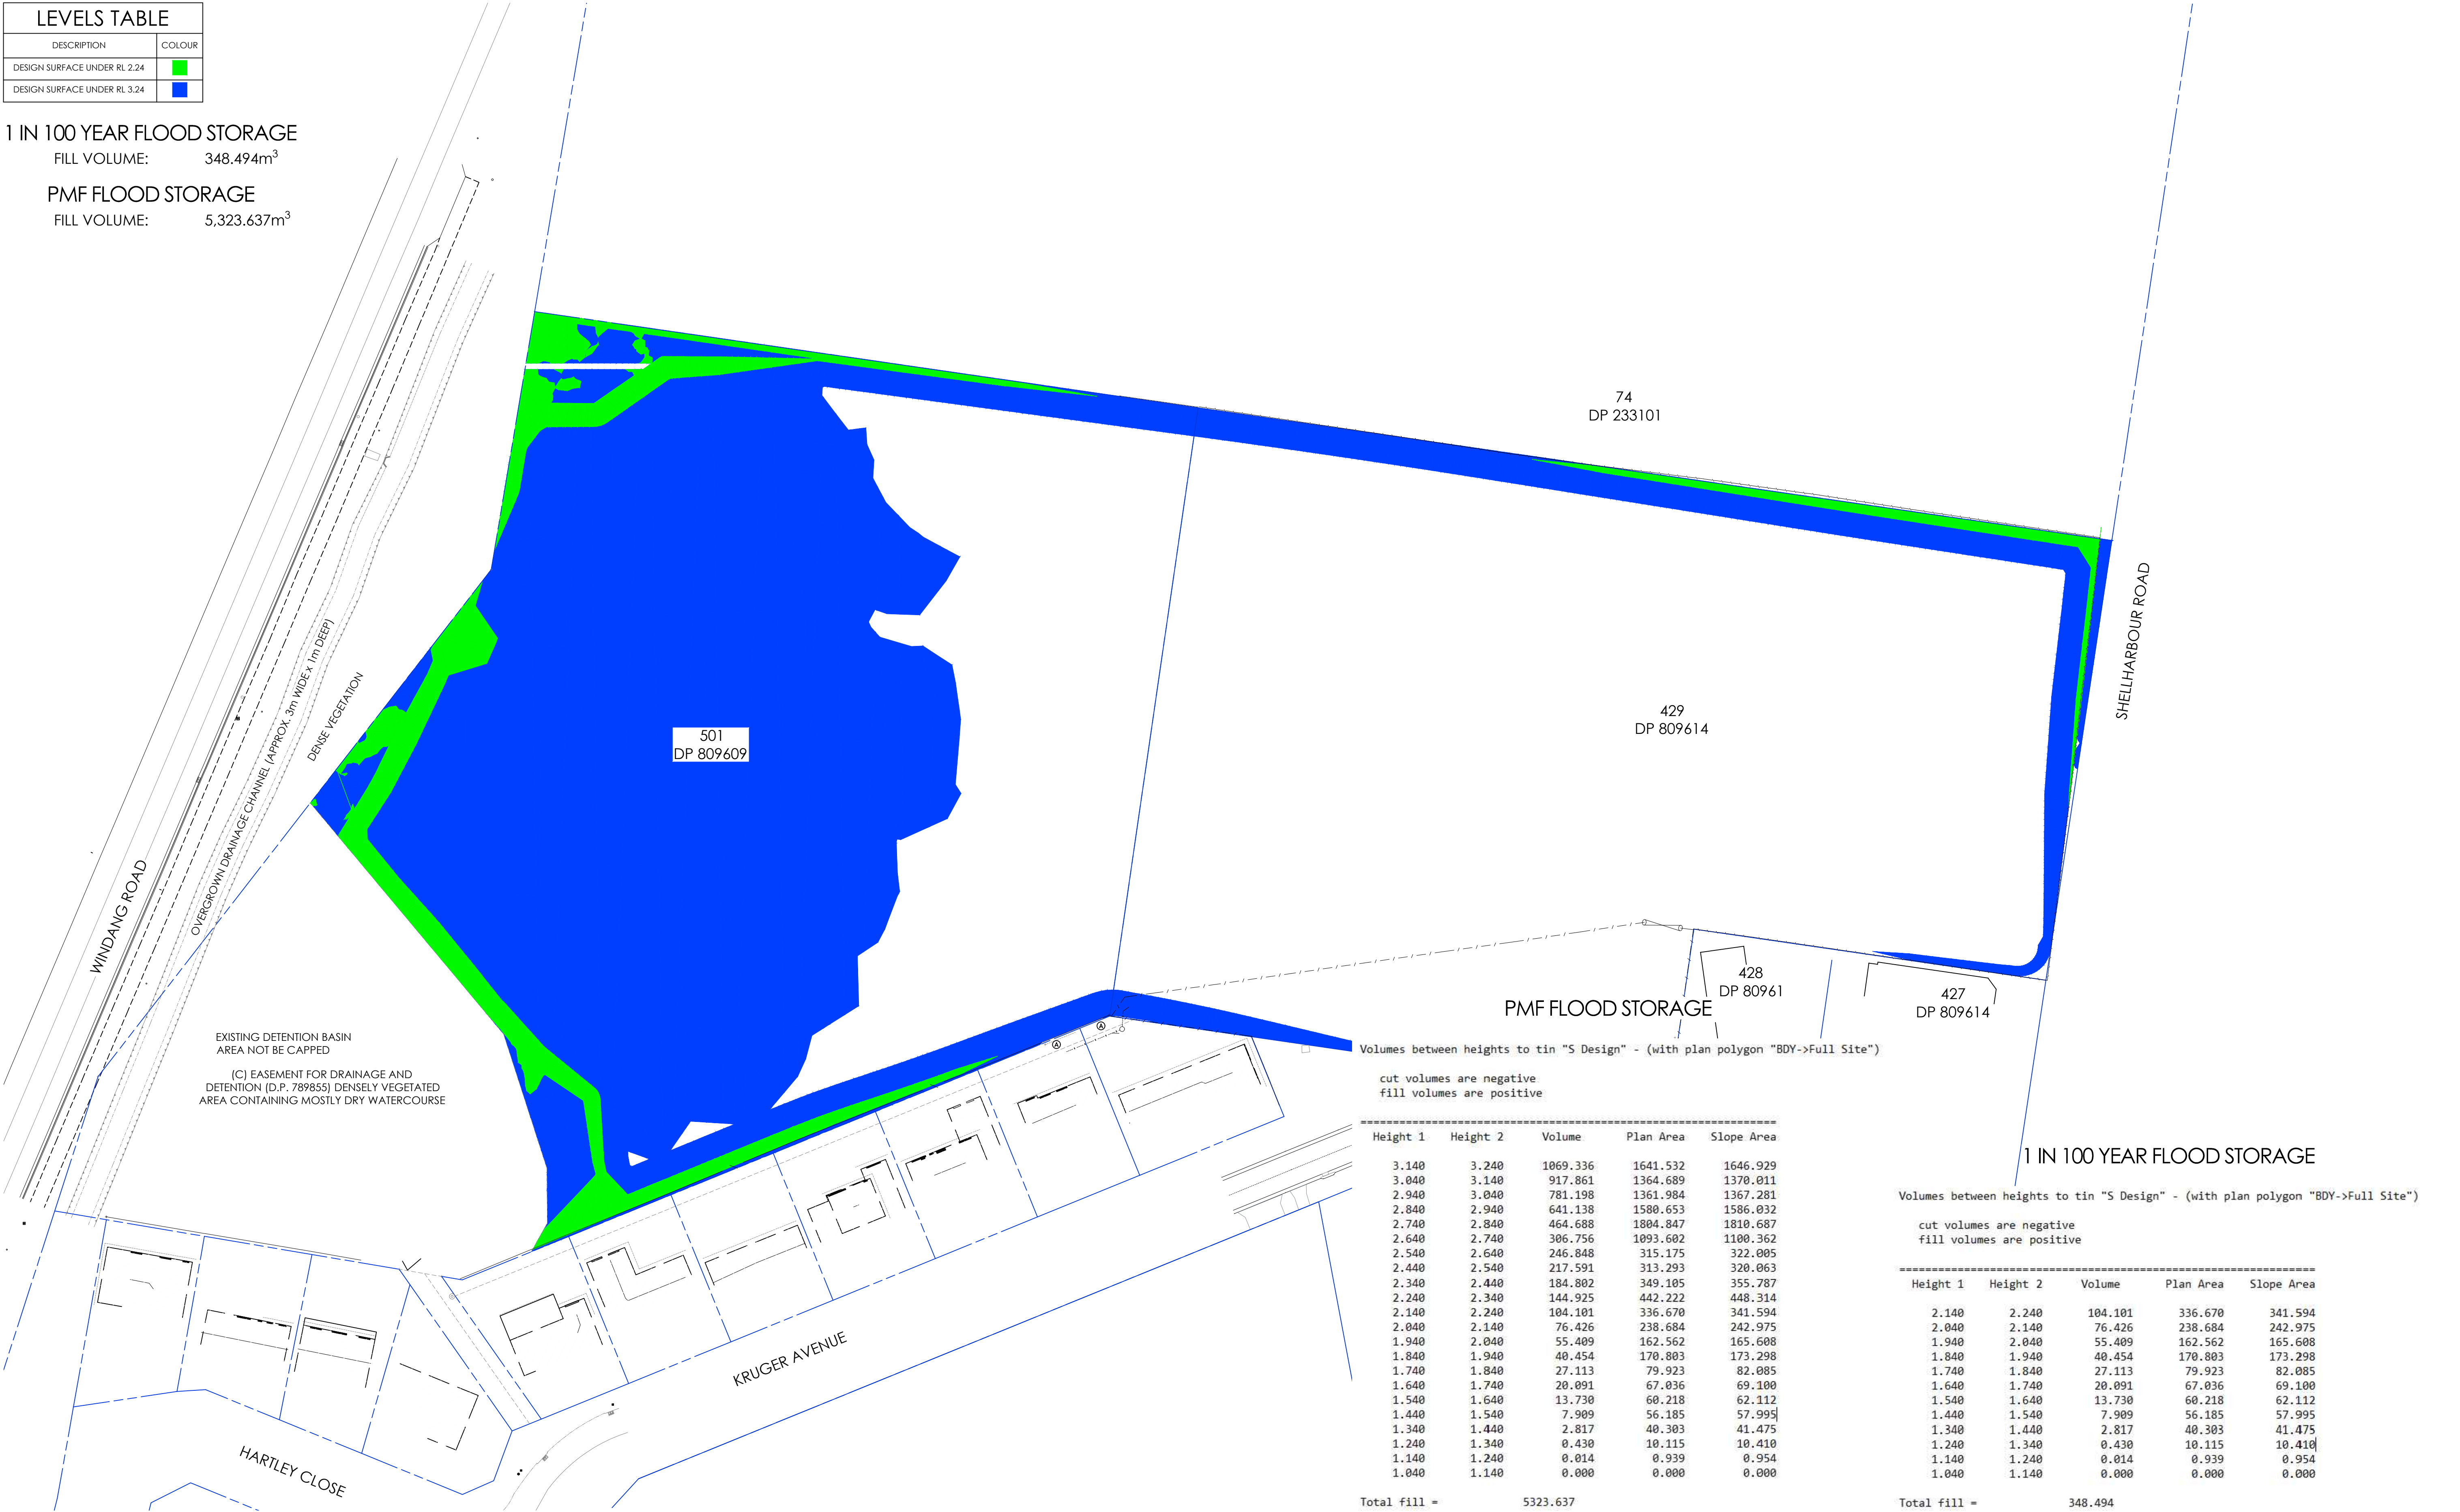

FLOOD STORAGE PLAN - DESIGN


SCALE 1:500

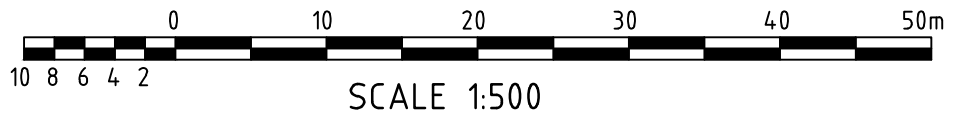

SCALE 1:500

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AMDT	DATE	DESCRIPTION	BY
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1	05.08.21	PRELIMINARY ISSUE	LAP

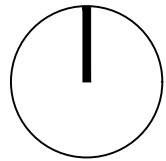

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DISCIPLINE  
CIVIL DESIGN  
DRAWING TITLE  
FLOOD STORAGE PLAN  
DESIGN

PROJECT  
PROPOSED SUBDIVISION  
LOTS 429 AND 501  
ADDRESS  
KRUGER AVENUE, WINDANG  
NSW, 2528

PROJECT DETAILS  
DESIGN DM  
DRAWN DM  
DATE JUL 2021  
DRG SIZE A1  
SCALE 1:500  
PROJECT BA  
MGR  
WWW.JN.COM.AU  
N0210053  
C203 2




LEVELS TABLE	
DESCRIPTION	COLOUR
DESIGN SURFACE UNDER RL 2.24	■
DESIGN SURFACE UNDER RL 3.24	■

1 IN 100 YEAR FLOOD STORAGE

FILL VOLUME: 329.291m³


PMF FLOOD STORAGE

FILL VOLUME: 4,822.443m³

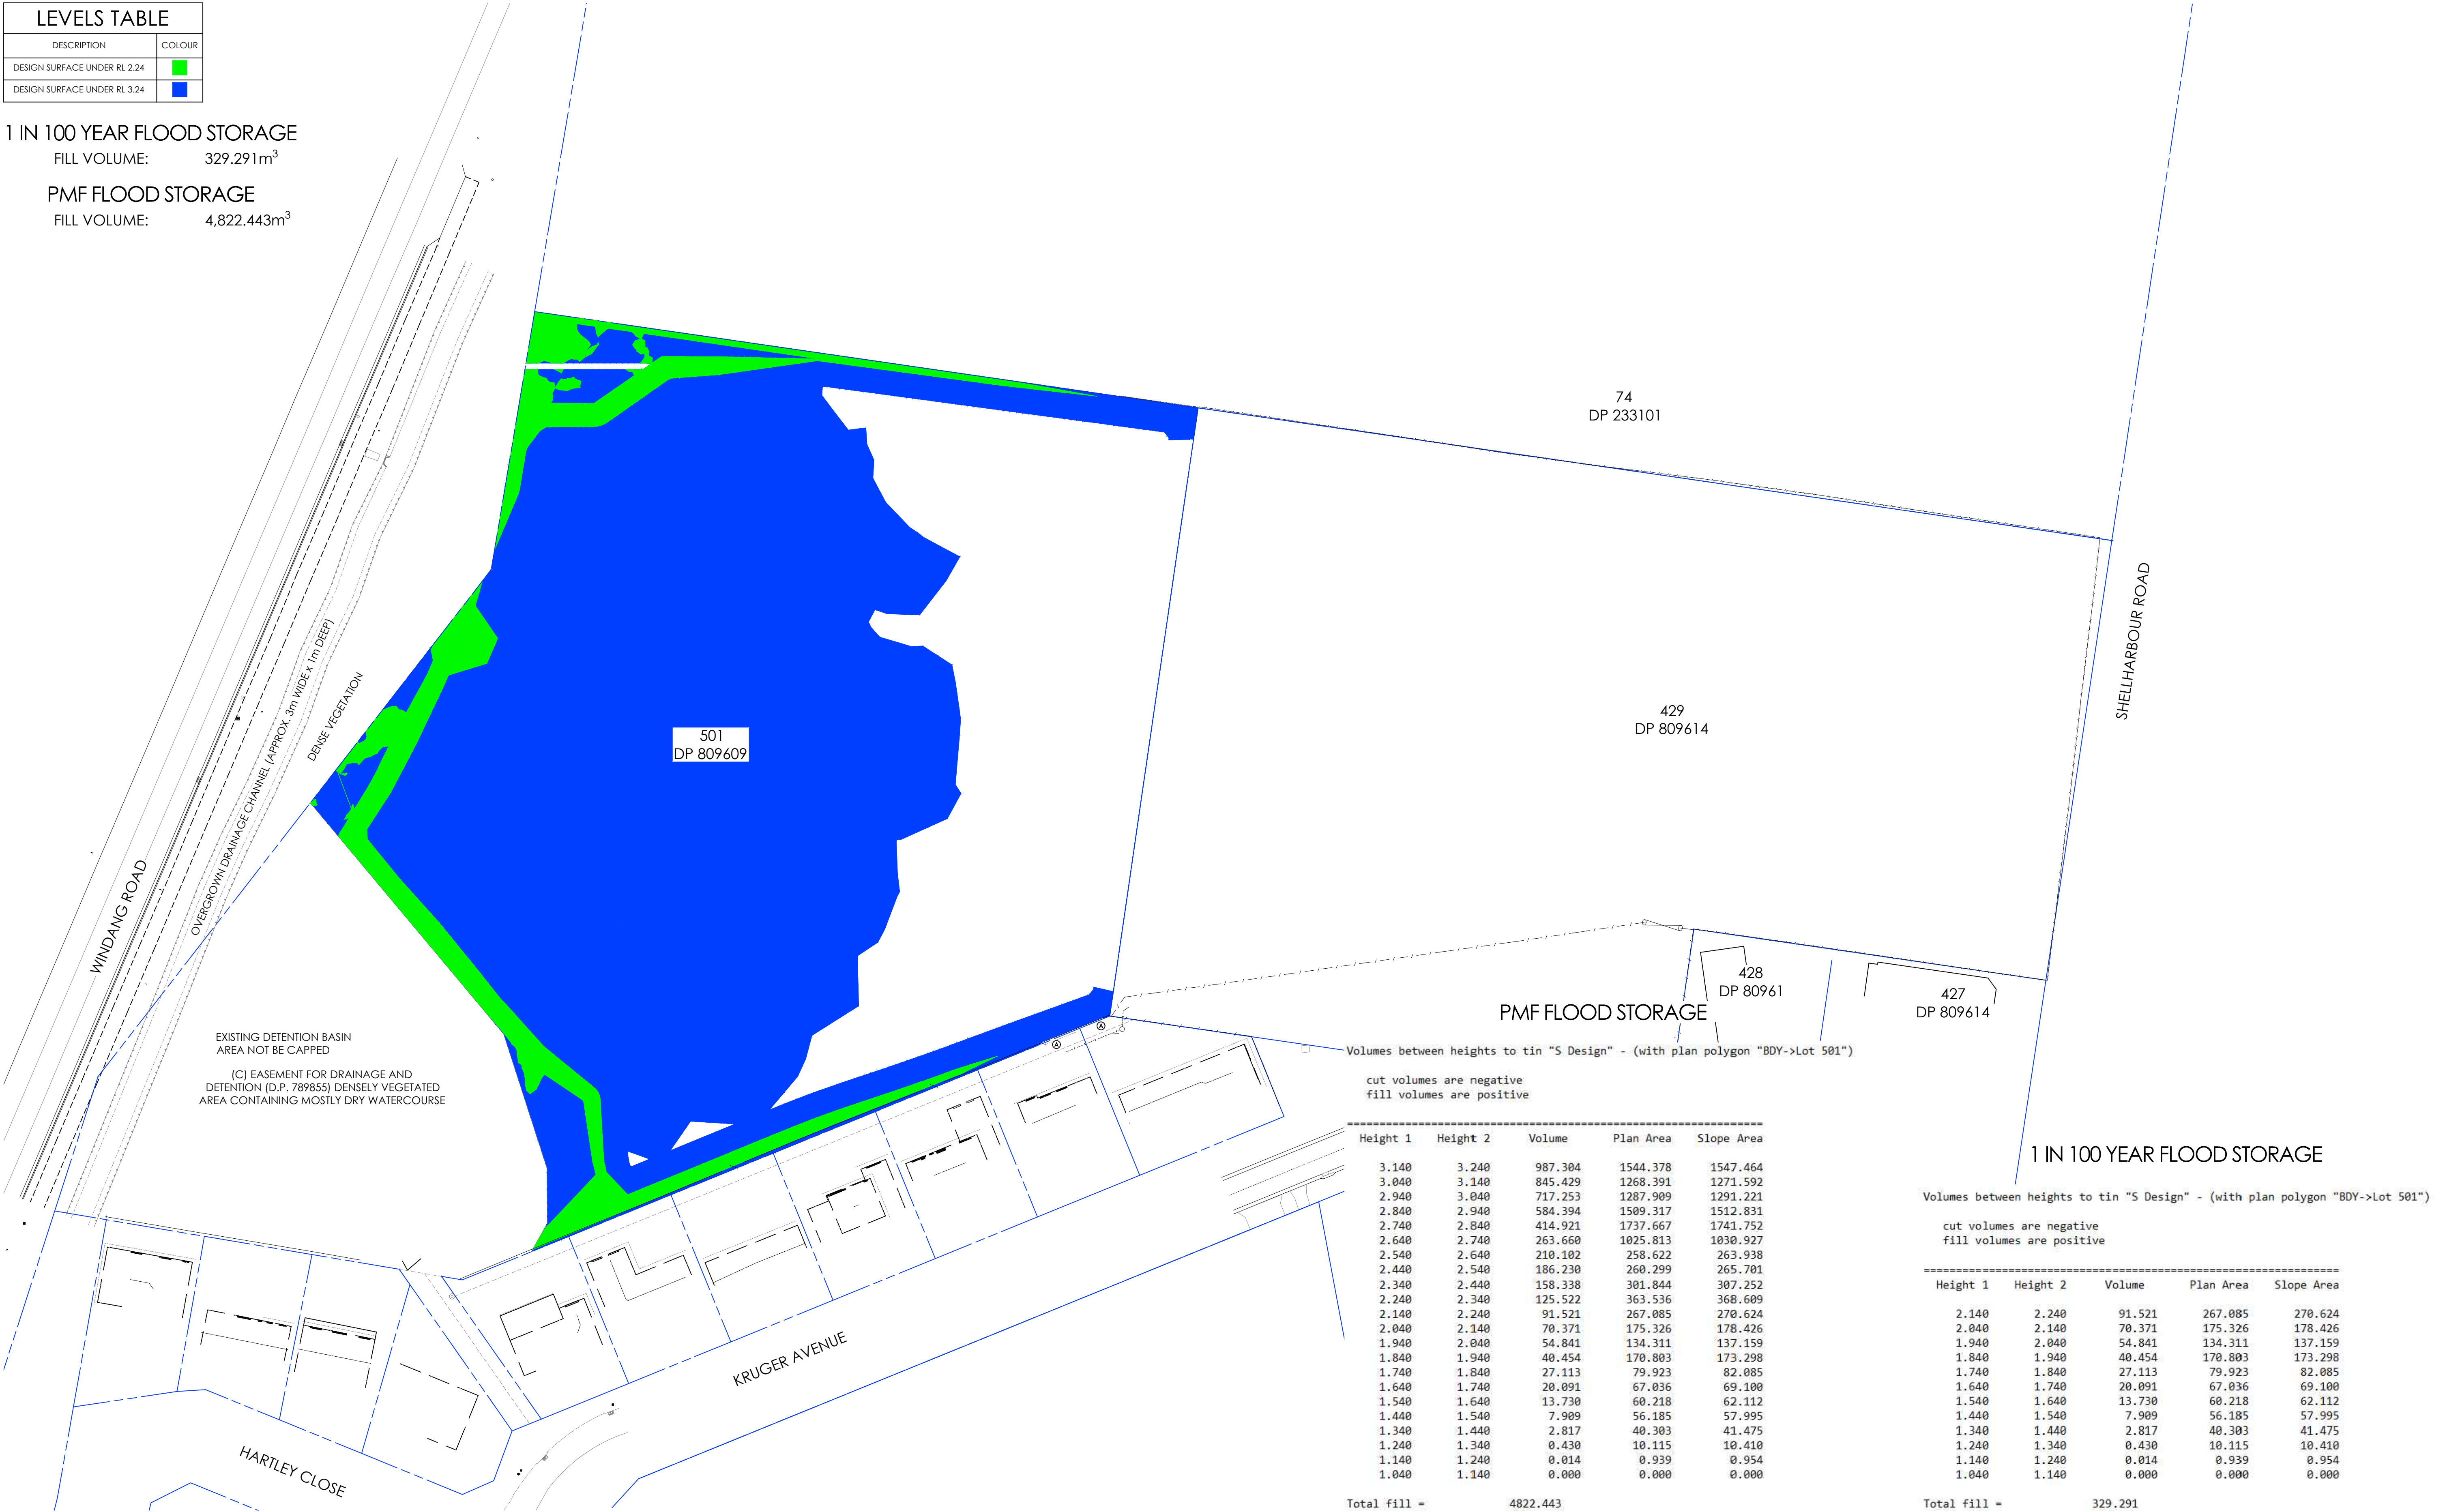


FLOOD STORAGE PLAN - DESIGN

SCALE 1:500

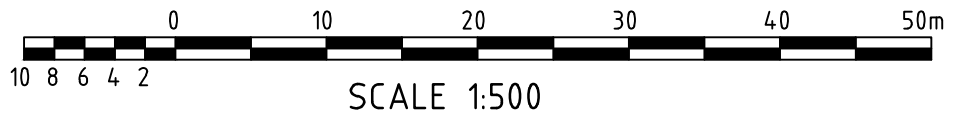

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1	05.08.21	PRELIMINARY ISSUE	LAP

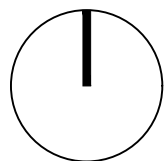

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DISCIPLINE  
CIVIL DESIGN  
DRAWING TITLE  
FLOOD STORAGE PLAN  
DESIGN LOT 501

PROJECT  
PROPOSED SUBDIVISION  
LOTS 429 AND 501  
ADDRESS  
KRUGER AVENUE, WINDANG  
NSW, 2528

PROJECT DETAILS  
DESIGN DM  
DRAWN DM  
DATE JUL 2021  
DRG SIZE A1  
SCALE 1:500  
PROJECT BA  
MGR  
WWW.JN.COM.AU  
N0210053  
C204 2




LEVELS TABLE	
DESCRIPTION	COLOUR
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DESIGN SURFACE UNDER RL 3.24	■

1 IN 100 YEAR FLOOD STORAGE

FILL VOLUME: 19.230m³


PMF FLOOD STORAGE

FILL VOLUME: 865.272m³

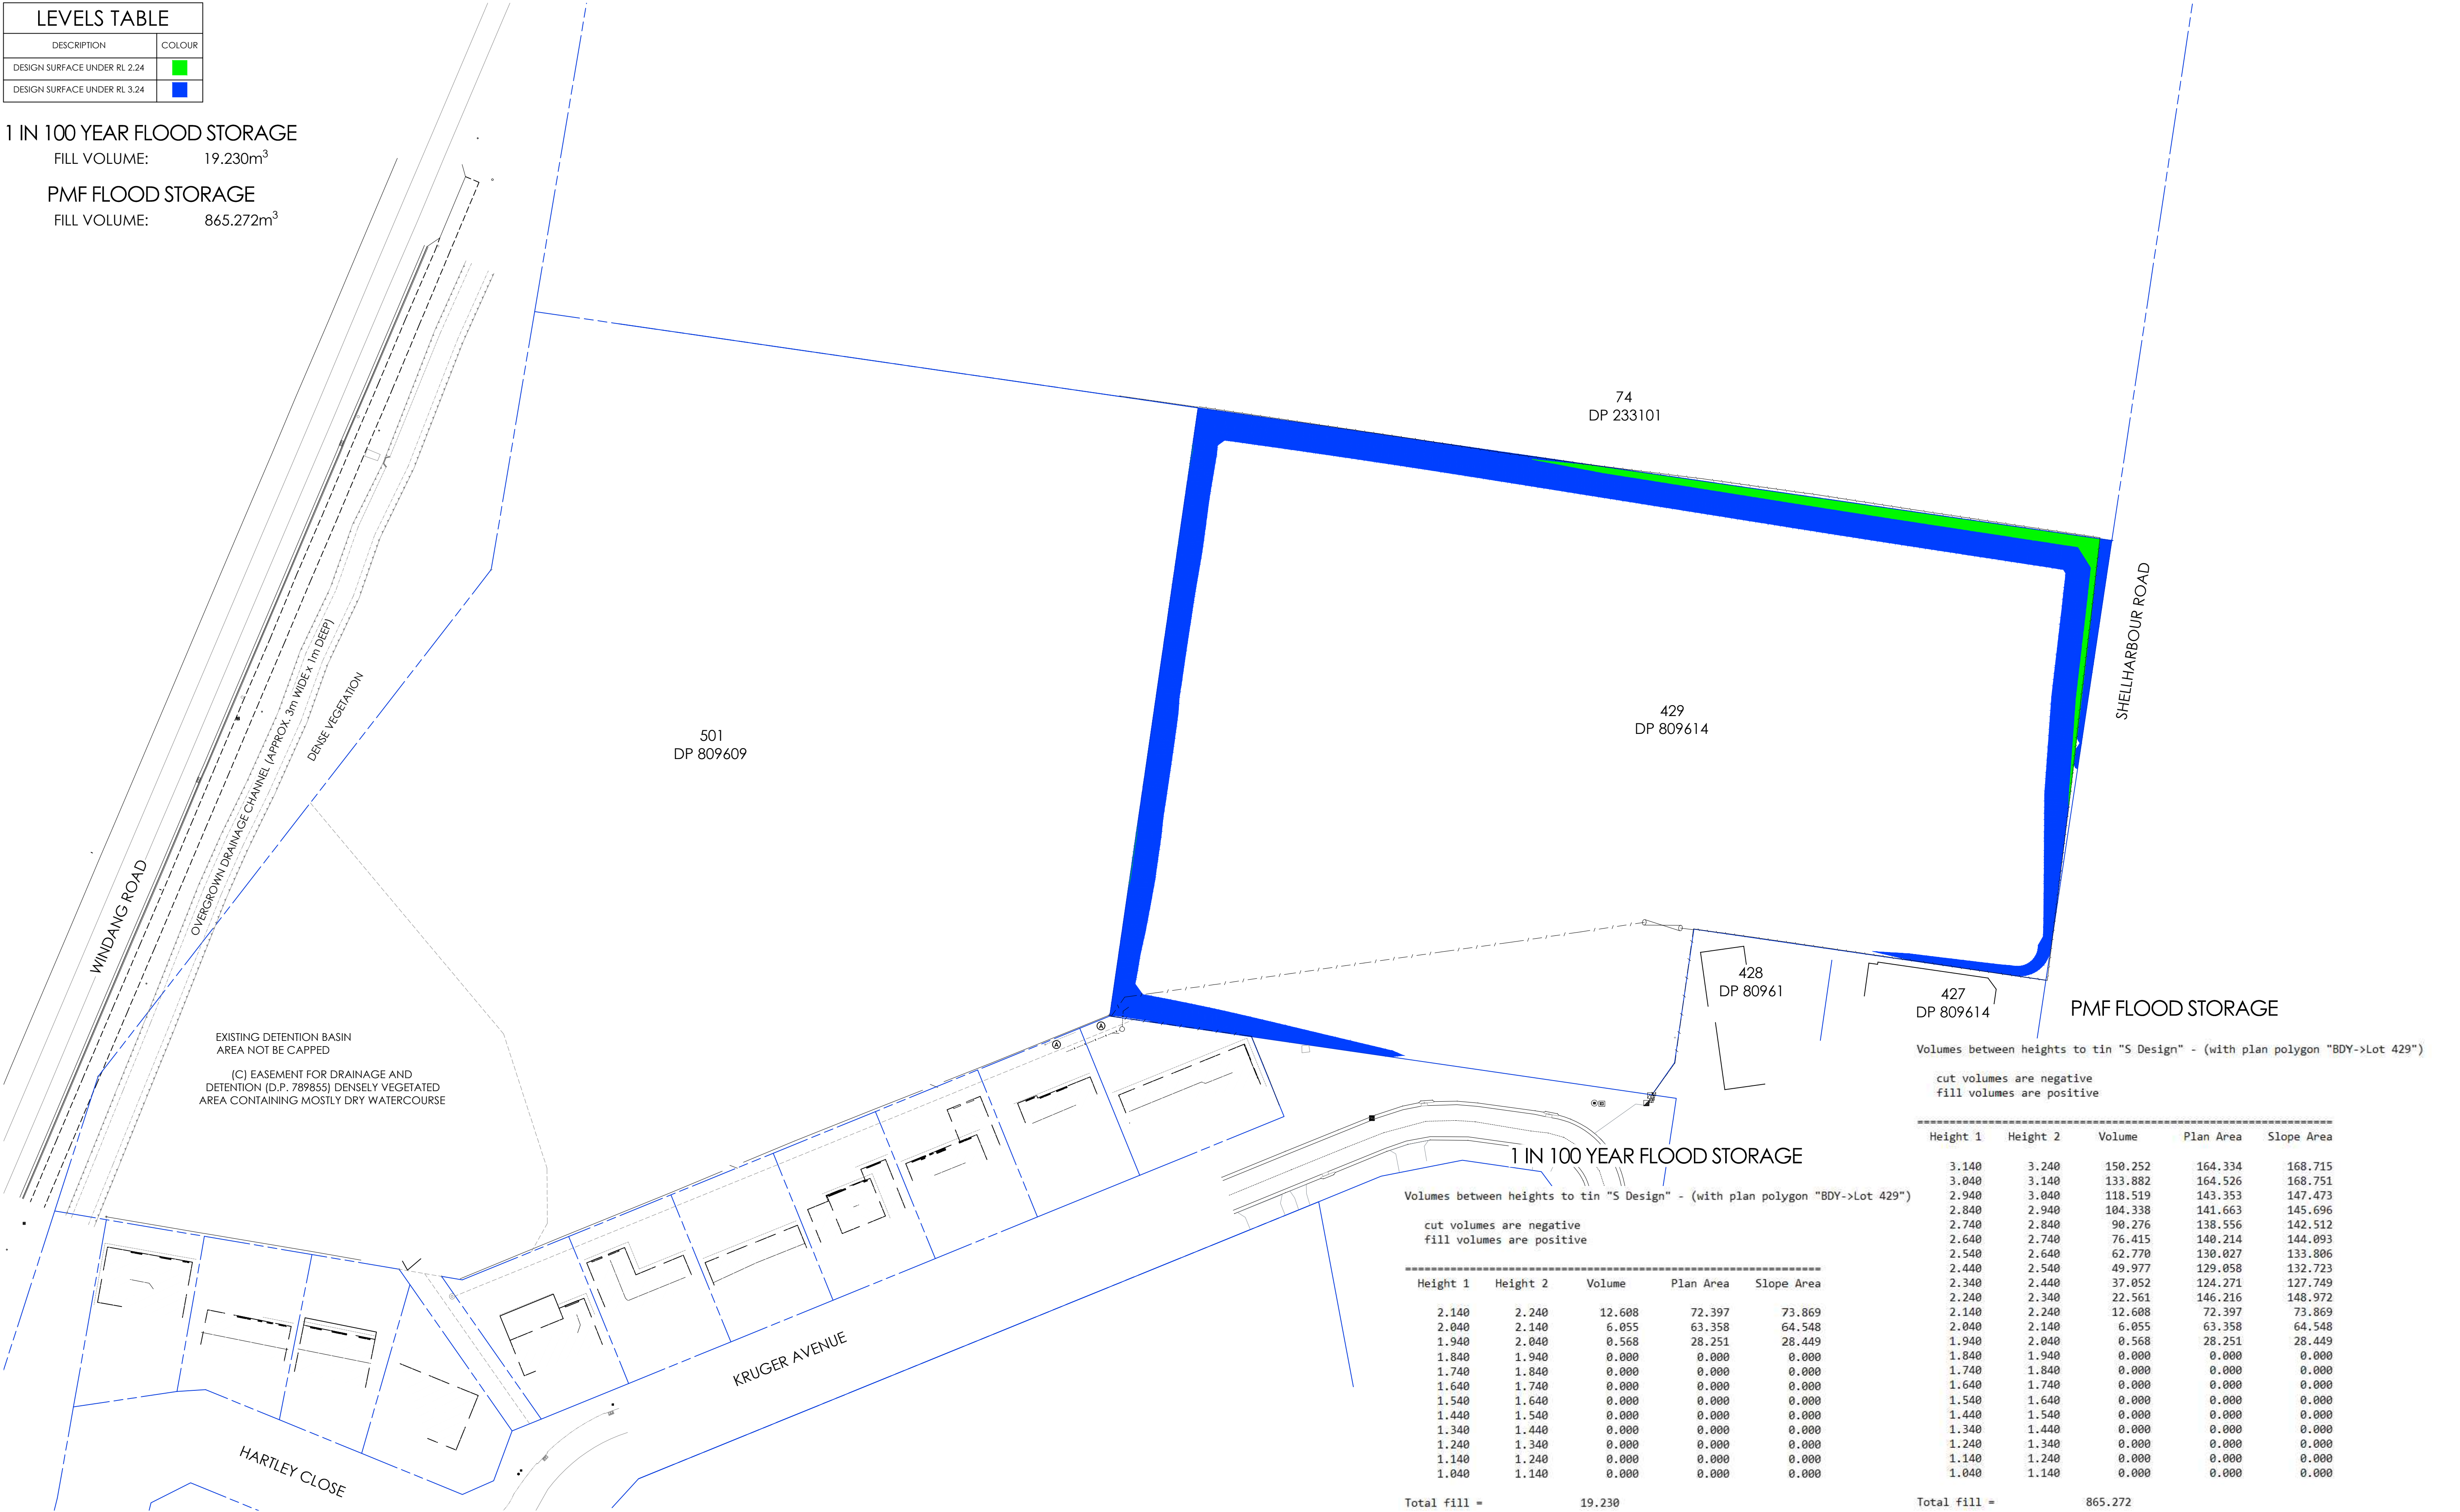

FLOOD STORAGE PLAN - DESIGN LOT 429


SCALE 1:500

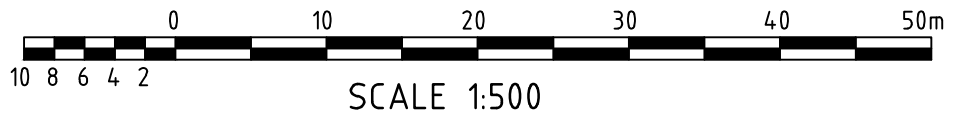

SCALE 1:500

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DISCIPLINE  
CIVIL DESIGN  
DRAWING TITLE  
FLOOD STORAGE PLAN  
DESIGN LOT 429

PROJECT  
PROPOSED SUBDIVISION  
LOTS 429 AND 501  
ADDRESS  
KRUGER AVENUE, WINDANG  
NSW, 2528

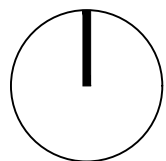PROJECT DETAILS  
DESIGN DM  
DRAWN DM  
DATE JUL 2021  
DRG SIZE A1  
SCALE 1:500  
PROJECT BA  
MGR  
WWW.JN.COM.AU  
N0210053  
C205 2






SITWORKS PLAN - WINDANG ROAD  
SCALE 1:100




SITWORKS PLAN - KRUGER AVENUE  
SCALE 1:100

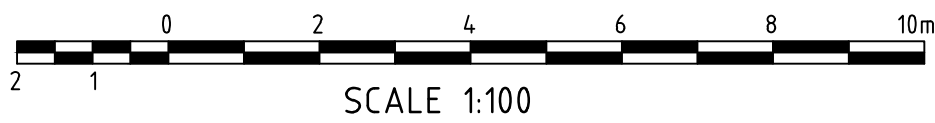

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AMDT	DATE	DESCRIPTION	BY
2	29.11.21	ISSUED FOR DA	DM
1	05.08.21	PRELIMINARY ISSUE	LAP

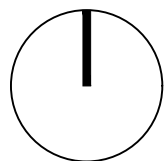


CLIENT  
WINDANG KRUGER UNIT TRUST  
STATUS  
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DISCIPLINE  
CIVIL DESIGN  
DRAWING TITLE  
SITWORKS PLAN

PROJECT  
PROPOSED SUBDIVISION  
LOTS 429 AND 501  
ADDRESS  
KRUGER AVENUE, WINDANG  
NSW, 2528

PROJECT DETAILS  
DESIGN DM  
DRAWN DM  
DATE JUL 2021  
DRG SIZE A1  
SCALE 1:150  
PROJECT BA  
MGR  
WWW.JN.COM.AU  
N0210053  
C300 2



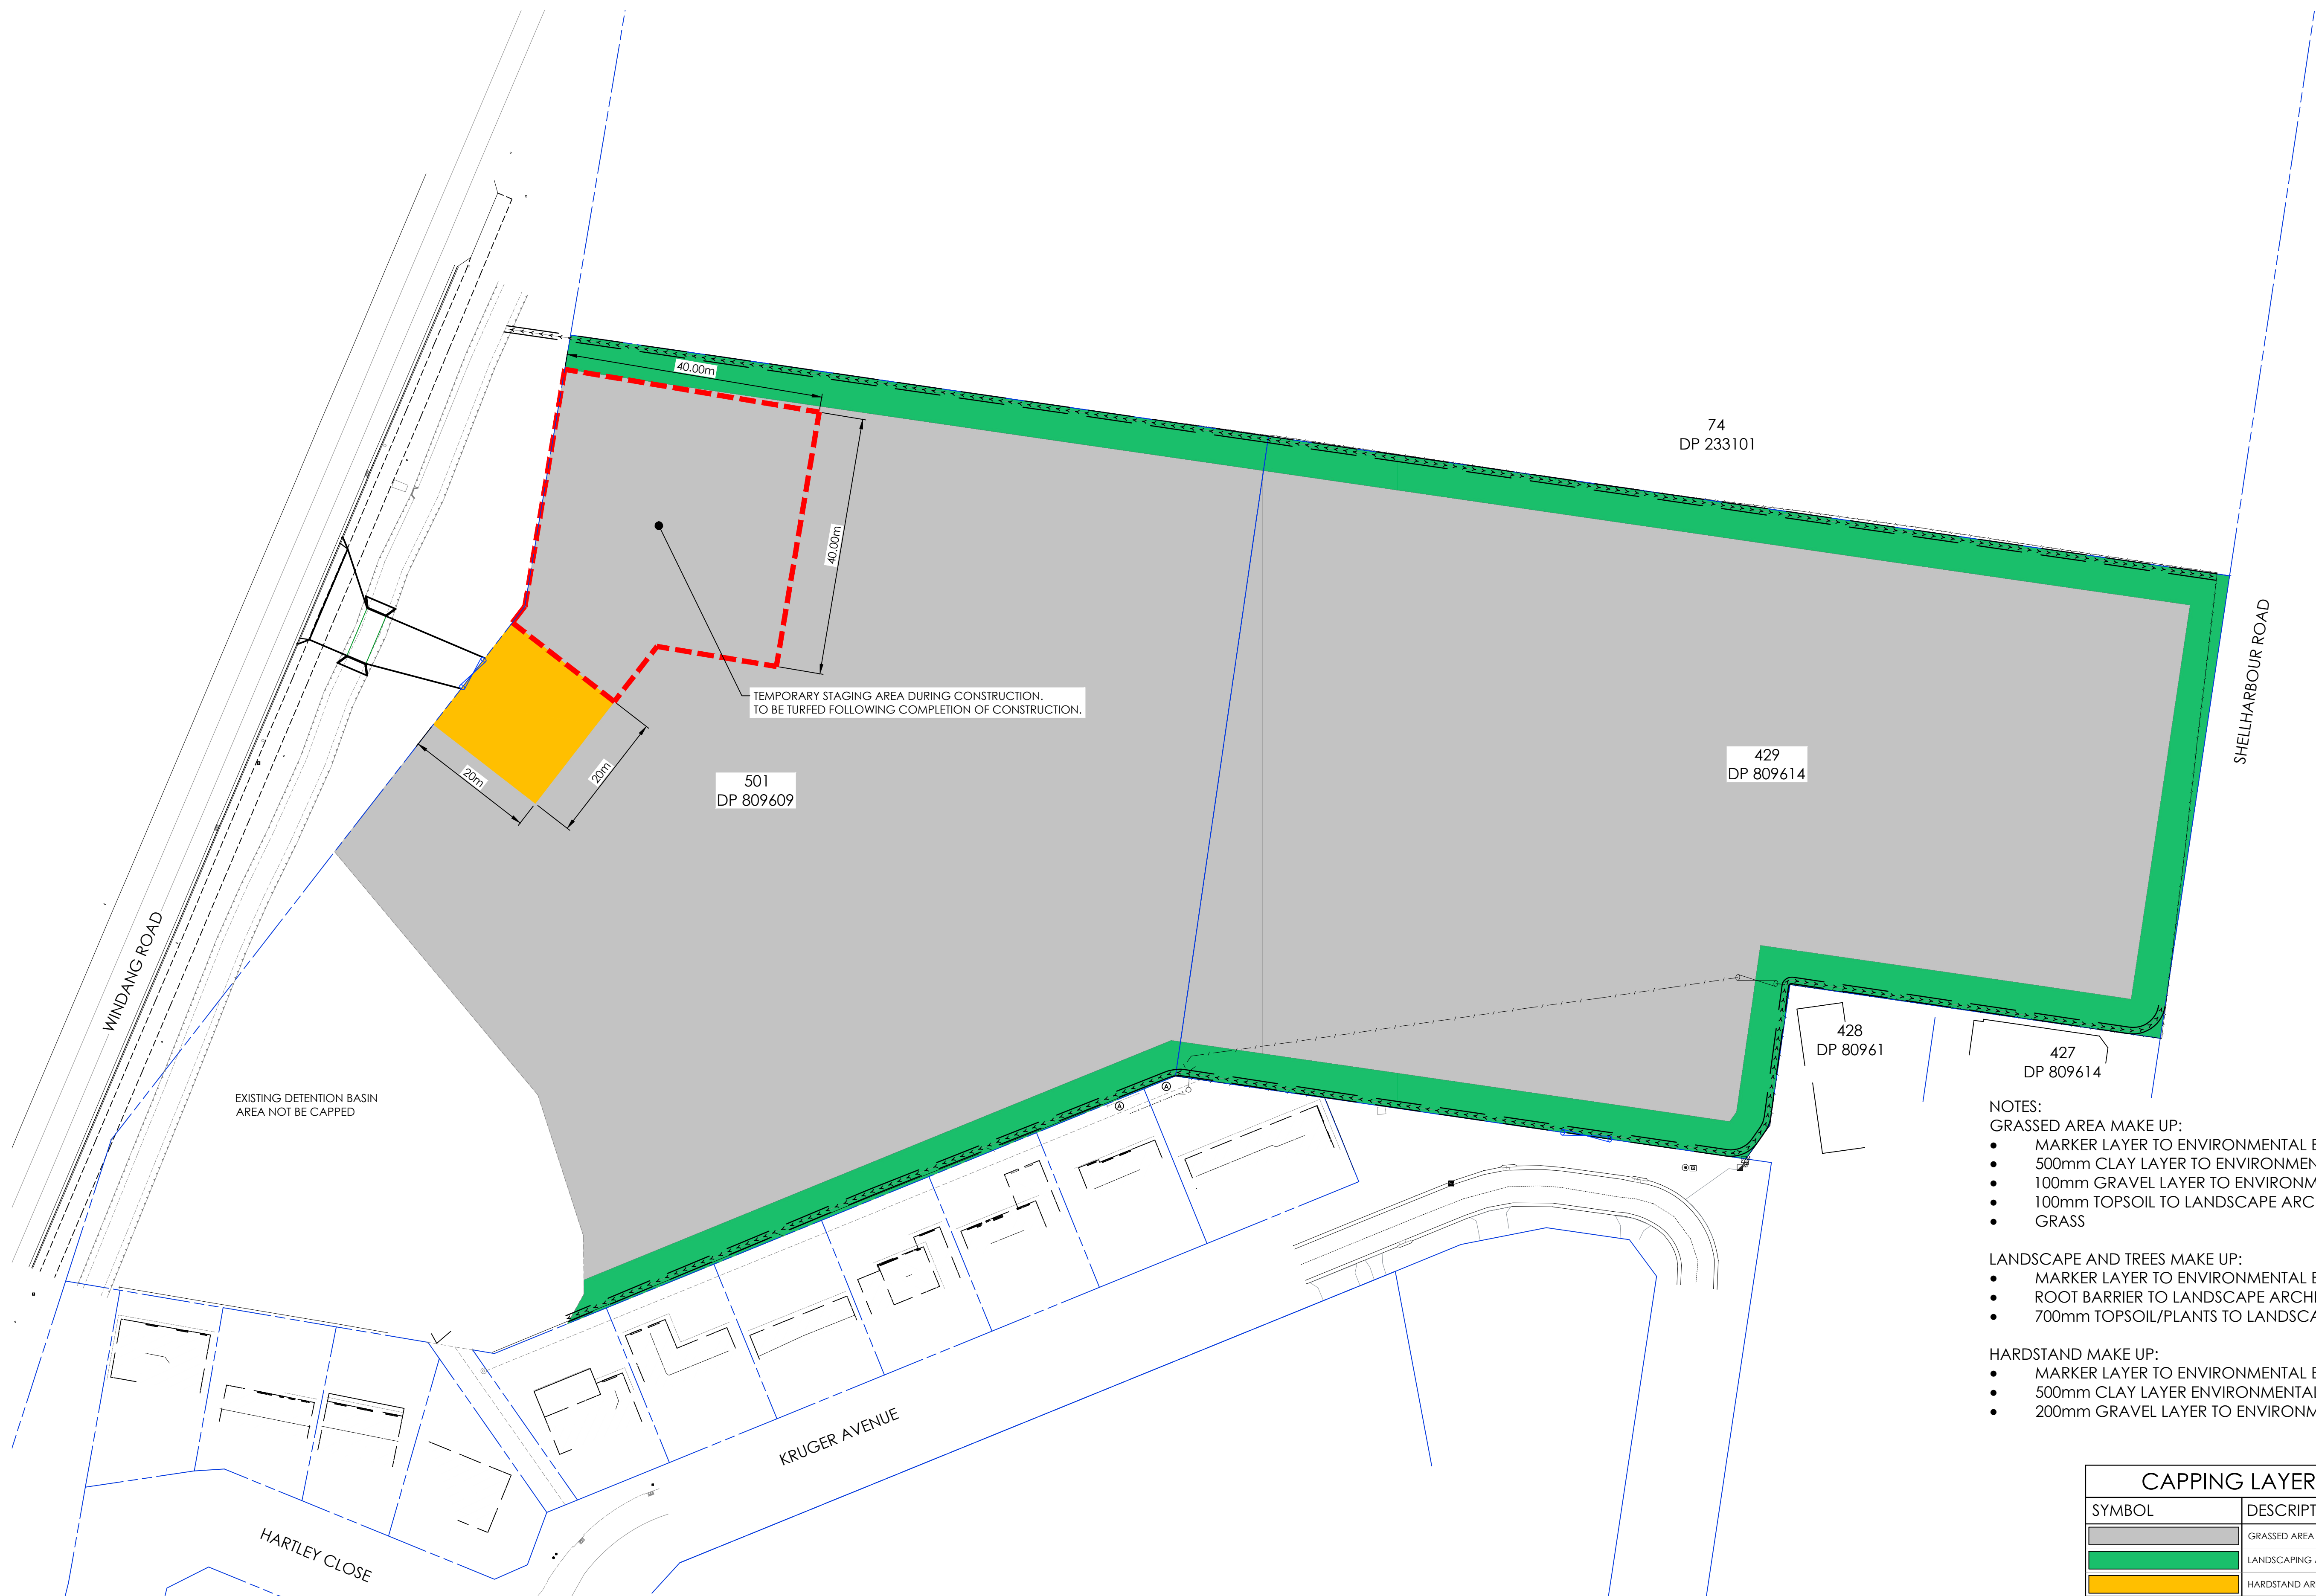


- NOTES:
- GRASSED AREA MAKE UP:
- MARKER LAYER TO ENVIRONMENTAL ENGINEERS SPECIFICATION
  - 500mm CLAY LAYER TO ENVIRONMENTAL ENGINEERS SPECIFICATION
  - 100mm GRAVEL LAYER TO ENVIRONMENTAL ENGINEERS SPECIFICATION
  - 100mm TOPSOIL TO LANDSCAPE ARCHITECTS SPECIFICATION
  - GRASS
- LANDSCAPE AND TREES MAKE UP:
- MARKER LAYER TO ENVIRONMENTAL ENGINEERS SPECIFICATION
  - ROOT BARRIER TO LANDSCAPE ARCHITECTS SPECIFICATION
  - 700mm TOPSOIL/PLANTS TO LANDSCAPE ARCHITECTS SPECIFICATION
- HARDSTAND MAKE UP:
- MARKER LAYER TO ENVIRONMENTAL ENGINEERS SPECIFICATION
  - 500mm CLAY LAYER ENVIRONMENTAL ENGINEERS SPECIFICATION
  - 200mm GRAVEL LAYER TO ENVIRONMENTAL ENGINEERS SPECIFICATION


CAPPING LAYER MAKE-UP LEGEND	
SYMBOL	DESCRIPTION
	GRASSED AREA
	LANDSCAPING AND TREES AREA
	HARDSTAND AREA

CAPPING LAYER MAKE UP LAYOUT PLAN

SCALE 1:500

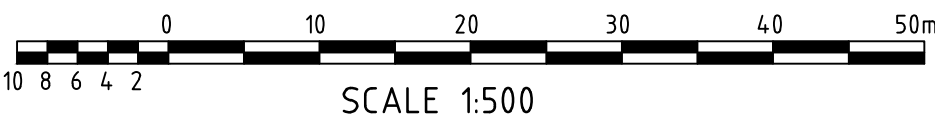

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2	09.12.21	RE-ISSUED FOR DA	DM
1	29.11.21	ISSUED FOR DA	DM

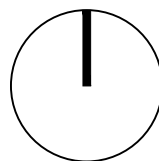

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DISCIPLINE  
CIVIL DESIGN

DRAWING TITLE  
CAPPING LAYER MAKE UP LAYOUT PLAN



PROJECT  
PROPOSED SUBDIVISION  
LOTS 429 AND 501

ADDRESS  
KRUGER AVENUE, WINDANG  
NSW, 2528

PROJECT DETAILS  
DESIGN DM  
DRAWN DM  
DATE NOV 2021  
DRG SIZE A1  
SCALE 1:500  
PROJECT BA  
MGR  
WWW.JN.COM.AU


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C301 2



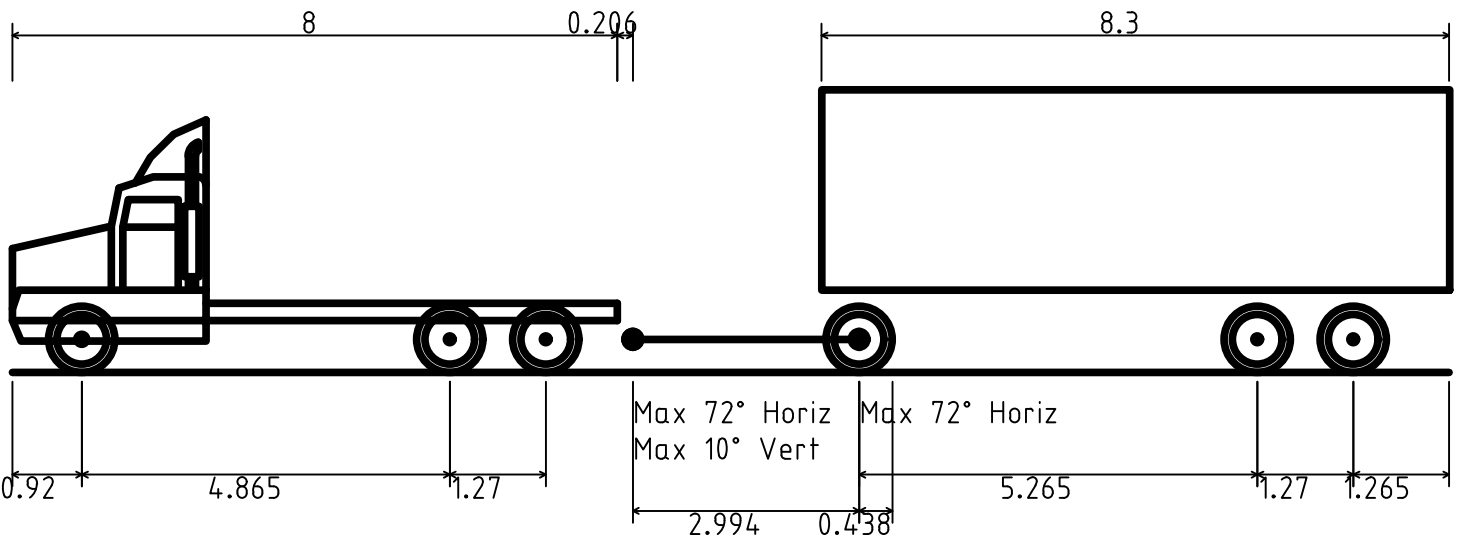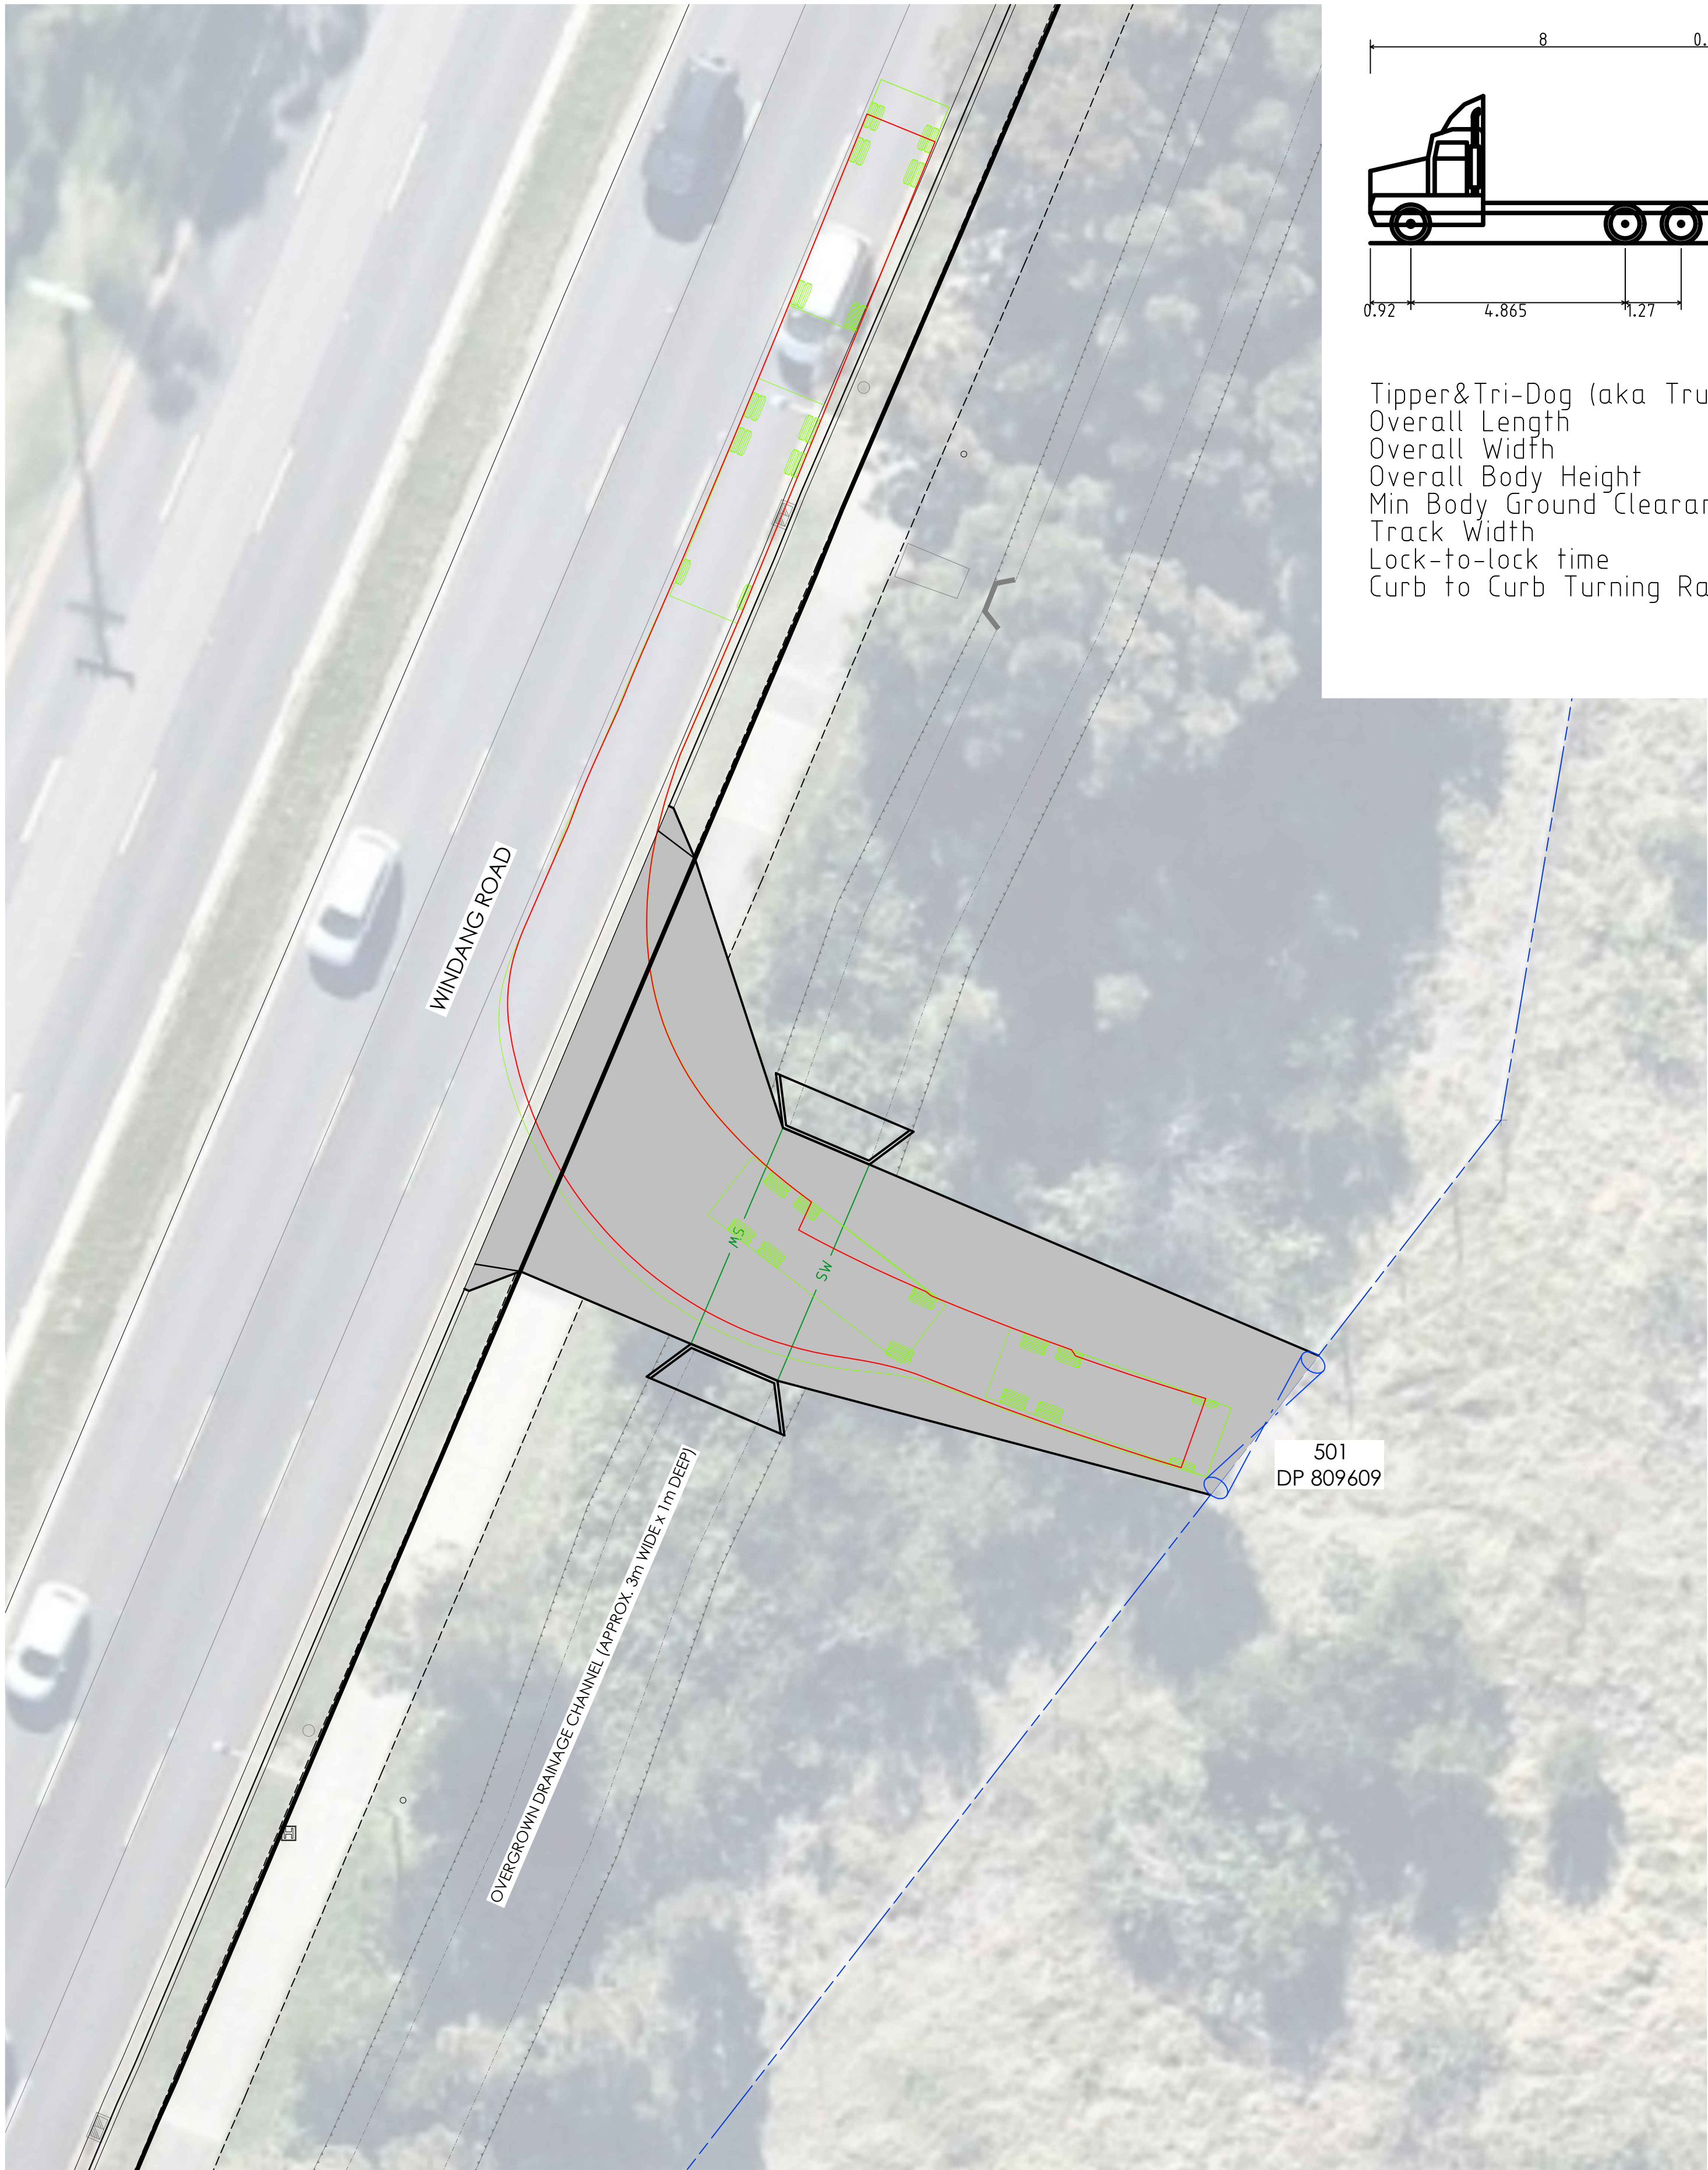


Tipper&Tri-Dog (aka Truck&Dog)  
Overall Length 19.000m  
Overall Width 2.500m  
Overall Body Height 3.738m  
Min Body Ground Clearance 0.417m  
Track Width 2.500m  
Lock-to-lock time 5.00s  
Curb to Curb Turning Radius 12.640m


VEHICLE TURNING PATH PLAN - ENTRY  
SCALE 1:150

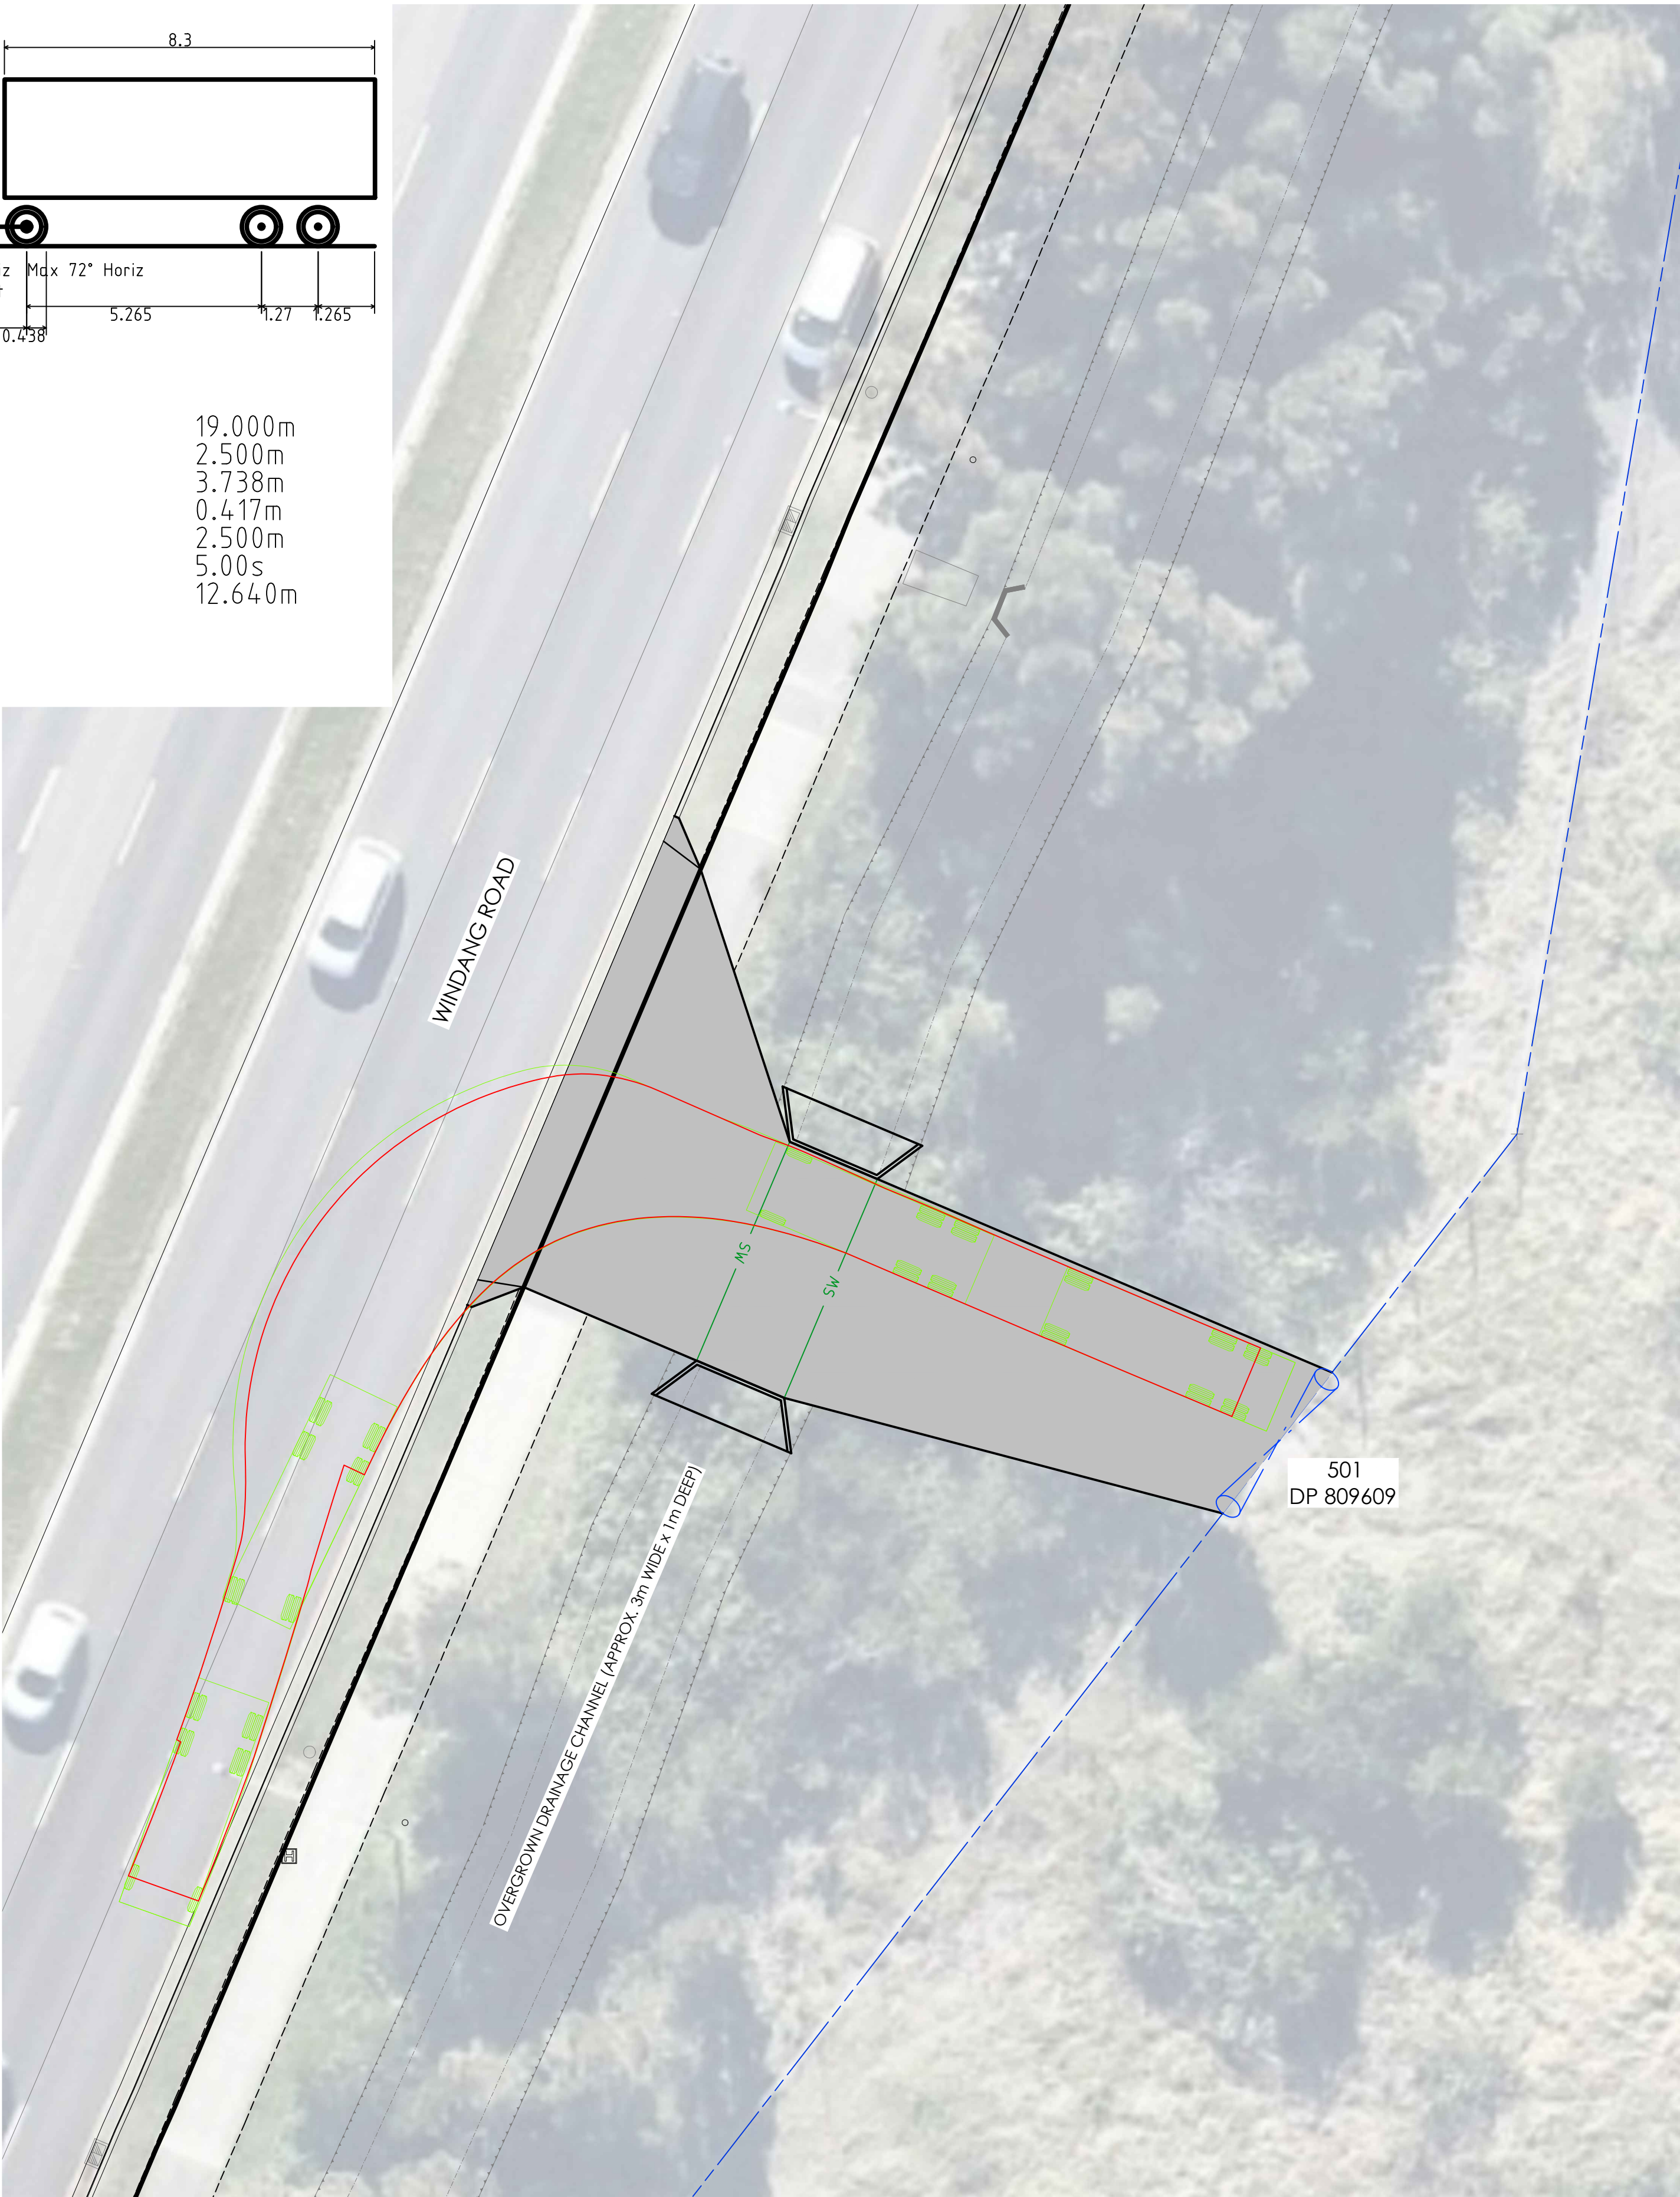

VEHICLE TURNING PATH PLAN - EXIT  
SCALE 1:150

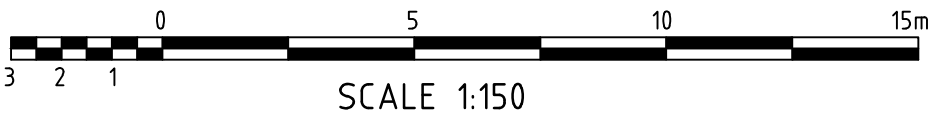

NOT TO BE USED FOR CONSTRUCTION			
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2	29.11.21	ISSUED FOR DA	DM
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STATUS  
PRELIMINARY DA ISSUE

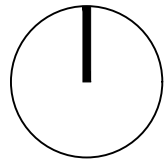
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DISCIPLINE  
CIVIL DESIGN  
DRAWING TITLE  
VEHICLE TURNING PATH  
PLAN - SHEET 1


PROJECT  
PROPOSED SUBDIVISION  
LOTS 429 AND 501  
ADDRESS  
KRUGER AVENUE, WINDANG  
NSW, 2528

PROJECT DETAILS  
DESIGN DM  
DRAWN DM  
DATE JUL 2021  
DRG SIZE A1  
SCALE 1:150  
PROJECT BA  
MGR  
WWW.JN.COM.AU  
N0210053  
C400 2




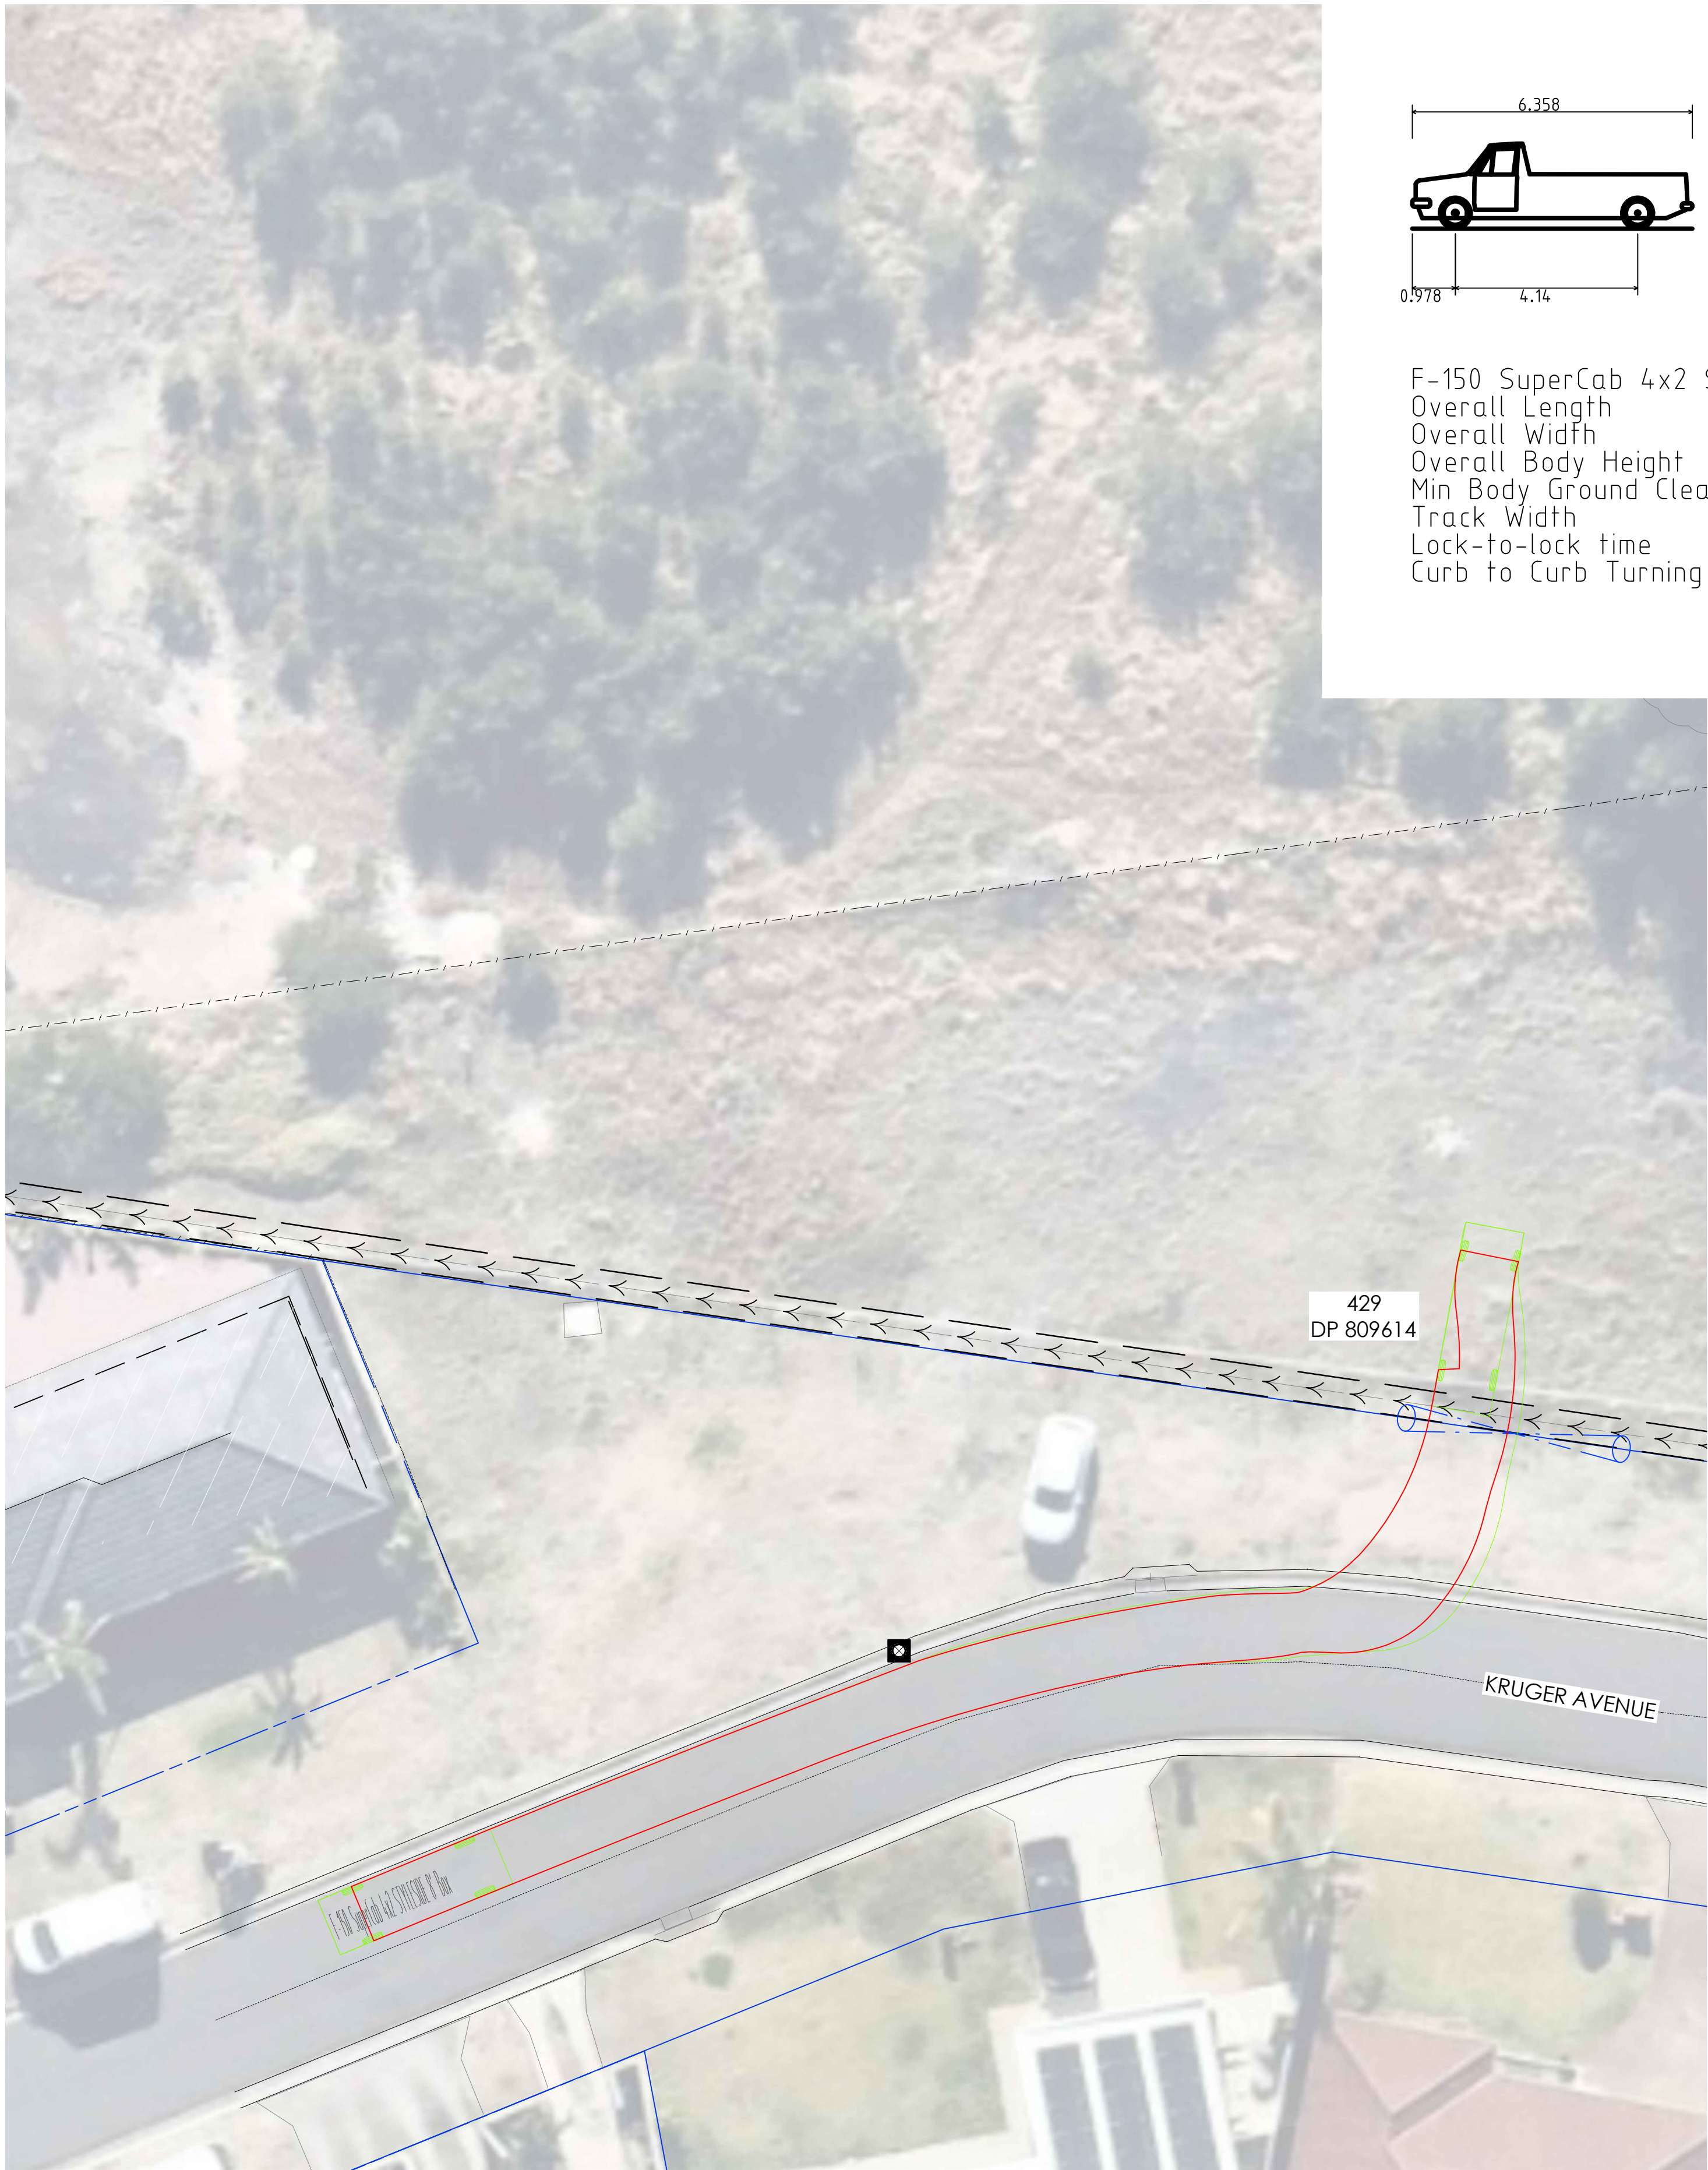


VEHICLE TURNING PATH PLAN - ENTRY  
SCALE 1:150

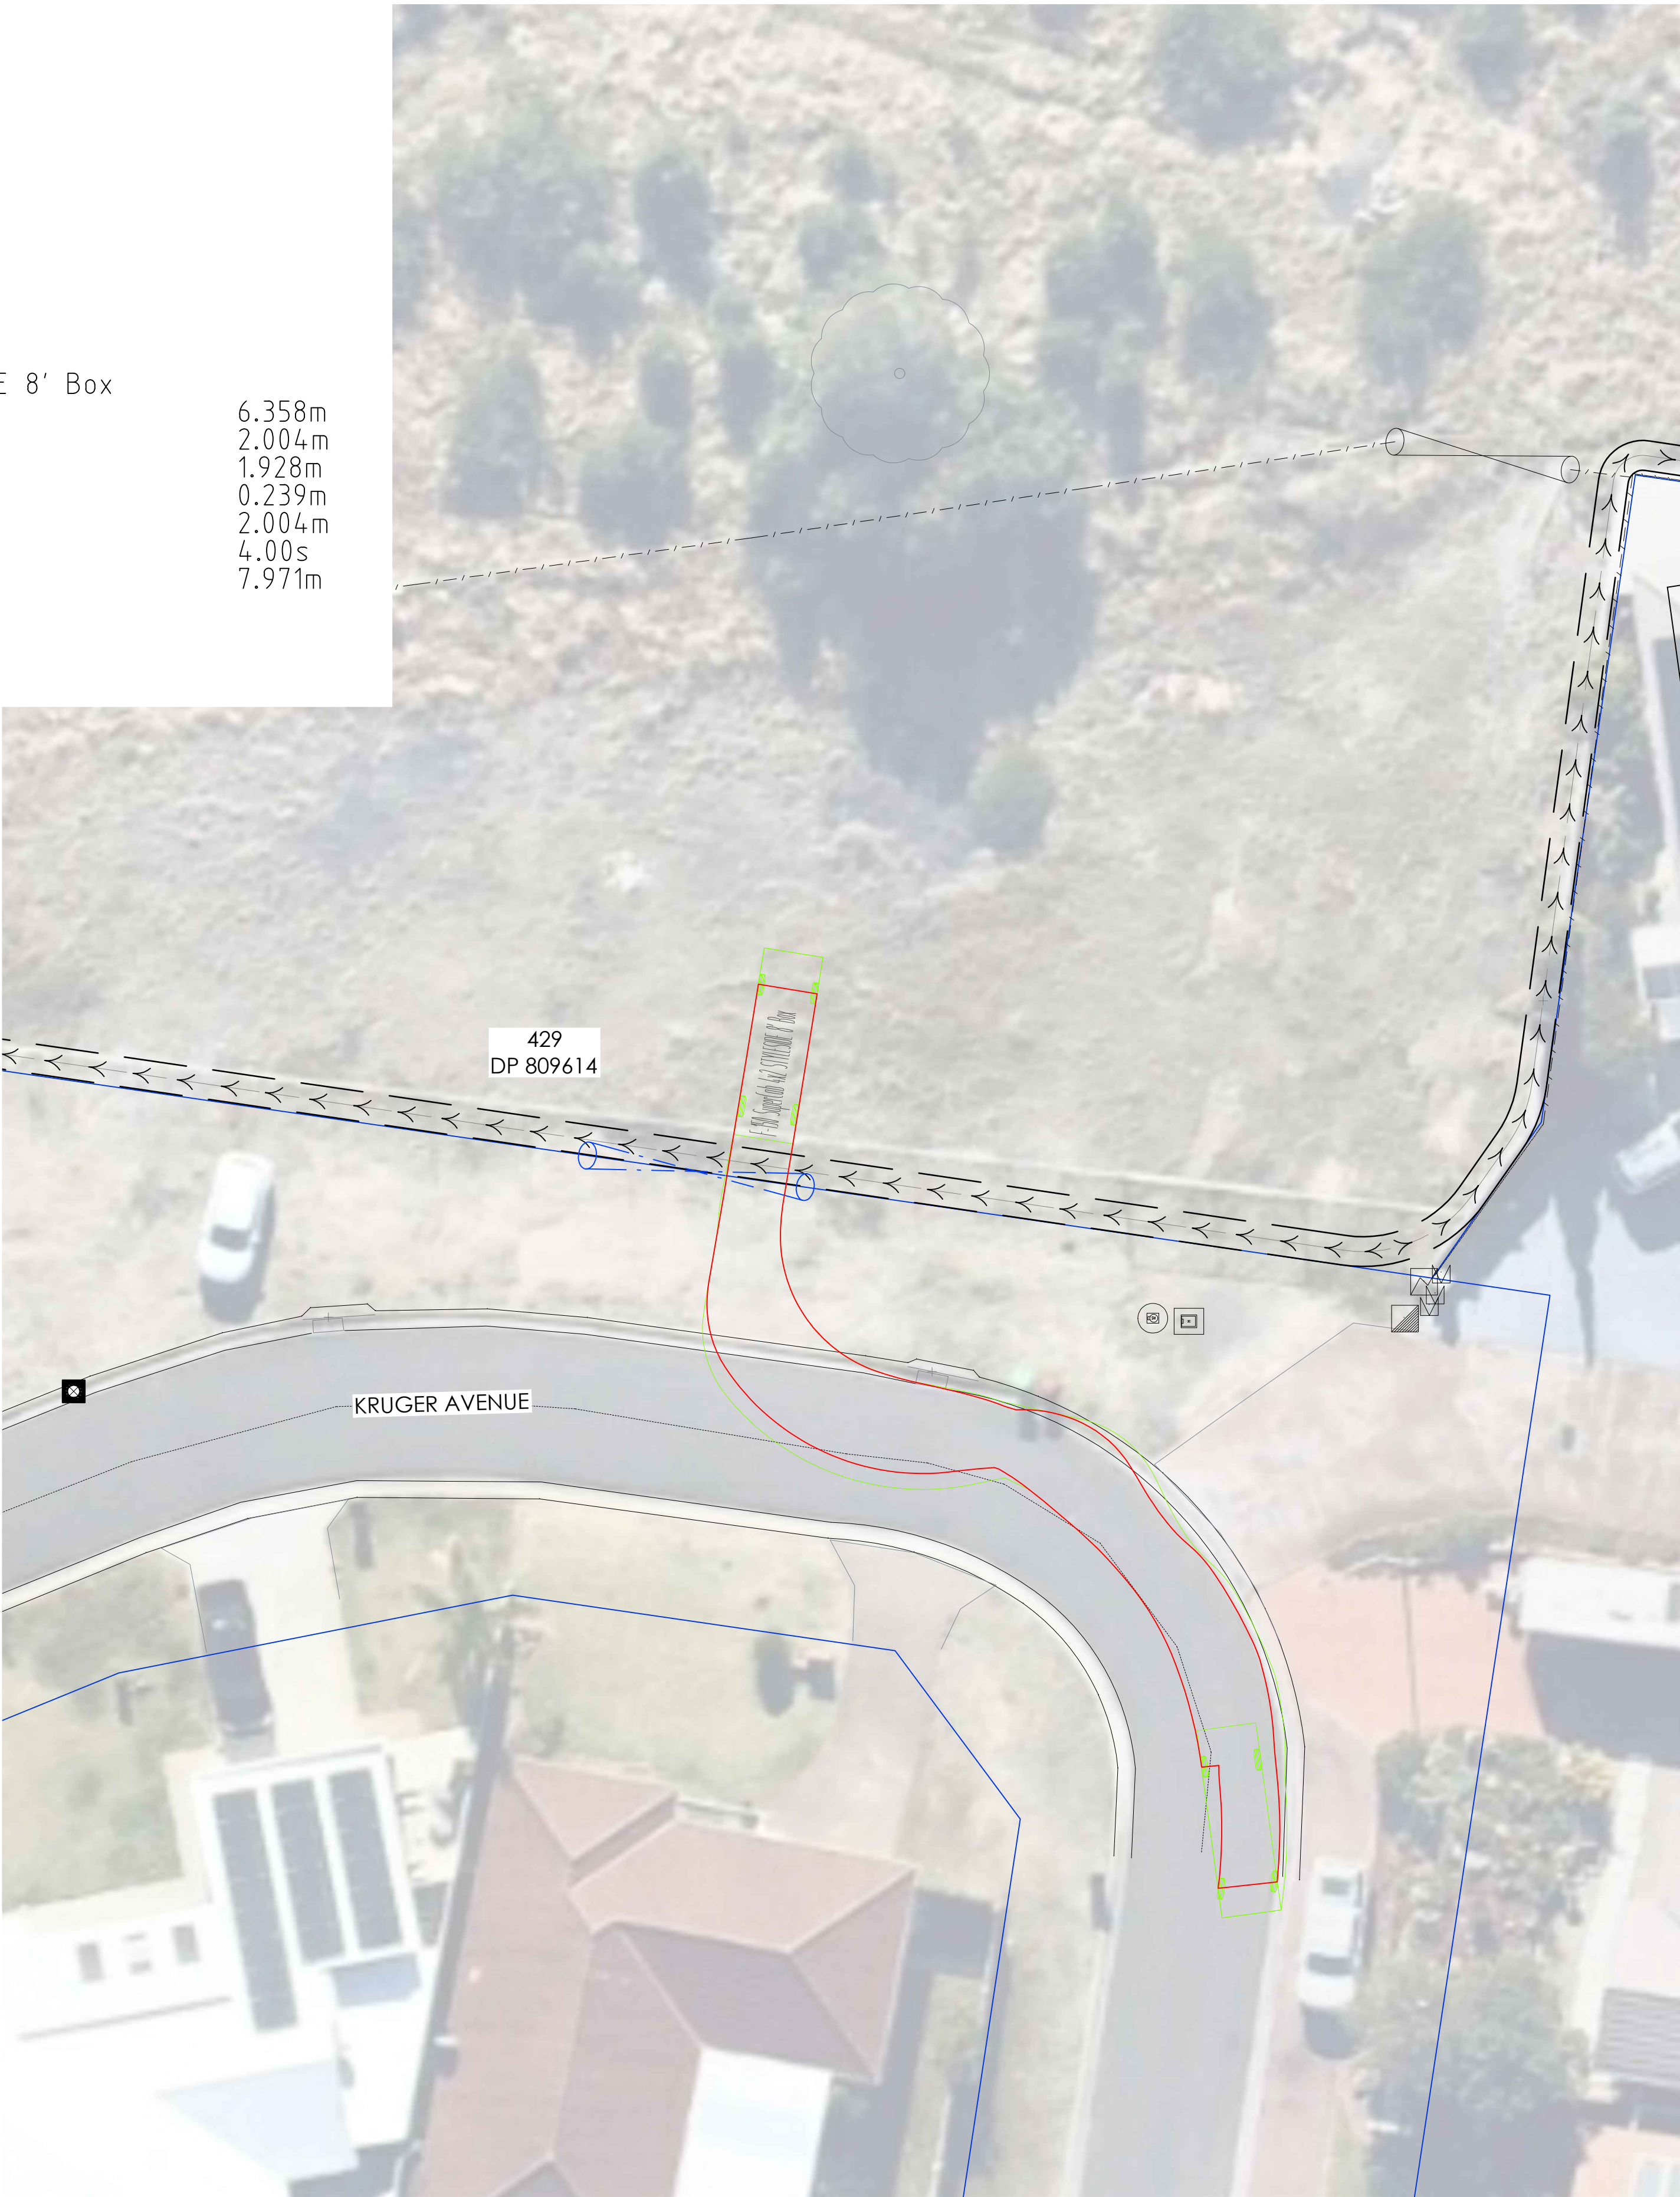

VEHICLE TURNING PATH PLAN - EXIT  
SCALE 1:150

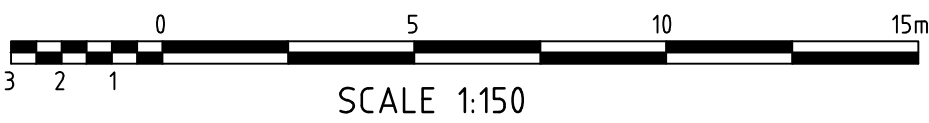

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DISCIPLINE  
CIVIL DESIGN  
DRAWING TITLE  
VEHICLE TURNING PATH  
PLAN - SHEET 2

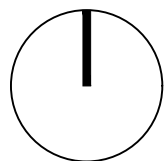PROJECT  
PROPOSED SUBDIVISION  
LOTS 429 AND 501  
ADDRESS  
KRUGER AVENUE, WINDANG  
NSW, 2528

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DESIGN DM  
DRAWN DM  
DATE JUL 2021  
DRG SIZE A1  
SCALE 1:150  
PROJECT BA  
MGR  
WWW.JN.COM.AU  
N0210053  
C401 2