




PROJECT PARAMETERS FOR SITE

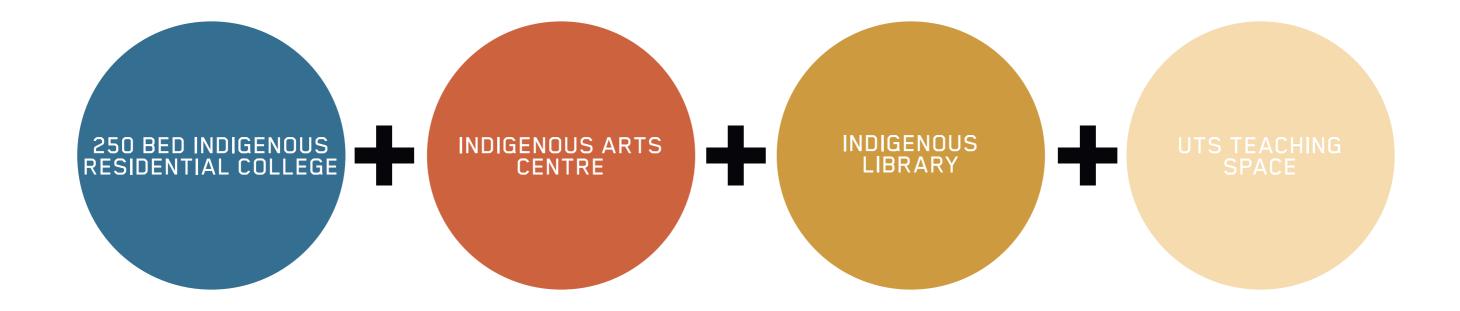


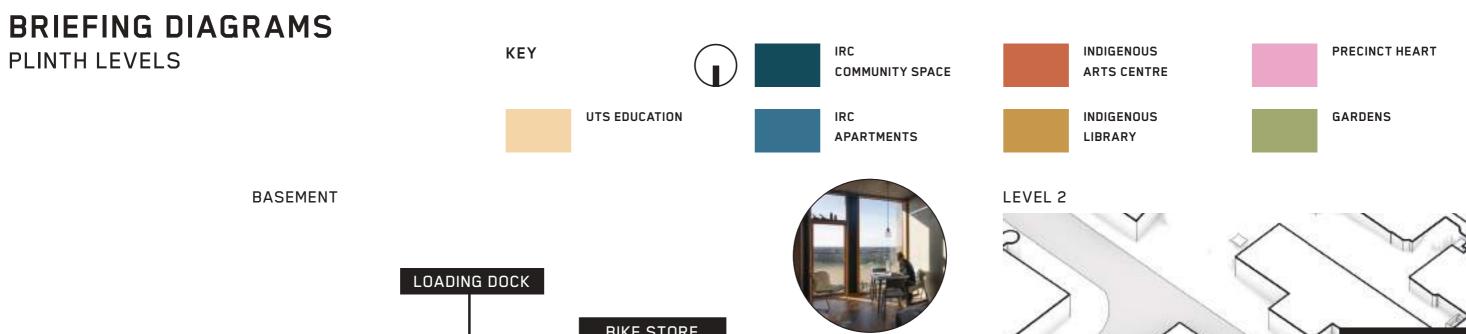




IRC COMMUNAL SPACES

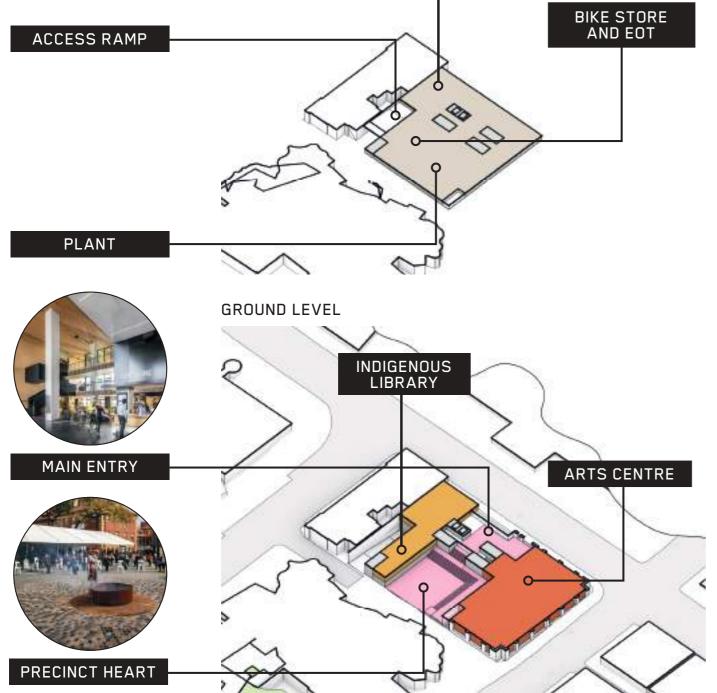

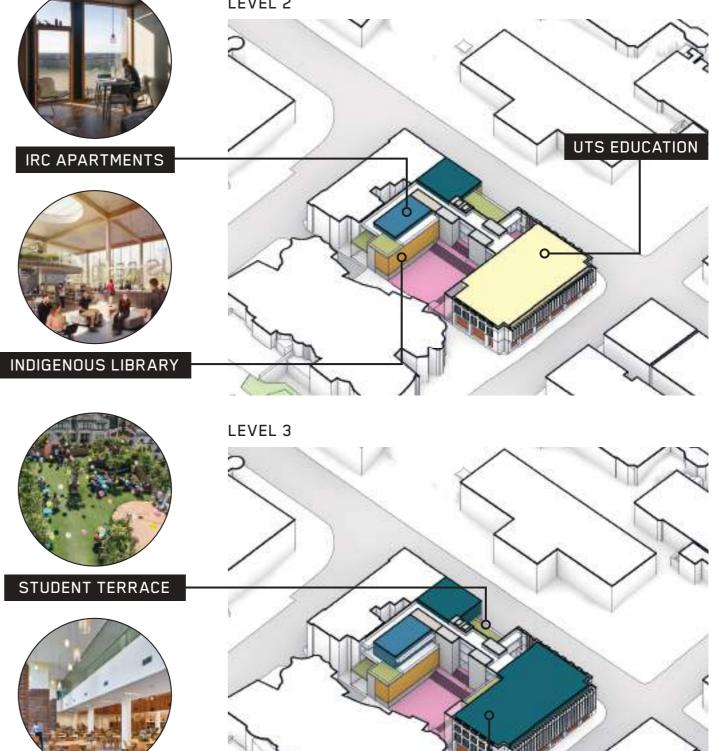

4

BVN / UTS INDIGENDUS RESIDENTAL COLLEGE / 27 AUGUST 2021

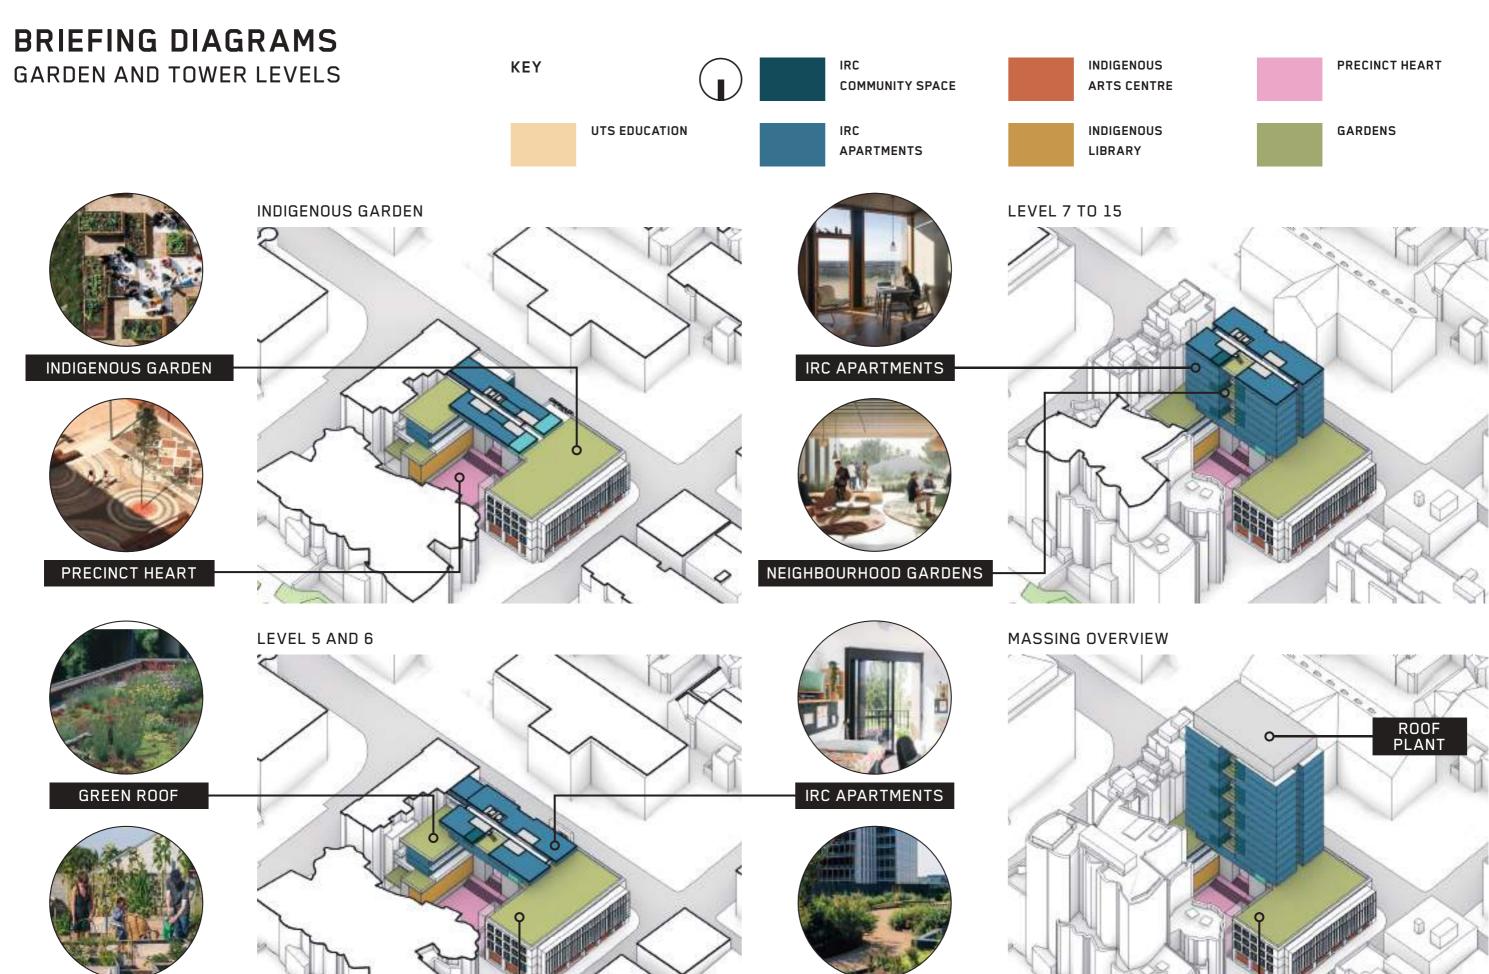

INDIGENOUS GARDEN

INDIGENOUS GARDEN

PLANS

UTS INDIGENOUS RESIDENTIAL COLLEGE



DRAWING LIST

DRAWING LIST		
DRAWING NO.	SCALE @ A3	DRAWING NAME
GA PLANS		
AR-B10 00-00	1:250	GA PLAN - GROUND LEVEL
AR-B10 01-00	1:250	GA PLAN - LEVEL 01
AR-B10 02-00	1:250	GA PLAN - LEVEL 02
AR-B10 03-00	1:250	GA PLAN - LEVEL 03
AR-B10 04-00	1:250	GA PLAN - HERITAGE ROOF GARDEN
AR-B10 05-00	1:250	GA PLAN - LEVEL 05
AR-B10 NL-00	1:250	GA PLAN - TYPICAL TOWER LEVEL
AR-B10 NL-00	1:500	GA PLAN - APARTMENT MIX SUMMARY
AR-B10 16-00	1:250	GA PLAN - ROOF LEVEL
AR-B10 B1-00	1:250	GA PLAN - BASEMENT 1
ELEVATIONS		
AR-C10 XX-01	1:300	ELEVATION - OMNIBUS LANE
AR-C10 XX-02	1:300	ELEVATION - MARY ANN STREET
AR-C10 XX-03	1:300	ELEVATION - HARRIS STREET
SECTIONS		
AR-D10 XX-01	1:300	GA SECTION - 01
AR-D10 XX-02	1:300	GA SECTION - 02
AR-D10 XX-03	1:300	GA SECTION - 03



ARCHITECTS REGISTRATION BOARD / NOMINATED ARCHITECTS


Telephone +61 7 3852 2525 Facsimile +61 7 3852 2544 www.bvn.com.au

INTELLECTUAL PROPERTY

IN TELLECTION. FROM TECHNE TO UNESS OTHERWISE AGREED IN WINTIGOAL RIGHTS TO THIS DOCUMENT ARE SUBJECT TO PARIMENT IN FULL OF ALL BRIV CHARGES THIS DOCUMENT WAY OUT. PARIMENT IN FULL OF ALL BRIV CHARGES THIS DOCUMENT WAY OUT. HAS SEEN (SEETE AND DOCUMENT WAY NOT SEE OTHERWISE SIED OR COPIED. ANY UNMAINTERISED USE OF THE COMMENTS AT THE USER'S SOLE RISK AND WITHOUT LIMITING SINGER SINGTH ST. AT THE USER'S SOLE RISK AND WITHOUT LIMITING SINGER SINGTH SINGTH ST. WE USER RELEASES AND INDEMNIFIES BIN'S FROM AND AGAINST ALL LOSS SO ARISING.

NOTE:

INV I E
CONTRACTOR TO CHECK AND VERIFY ALL DIMENSIONS ON SITE
PRIOR TO COMMENCEMENT OF WORK OR PREPARATION OF SHOP
DRAWINGS. DO NOT SCALE THIS DRAWING

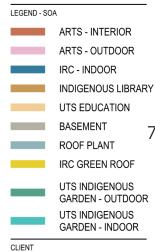

UNIVERSITY OF TECHNOLGY

SYDNEY PROJECT MANAGER

GA PLAN BASEMENT 1

DRAWING NUMBER AR-B10 B1-00

PROJECT INDIGENOUS RESIDENTIAL COLLEGE BVN PROJECT NUMBER 1901013 PROJECT NORTH TRUE NORTH SCALE 1:250 @ A3 0 2500 7500 STATUS DRAWING

ISSUE N

ARCHITECTS REGISTRATION BOARD / NOMINATED ARCHITECTS

Telephone +61 7 3852 2525 Facsimile +61 7 3852 2544 www.bvn.com.au

INTELLECTUAL PROPERTY

NOTE



PROJECT

SYDNEY

PROJECT MANAGER

INDIGENOUS RESIDENTIAL COLLEGE BYN PROJECT NUMBER

1901013

PROJECT NORTH NORTH

BOALE 1:250 @ A3 0 2500 7500

ISSUE ≥

STATUS

DRAWING

GA PLAN GROUND LEVEL

DRAWING NUMBER AR-B10 00-00



Facsimile +61 7 3852 2544

WWW.bvn.com.au

INTELLECTUAL PROPERTY

COPFIRINT BWI ARCHITECTURE PTY LIMITED LINLESS OTHERWISS
ARGERD IN WINTELLAR, RIGHTS TO THIS DOCUMENT ARE SUBJECT TO
PATIBLET IN FILL OF ALL BWI CHARGES, THIS DOCUMENT WAR SUBJECT IN
PATIBLET IN FILL OF ALL BWI CHARGES, THIS DOCUMENT WAR TOWN
HAS BEED ORDERED AND OUTPED. AND PROJECT FOR WHICH IT
HAS BEED ORDERED AND OUTPED. HAS DOCUMENT BY A THE
LUSER'S DUE RISK. AND WITHOUT LIMITING BWINT BROTH THE
LUSER'S DUE RISK. AND WITHOUT LIMITING BWINT BROTH STHE USER
RELEASES AND INDEMNIFIES BWIN FROM AND AGAINST ALL LOSS SO
ARBIND.

NOTE

CONTRACTOR TO CHECK AND VERIFY ALL DIMENSIONS ON SITE
PRIOR TO COMMENCEMENT OF WORK OR PREPARATION OF SHOPD
DRAWINGS. DO NOT BUELT BYSE PRAINTS.

Telephone +61 7 3852 2525

ARTS - INTERIOR
ARTS - OUTDOOR
IRC - INDOOR
INDIGENOUS LIBRARY
UTS EDUCATION
BASEMENT
ROOF PLANT
IRC GREEN ROOF
UTS INDIGENOUS
GARDEN - OUTDOOR
UTS INDIGENOUS
GARDEN - INDOOR
CLIENT

UNIVERSITY OF TECHNOLGY

SYDNEY

PROJECT MANAGER


PROJECT
INDIGENOUS RESIDENTIAL
COLLEGE
BVN PROJECT NUMBER
1901013
TRUE
NORTH
PROJECT
NORTH
SCALE
1:250 @ A3
0 2500 7500
STATUS


PLANS LEVEL 1

ISSUE A

DRAWING

DRAWING NUMBER
AR-B10 01-00

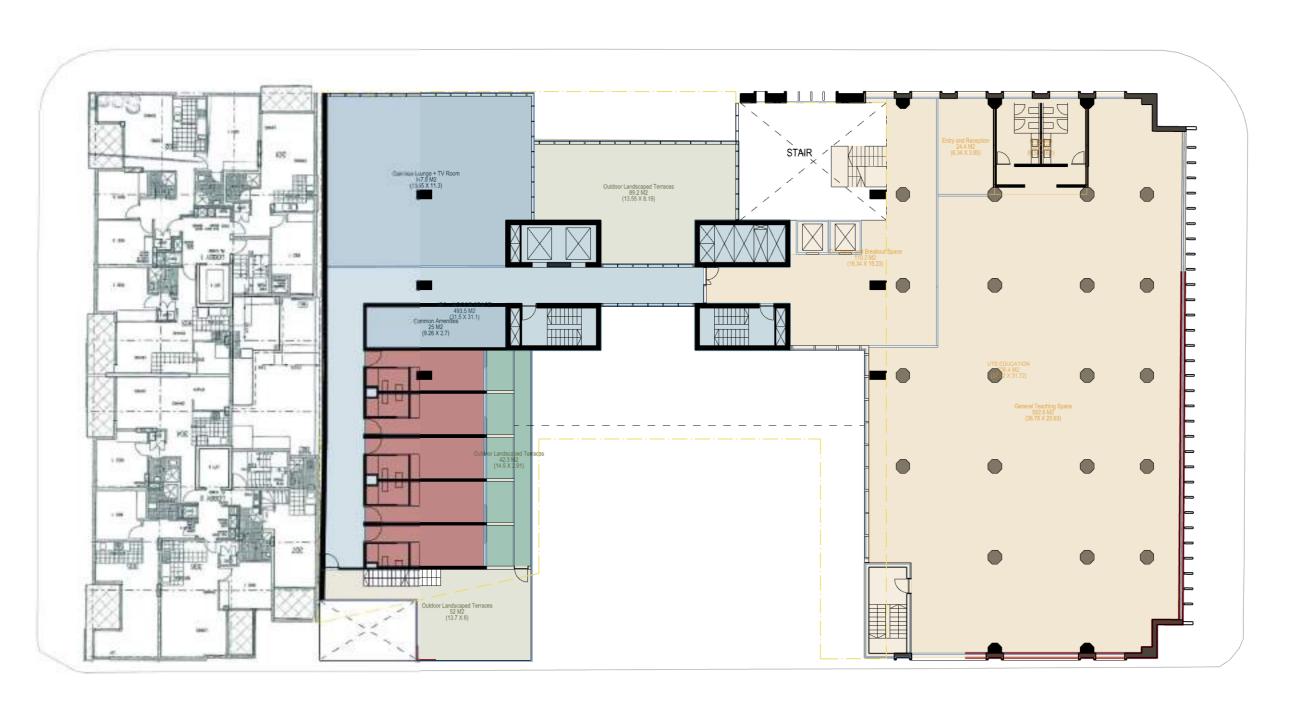

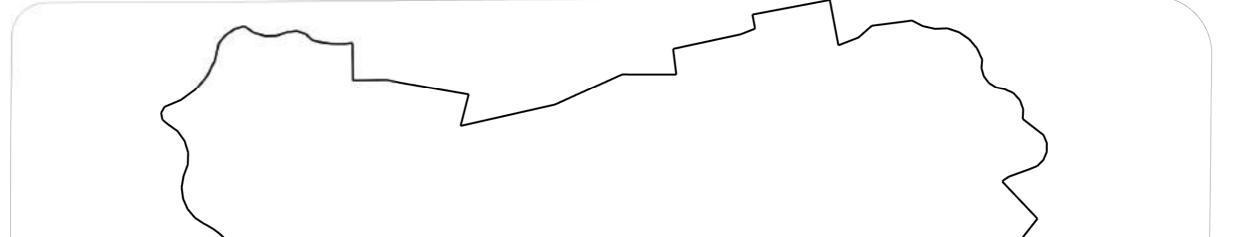

NOTE

Telephone +61 7 3852 2525 Facsimile +61 7 3852 2544 www.bvn.com.au INTELLECTUAL PROPERTY

LEGEND - SOA ARTS - INTERIOR ARTS - OUTDOOR IRC - INDOOR INDIGENOUS LIBRARY UTS EDUCATION BASEMENT 10 ROOF PLANT IRC GREEN ROOF UTS INDIGENOUS GARDEN - OUTDOOR UTS INDIGENOUS GARDEN - INDOOR CLIENT

SYDNEY PROJECT MANAGER

UNIVERSITY OF TECHNOLGY

PROJECT INDIGENOUS RESIDENTIAL COLLEGE BVN PROJECT NUMBER 1901013 TRUE NORTH PROJECT NORTH SCALE 1:250 @ A3 0 2500 7500


DRAWING

STATUS

PLANS LEVEL 2

DRAWING NUMBER AR-B10 02-00

ISSUE N

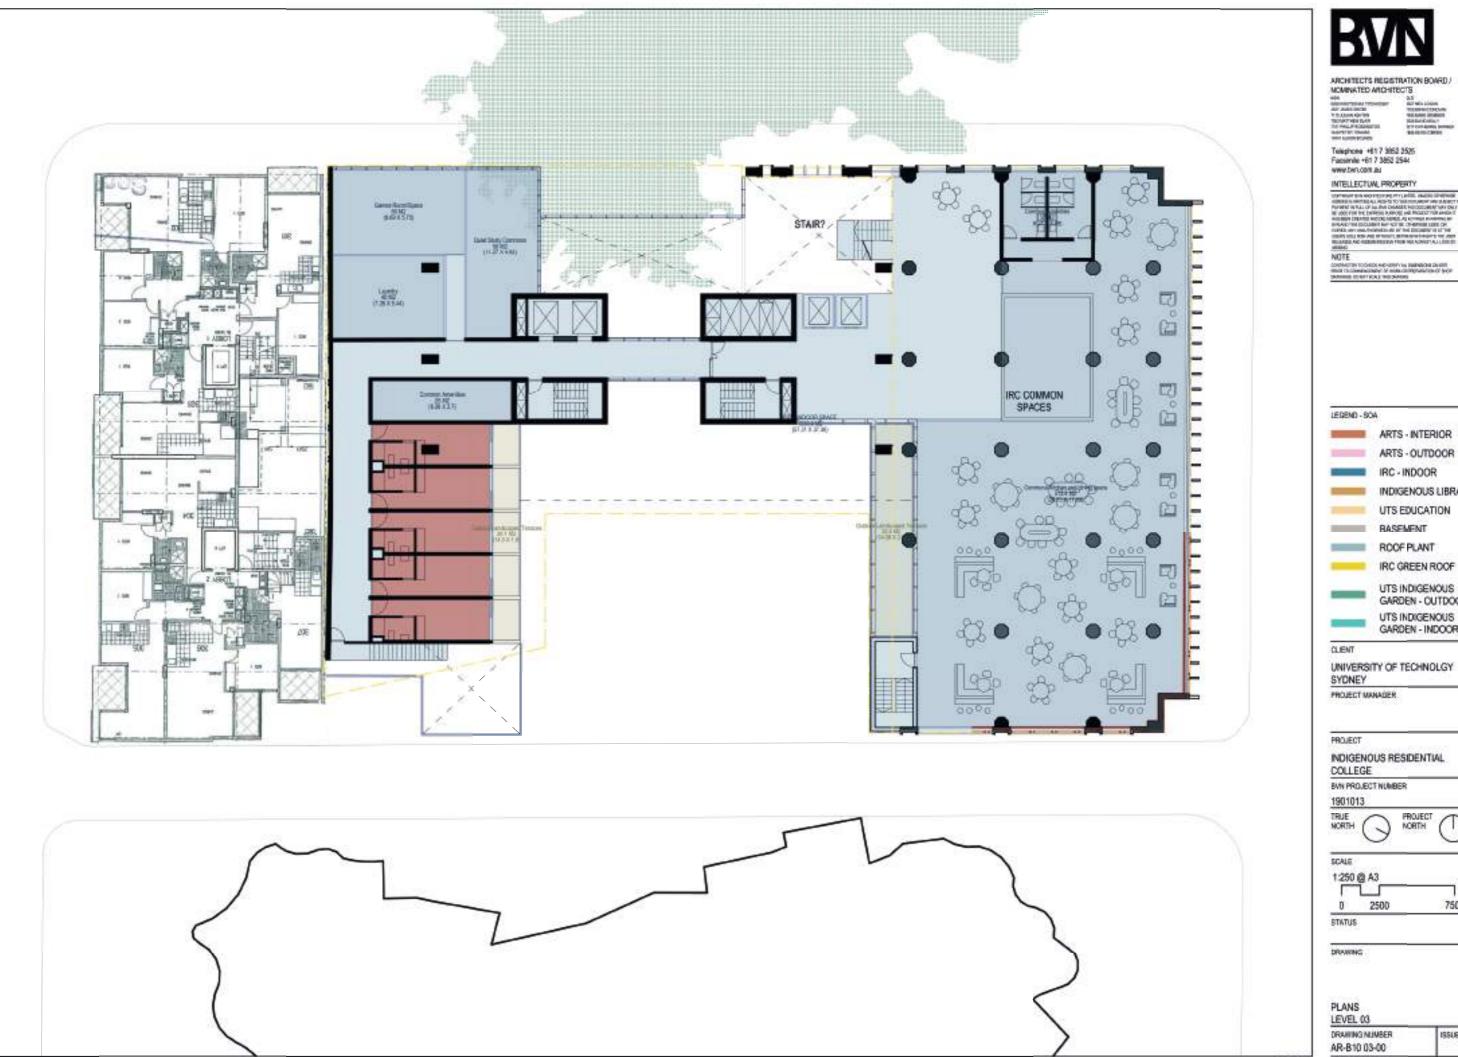

ARCHITECTS REGISTRATION BOARD / MOMENATED ARCHITECTS

Telephone +617 3852 2525

INTELLECTUAL PROPERTY

NOTE

LEGEND - SOA ARTS - INTERIOR ARTS - OUTDOOR IRC - INDOOR INDIGENOUS LIBRARY UTS EDUCATION BASEMENT 11 ROOF PLANT IRC GREEN ROOF UTS INDIGENOUS GARDEN - OUTDOOR UTS INDIGENOUS GARDEN - INDOOR

INDIGENOUS RESIDENTIAL COLLEGE

1901013

PROJECT NORTH TRUE NORTH

SCALE 1250 @ A3 7500 2500 STATUS

ISSUE B

PLANS LEVEL 03

DRAWING NUMBER AR-B10 03-00



ARCHITECTS REGISTRATION BOARD / NOMINATED ARCHITECTS

NISW

QL

SESS INIOTISCHA TITCHKOSKY

4637 JAMES GRODE

1715 JALIAN SOFTON

705 BRATH CORRAINER

5020 RAVID RELILY

5175 PHILLE PROSINGTON

7459 PETER TITMISS

10467 ALISTON BOUNDIS

506 REVIN OBRIEN

507 CATHERINE SKINICE

10467 ALISTON BOUNDIS

Telephone +61 7 3852 2525 Facsimile +61 7 3852 2544 www.bvn.com.au

INTELLECTUAL PROPERTY

ARTS - INTERIOR ARTS - OUTDOOR

IRC - INDOOR

INDIGENOUS LIBRARY

BASEMENT

IRC GREEN ROOF

12

UTS INDIGENOUS GARDEN - OUTDOOR

UTS INDIGENOUS

GARDEN - INDOOR

UNIVERSITY OF TECHNOLGY SYDNEY

PROJECT MANAGER

INDIGENOUS RESIDENTIAL

BVN PROJECT NUMBER

PROJECT NORTH

1:250 @ A3

0 2500


7500

ISSUE A

HERITAGE ROOF GARDEN

DRAWING NUMBER

AR-B10 04-00

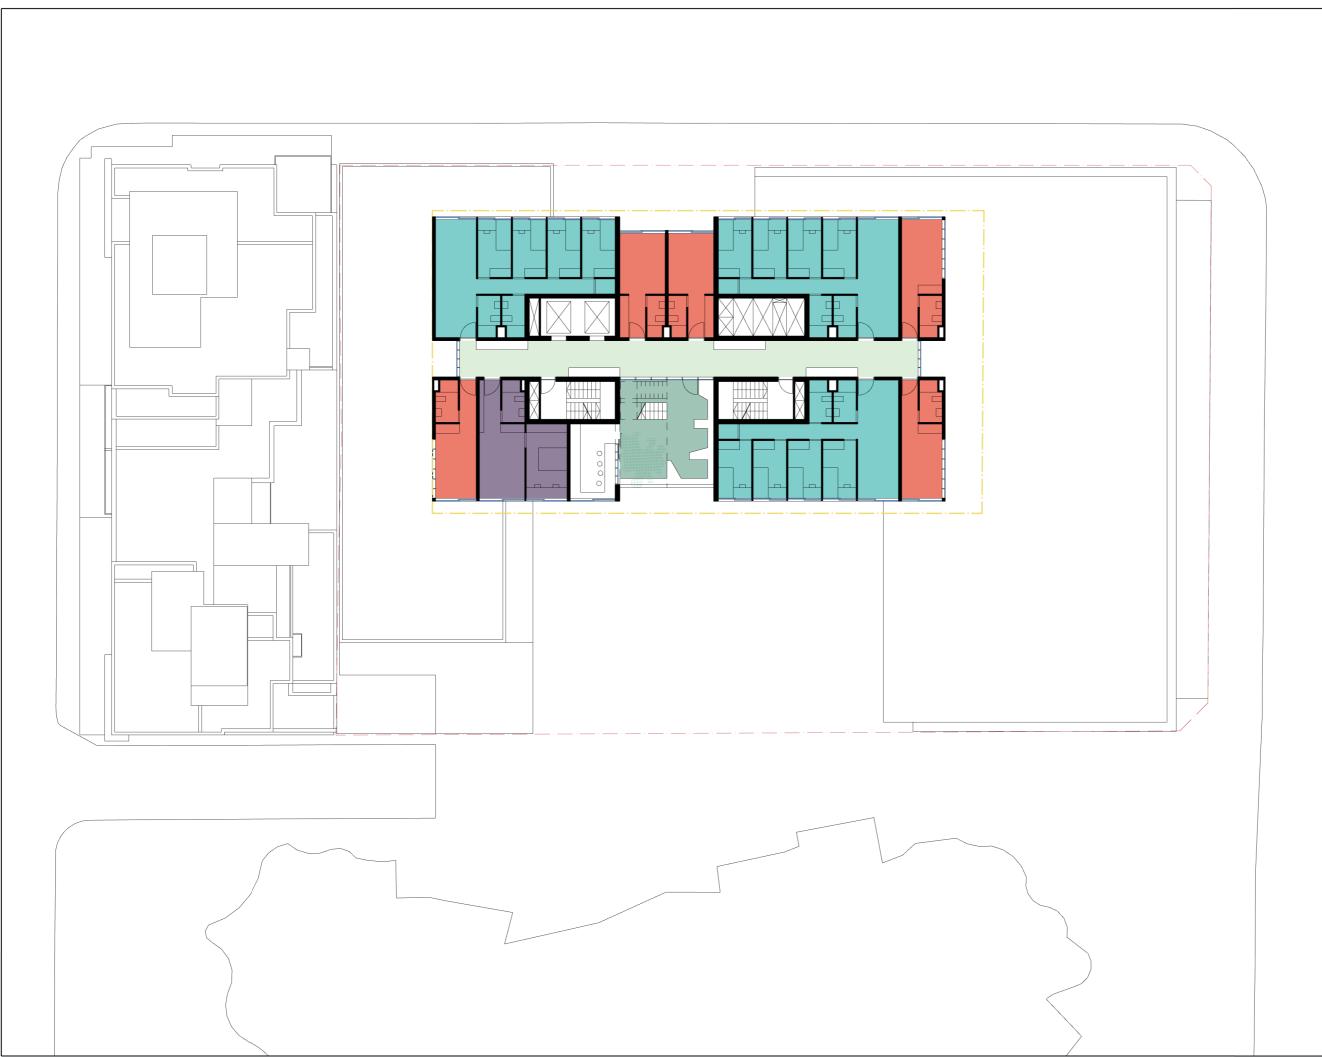

Telephone +61 7 3852 2525 Facsimile +61 7 3852 2544 www.bvn.com.au

INTELLECTUAL PROPERTY

IN TELLEC I UAL PROPERTY IN

COPPIGIST ON ACCHITECTURE FOR INITIZE UNLESS OTHERWISE
AGREDO IN WITHING ALL RIGHTS TO THIS DOCUMENT ARE SIRBERTY
PAYMENT IN THAIL OF ALL BING HAVERSEET BOOLOWSHET WAY ONLY
BE USED FOR THE EXPRESS PURPOSE AND PROJECT FOR WHIGHT IN

HAS BEEN (REFERD AND DELINERS, AND NIFIED IN WITHING BY
BINAND THIS DOCUMENT BAY NOT BE OTHERWISE USED, OR

COPPED, ANY MAINTHANDERS USE OF THIS POOLOMENT IS AT INSERT
RELEASES AND INDEMNIFIES BHAY FROM AND AGAINST ALL LOSS SO
ARISING.

NOTE

CONTRACTOR TO CHECK AND VERRY ALL DIMENSIONS ON SITE
PRIOR TO COMMINICATION OF SHOP
DRAWINGS, DO NOT SOLIE THIS DRAWING

IRC APARTMENTS ACTUAL / TARGET

STUDIO

CLIENT

TRUE

SCALE

DRAWING NUMBER AR-B10 NL-00

56/4013

1 BED AP. 8 / 10 2 BED AP. 21 / 26 4 BED AP. 36 / 37 BEDS 250 / 250 UNIVERSITY OF TECHNOLGY SYDNEY PROJECT MANAGER PROJECT INDIGENOUS RESIDENTIAL COLLEGE BVN PROJECT NUMBER 1901013 PROJECT NORTH NORTH 1:250 @ A3 0 2500 7500 ₹ STATUS DRAWING GA PLAN TYPICAL NEIGHBORHOOD LOWER LEVEL ISSUE N

INTELLECTUAL PROPERTY

IN TELLEC I UAL PROPERTY IN

COPPIGIST ON ACCHITECTURE FOR INITIZE UNLESS OTHERWISE
AGREDO IN WITHING ALL RIGHTS TO THIS DOCUMENT ARE SIRBERTY
PAYMENT IN THAIL OF ALL BING HAVERSEET BOOLOWSHET WAY ONLY
BE USED FOR THE EXPRESS PURPOSE AND PROJECT FOR WHIGHT IN

HAS BEEN (REFERD AND DELINERS, AND NIFIED IN WITHING BY
BINAND THIS DOCUMENT BAY NOT BE OTHERWISE USED, OR

COPPED, ANY MAINTHANDERS USE OF THIS POOLOMENT IS AT INSERT
RELEASES AND INDEMNIFIES BHAY FROM AND AGAINST ALL LOSS SO
ARISING.

NOTE

CONTRACTOR TO CHECK AND VERRY ALL DIMENSIONS ON SITE
PRIOR TO COMMINICATION OF SHOP
DRAWINGS, DO NOT SOLIE THIS DRAWING

IRC APARTMENTS ACTUAL / TARGET

STUDIO 1 BED AP.

2 BED AP.

4 BED AP.

BEDS

56/4014


8 / 10

21 / 26

36 / 37

250 / 250



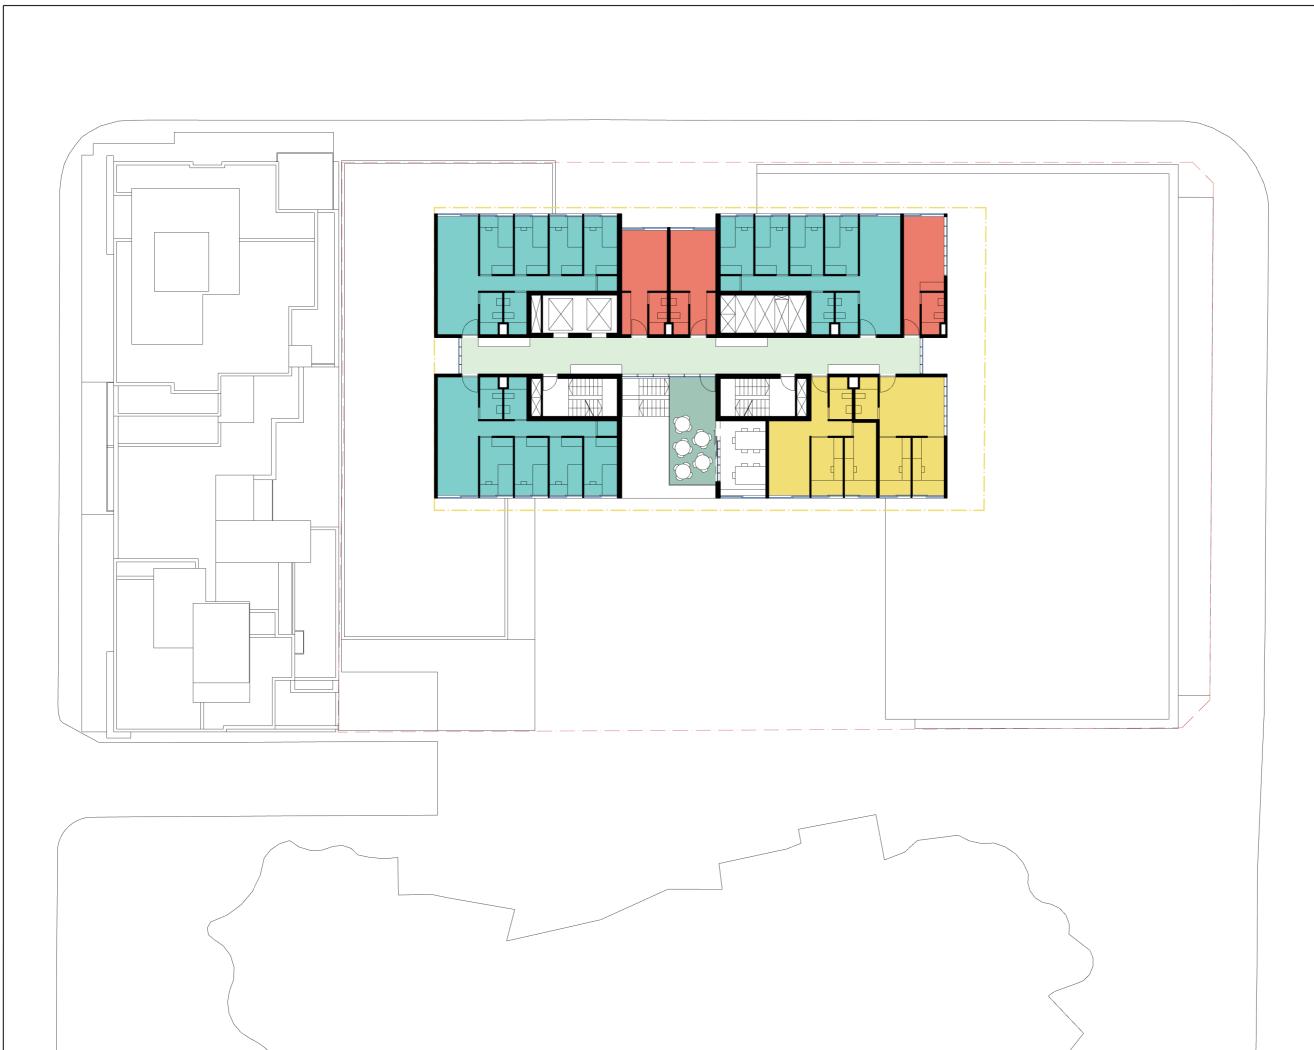

Telephone +61 7 3852 2525 Facsimile +61 7 3852 2544 www.bvn.com.au

INTELLECTUAL PROPERTY

IN TELLEC I UAL PROPERTY IN

COPPIGIST ON ACCHITECTURE FOR INITIZE UNLESS OTHERWISE
AGREDO IN WITHING ALL RIGHTS TO THIS DOCUMENT ARE SIRBERTY
PAYMENT IN THAIL OF ALL BING HAVERSEET BOOLOWSHET WAY ONLY
BE USED FOR THE EXPRESS PURPOSE AND PROJECT FOR WHIGHT IN

HAS BEEN (REFERD AND DELINERS, AND NIFIED IN WITHING BY
BINAND THIS DOCUMENT BAY NOT BE OTHERWISE USED, OR

COPPED, ANY MAINTHANDERS USE OF THIS POOLOMENT IS AT INSERT
RELEASES AND INDEMNIFIES BHAY FROM AND AGAINST ALL LOSS SO
ARISING.

NOTE

CONTRACTOR TO CHECK AND VERRY ALL DIMENSIONS ON SITE
PRIOR TO COMMINICATION OF SHOP
DRAWINGS, DO NOT SOLIE THIS DRAWING

IRC APARTMENTS ACTUAL / TARGET

STUDIO 1 BED AP. 56/4015

8 / 10

2 BED AP. 21 / 26 4 BED AP. 36 / 37 BEDS 250 / 250 CLIENT UNIVERSITY OF TECHNOLGY SYDNEY PROJECT MANAGER PROJECT INDIGENOUS RESIDENTIAL COLLEGE BVN PROJECT NUMBER 1901013 PROJECT NORTH TRUE NORTH SCALE 1:250 @ A3 0 2500 7500 ₹ STATUS DRAWING GA PLAN TYPICAL NEIGHBORHOOD UPPER LEVEL ISSUE N DRAWING NUMBER AR-B10 NL-00



Telephone +61 7 3852 2525 Facsimile +61 7 3852 2544 www.bvn.com.au

INTELLECTUAL PROPERTY

IRC APARTMENTS ACTUAL / TARGET

STUDIO 1 BED AP.

2 BED AP.

4 BED AP.

UNIVERSITY OF TECHNOLGY

INDIGENOUS RESIDENTIAL

BEDS

SYDNEY PROJECT MANAGER

PROJECT

COLLEGE BVN PROJECT NUMBER 1901013

TRUE NORTH

SCALE 1:500 @ A3

0 STATUS

DRAWING

DRAWING NUMBER AR-B10 NL-00

56/4016

8 / 10

21 / 26

36 / 37

250 / 250

LEVEL 5 LEVEL 6



NEIGHBORHOOD 1







LEVEL 7

LEVEL 13

LEVEL 8

LEVEL 9

LEVEL 10









LEVEL 11

LEVEL 14

LEVEL 12

NEIGHBORHOOD 4







LEVEL 15 LEVEL 16 **GA PLAN**

26/8/2021

PROJECT NORTH 15 TOWER APARTMENT MIX ISSUE A



ARCHITECTS REGISTRATION BOARD / NOMINATED ARCHITECTS

NSW

OLD
S9S NINOTSCHAA TITCHKOSKY
4837 JAMES GROSE
1711 SALUN ASHTON
7125 MATHER BUAN
7125 PALLE PROSINGTON
1314 PALLE PROSINGTON
13447 ALISON BOUNDS

Telephone +61 7 3852 2525 Facsimile +61 7 3852 2544 www.bvn.com.au

INTELLECTUAL PROPERTY


INTELLECTION.L PROPERTY.

OPPIGHT BY MAR ADVITCHINGE BY PLANTED. UNLESS OTHERWISE AGREED IN WIRTHINGAL RIGHTS TO THIS DOCUMENT ARE SUBJECT TO ANY MAN THE TOWN THE SUBJECT AND THE OFFICE AND PROJECT FOR WHICH THIS SEEL NOTESTAND AND THE LIBERTY OF ANY MAN THIS SEEL NOTESTAND AND THE LIBERTY OF ANY MAN THIS SEEL NOTESTAND AND THE LIBERTY OF ANY MAN THE SUBJECT ANY MAN THORSES USE OF THIS DOCUMENT IS AT THE CORRECT ANY MAN THORSES USE OF THIS DOCUMENT IS AT THE USER'S AGE INSEA ON WITHOUT LIBERTY BY OR RIGHT STELLERS AND INDEMNIFIES BYN FROM AND AGAINST ALL LOSS SO ARISING.

NOTE

ONTELLECTED TO CHECK AND VERSEY ALL DIMENSIONS ON SITE

CONTRACTOR TO CHECK AND VERIFY ALL DIMENSIONS ON SITE PRIOR TO COMMENCEMENT OF WORK OR PREPARATION OF SHOP DRAWINGS. DO NOT SCALE THIS DRAWING

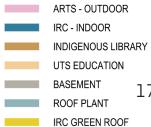

UTS INDIGENOUS GARDEN - OUTDOOR UTS INDIGENOUS GARDEN - INDOOR

17

CLIENT

UNIVERSITY OF TECHNOLGY SYDNEY

PROJECT MANAGER

INDIGENOUS RESIDENTIAL COLLEGE BVN PROJECT NUMBER 1901013

1901013		<u> </u>
TRUE NORTH	PROJECT NORTH	27 AUGUST
SCALE		GE /
1:250 @ A3		TIAL COLLEGE
		5
0 2500	7500	Τ

2500 0 STATUS

DRAWING

PLANS ROOFTOP

DRAWING NUMBER AR-B10 16-00

ISSUE N

ELEVATIONS AND SECTIONS

ARCHITECTS REGISTRATION BOARD / NOMINATED ARCHITECTS

Telephone +61 7 3852 2525

INTELLECTUAL PROPERTY

GERNS SOLE RISK AND WITHOUT LIMITING BY A RIGHTS THE USE'S RELEASES AND INDEMNIFIES BY FROM AND AGAINST ALL LOSS SO ARISING.

NOTE

IN O I E.

CONTRACTOR TO CHECK AND VERIFY ALL DIMENSIONS ON SITE

PRIOR TO COMMENCEMENT OF WORK OR PREPARATION OF SHOP

DRAWINGS. DO NOT SCALE THIS DRAWING



19

UNIVERSITY OF TECHNOLGY SYDNEY

PROJECT MANAGER

INDIGENOUS RESIDENTIAL COLLEGE

BVN PROJECT NUMBER

1:500 @ A3 15

ISSUE &

ELEVATION OMNIBUS LANE

DRAWING NUMBER AR-C10 XX-01



ARCHITECTS REGISTRATION BOARD / NOMINATED ARCHITECTS
NSW SHINTSOHMA TITCHKOSKY
SEE SHINDSTOHMA TITCHKOSKY
SEE SHINTSOHMA TORONIMER
MAT ALSON BOUNDES
SEE SHINTSOHMA TORONIMER
SEE SHINTSOHMA TORONIMER
SHINT

Telephone +61 7 3852 2525 Facsimile +61 7 3852 2544 www.bvn.com.au

INTELLECTUAL PROPERTY

RELEASES AND INDEMNIFIES BYN FROM AND AGAINST ALL LARISING.

NOTE

IN O I E.

CONTRACTOR TO CHECK AND VERIFY ALL DIMENSIONS ON SITE

PRIOR TO COMMENCEMENT OF WORK OR PREPARATION OF SHOP

DRAWINGS. DO NOT SCALE THIS DRAWING



20

CLIENT

UNIVERSITY OF TECHNOLGY SYDNEY

PROJECT MANAGER

PROJECT

INDIGENOUS RESIDENTIAL COLLEGE

BVN PROJECT NUMBER 1901013

SCALE 1:500 @ A3 15 0

ISSUE N

STATUS

DRAWING

ELEVATION MARY ANN STREET

DRAWING NUMBER AR-C10 XX-02

ARISING. NOTE



21

CLIENT

UNIVERSITY OF TECHNOLGY SYDNEY

PROJECT MANAGER

PROJECT

INDIGENOUS RESIDENTIAL COLLEGE

BVN PROJECT NUMBER 1901013

SCALE 1:500 @ A3

15

ISSUE M

0 STATUS

DRAWING

ELEVATION HARRIS STREET

DRAWING NUMBER AR-C10 XX-03





ARCHITECTS REGISTRATION BOARD / NOMINATED ARCHITECTS

Telephone +61 7 3852 2525 Facsimile +61 7 3852 2544 www.bvn.com.au

INTELLECTUAL PROPERTY

GERNS SOLE HAN AND WITHOUT LIMITING BYN'S RIGHTS I RELEASES AND INDEMNIFIES BYN FROM AND AGAINST ALL ARISING. NOTE



LEGEND - SOA

ARTS - INTERIOR ARTS - OUTDOOR

INDIGENOUS LIBRARY

UTS EDUCATION

22 ROOF PLANT

IRC GREEN ROOF UTS INDIGENOUS

GARDEN - OUTDOOR UTS INDIGENOUS

GARDEN - INDOOR

UNIVERSITY OF TECHNOLGY SYDNEY

PROJECT MANAGER

PROJECT

INDIGENOUS RESIDENTIAL COLLEGE

BVN PROJECT NUMBER 1901013

SCALE 1:500 @ A3 15 0

ISSUE A

STATUS

GA SECTION

DRAWING NUMBER AR-D10 XX-01




ARCHITECTS REGISTRATION BOARD / NOMINATED ARCHITECTS

Telephone +61 7 3852 2525 Facsimile +61 7 3852 2544 www.bvn.com.au

INTELLECTUAL PROPERTY

RELEASES AND INDEX ARISING.

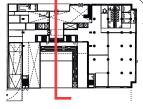

ARTS - INTERIOR ARTS - OUTDOOR

> IRC - INDOOR INDIGENOUS LIBRARY

UTS EDUCATION

BASEMENT ROOF PLANT

IRC GREEN ROOF

UTS INDIGENOUS GARDEN - OUTDOOR UTS INDIGENOUS

23

GARDEN - INDOOR

UNIVERSITY OF TECHNOLGY SYDNEY

PROJECT MANAGER

INDIGENOUS RESIDENTIAL COLLEGE

BVN PROJECT NUMBER

SCALE

1:500 @ A3 0

15

ISSUE ≧

DRAWING

GA SECTION

DRAWING NUMBER AR-D10 XX-02



NOMINATED ARCHITECTS

Telephone +61 7 3852 2525 Facsimile +61 7 3852 2544 www.bvn.com.au

INTELLECTUAL PROPERTY

RELEASES AND INDEMNIFIES BYN FROM AND AGAINST ALL LARISING.

NOTE



ARTS - INTERIOR ARTS - OUTDOOR

IRC - INDOOR INDIGENOUS LIBRARY

UTS EDUCATION

24

ROOF PLANT

IRC GREEN ROOF

UTS INDIGENOUS GARDEN - OUTDOOR UTS INDIGENOUS

GARDEN - INDOOR

UNIVERSITY OF TECHNOLGY SYDNEY

PROJECT MANAGER

INDIGENOUS RESIDENTIAL COLLEGE

BVN PROJECT NUMBER

1:500 @ A3 15

ISSUE ≧

GA SECTION

DRAWING NUMBER AR-D10 XX-03

25

AREA SUMMARY

26

/N / UTS INDIGENOUS RESIDENTIAL COLLEGE / 27 AUGUST 2021

DEFINITIONS

NET INTERNAL AREA



TYPICAL TOWER PLAN 1:250

Net Internal Area (Net)

The area of the internal rooms decribed in BVN's Schedule of Accommodation.

Excludes:

- External spaces
- Corridors
- Stairs
- Lifts
- Plant and Services

DEFINITIONS

PLANNING GROSS FLOOR AREA



TYPICAL TOWER PLAN 1:250

Planning Gross Floor Area (PGFA)

As per Sydney Local Environmental Plan 2012.

Gross Floor Area means the sum of the floor area of each floor of a building measured from the internal face of external walls, or from the internal face of walls separating the building from any other building, measured at a height of 1.4 metres above the floor, and includes—

- (a) the area of a mezzanine, and
- (b) habitable rooms in a basement or an attic, and
- (c) any shop, auditorium, cinema, and the like, in a basement or attic,


but excludes-

- (d) any area for common vertical circulation, such as lifts and stairs, and
- (e) any basement-
 - (i) storage, and
 - (ii) vehicular access, loading areas, garbage and services, and
- (f) plant rooms, lift towers and other areas used exclusively for mechanical services or ducting, and
- (g) car parking to meet any requirements of the consent authority (including access to that car parking), and
- (h) any space used for the loading or unloading of goods (including access to it), and
- (i) terraces and balconies with outer walls less than 1.4 metres high, and
- (j) voids above a floor at the level of a storey or storey above.

^{*}Here PGFA also includes external horizontal circulation.

DEFINITIONS

GROSS BUILDING AREA

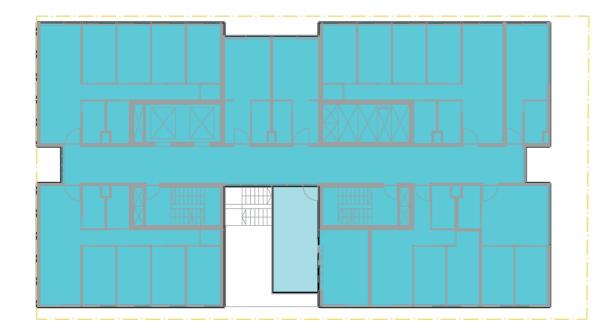

TYPICAL TOWER PLAN 1:250

Gross Building Area (GBA)

The sum of the 'Fully Enclosed Covered Area' and 'Unenclosed Covered Area' as defined below.

Fully Enclosed Covered Area (FECA)

The sum of all such areas at all building floor levels, including basement (except unexcavated portions), floored roof spaces and attics, garages, penthouses, enclosed porches and attached covered ways alongside buildings, equipment rooms, lift shafts, vertical ducts, staircases and any other fully enclosed spaces and useable areas of the building, computed by measuring from the normal inside face of exterior walls but ignoring any projections such as plinths, columns, piers and the like which project from the normal inside face of exterior walls. It shall not include open courts, light wells, connecting or isolated covered ways and net open areas of upper portions of rooms, lobbies, halls, interstitial spaces and the like which extend through the storey being computed.

Unenclosed Covered Area (UCA)


The sum of all such areas at all building floor levels, including roofed balconies, open verandahs porches and porticos, attached open covered ways alongside buildings, undercrofts and useable space under buildings, unenclosed access galleries (including ground floor) and any other trafficable covered areas of the building which are not totally enclosed by full height walls, computed by measuring the area between the enclosing walls or balustrade (i.e. from the inside face of the UCA excluding the wall or balustrade thickness). When the covering element (i.e. roof or upper floor) is supported by columns, is cantilevered or suspended, or any combination of these, the measurements shall be taken to the edge of the paving or to the edge of the cover, whichever is the lesser. UCA shall not include eaves overhangs, sun shading, awnings and the like where these do not relate to clearly defined trafficable covered areas, nor shall it include connecting or isolated covered ways.

AVERAGE TYPICAL IRC FLOOR EFFICIENCY


LEVELS 5-16

NET INTERNAL =
$$370 \text{ m}^2$$
 62%

NET OUTDOOR = 22 m^2

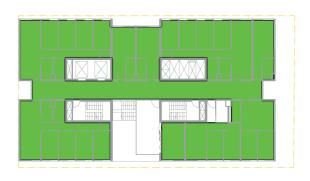


$$PGFA = 461 \text{ m}^2$$

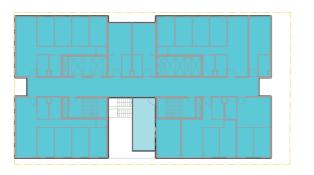


$$GBA = 596 \text{ m}^2$$
 100%

$$ENVELOPE = 728 m^2$$


	4			
di.		H		

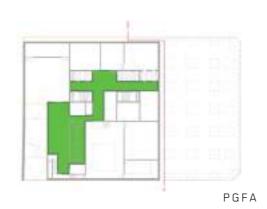


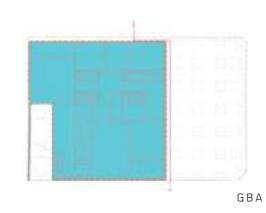



BASEMENT


GROUND

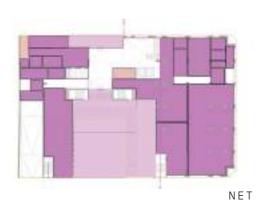

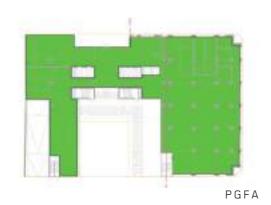

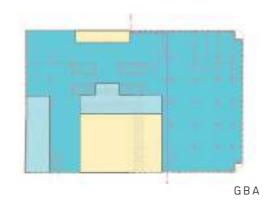

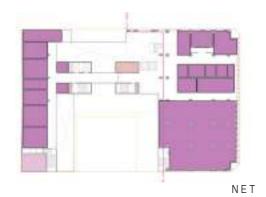


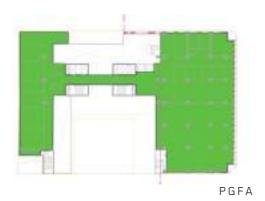






REFERENCE SCHEME PLANS 1:1000


LEVEL	NET INTERNAL	NET OUTDOOR	NET I + O	PGFA	FECA	UCA	GBA	MAXIMUM ENVELOPE	UNCOVERED AREA	BUILDING SERVICES
Basement Level	482		482	244	1,197		1,197	1,197		390
Ground Level	1,182	501	1,683	1,295	1,496	255	1,751	1,943	375	30
Level 1	754	30	784	1,112	1,303		1,303	1,871	30	17
Level 2	1,038	184	1,222	1,163	1,331	113	1,444	1,067	74	17
Level 2	896	62	958	1,123	1,331	40	1,371	1,760	37	17
L4 Roof Garden	287	39	326	409	537	100	637	809	811	17
IRC Tower	4,515	349	4,864	5,609	6,981	371	7,352	8,861		208
Rooftop					503		503	728		370
TOTALS % GBA	9,154 59%	1,165 7%	10,319 66%	10,955 70%	14,679 94%	879 6%	15,558 100%	18,236 117%	1,327	1,066

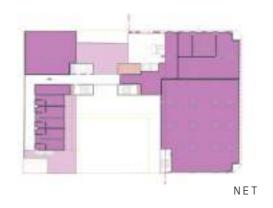


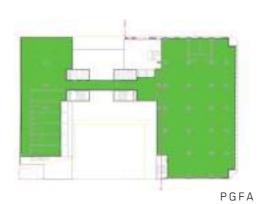

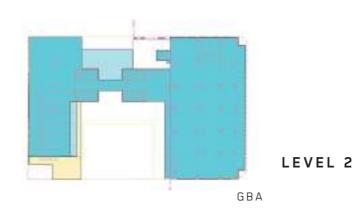


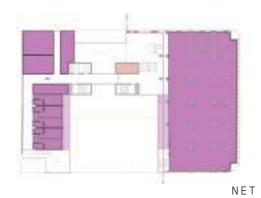


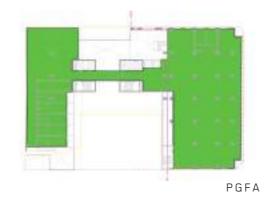


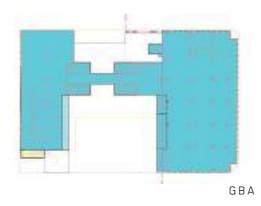

LEVEL 3

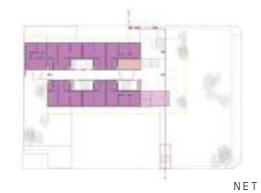

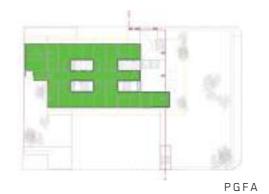

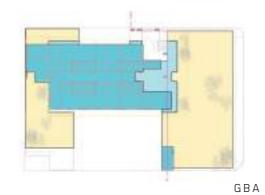

ROOF GARDEN

REFERENCE SCHEME PLANS 1:1000


IRC TOWER - NET

LEVEL	NET INTERNAL	NET OUTDOOR	NET I + O	PGFA	FECA	UCA	GBA	MAXIMUM ENVELOPE	UNCOVERED AREA	BUILDING SERVICES
Basement Level	482		482	244	1,197		1,197	1,197		390
Ground Level	1,182	501	1,683	1,295	1,496	255	1,751	1,943	375	30
Level 1	754	30	784	1,112	1,303		1,303	1,871	30	17
Level 2	1,038	184	1,222	1,163	1,331	113	1,444	1,067	74	17
Level 2	896	62	958	1,123	1,331	40	1,371	1,760	37	17
L4 Roof Garden	287	39	326	409	537	100	637	809	811	17
IRC Tower	4,515	349	4,864	5,609	6,981	371	7,352	8,861		208
Rooftop					503		503	728		370
TOTALS % GBA	9,154 59%	1,165 7%	10,319 66%	10,955 70%	14,679 94%	879 6%	15,558 100%	18,236 117%	1,327	1,066








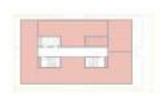

ROOFTOP

IRC TOWER - PGFA

LEVEL	NET INTERNAL	NET OUTDOOR	NET I + O	PGFA	FECA	UCA	GBA	MAXIMUM ENVELOPE	UNCOVERED AREA	BUILDING SERVICES
Basement Level	482		482	244	1,197		1,197	1,197		390
Ground Level	1,182	501	1,683	1,295	1,496	255	1,751	1,943	375	30
Level 1	754	30	784	1,112	1,303		1,303	1,871	30	17
Level 2	1,038	184	1,222	1,163	1,331	113	1,444	1,067	74	17
Level 2	896	62	958	1,123	1,331	40	1,371	1,760	37	17
L4 Roof Garden	287	39	326	409	537	100	637	809	811	17
IRC Tower	4,515	349	4,864	5,609	6,981	371	7,352	8,861		208
Rooftop					503		503	728		370
TOTALS % GBA	9,154 59%	1,165 7%	10,319 66%	10,955 70%	14,679 94%	879 6%	15,558 100%	18,236 117%	1,327	1,066

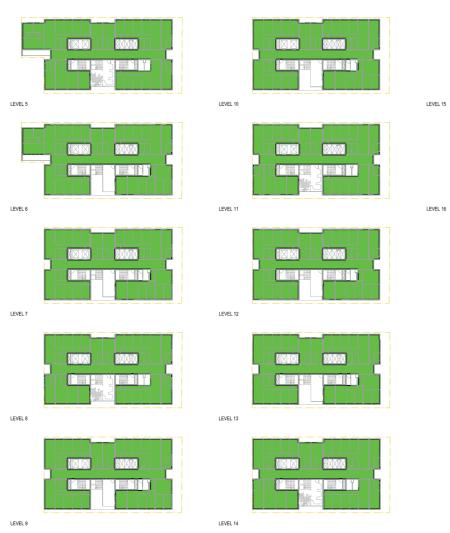








ROOFTOP

IRC TOWER - GBA

LEVEL	NET INTERNAL	NET OUTDOOR	NET I + O	PGFA	FECA	UCA	GBA	MAXIMUM ENVELOPE	UNCOVERED AREA	BUILDING SERVICES
Basement Level	482		482	244	1,197		1,197	1,197		390
Ground Level	1,182	501	1,683	1,295	1,496	255	1,751	1,943	375	30
Level 1	754	30	784	1,112	1,303		1,303	1,871	30	17
Level 2	1,038	184	1,222	1,163	1,331	113	1,444	1,067	74	17
Level 2	896	62	958	1,123	1,331	40	1,371	1,760	37	17
L4 Roof Garden	287	39	326	409	537	100	637	809	811	17
IRC Tower	4,515	349	4,864	5,609	6,981	371	7,352	8,861		208
Rooftop					503		503	728		370
TOTALS % GBA	9,154 59%	1,165 7%	10,319 66%	10,955 70%	14,679 94%	879 6%	15,558 100%	18,236 117%	1,327	1,066

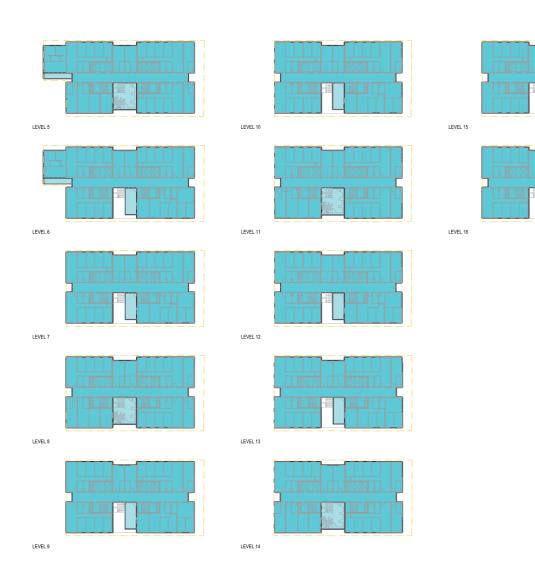





ROOFTOP