
PROPOSED MIXED-USE DEVELOPMENT 315-321 ILLAWARRA ROAD, MARRICKVILLE STORMWATER CONCEPT DESIGN



	DRAWING REGISTER					
SHEET No.	No.	TITLE	REV			
1	SW100	COVER SHEET	В			
2	SW200	STORMWATER CONCEPT DESIGN - BASEMENT 02 PLAN	В			
3	SW201	STORMWATER CONCEPT DESIGN - BASEMENT 01 PLAN	В			
4	SW202	STORMWATER CONCEPT DESIGN - GROUND FLOOR PLAN	В			
5	SW203	STORMWATER CONCEPT DESIGN - ROOF PLAN	В			
6	SW300	STORMWATER CONCEPT DESIGN - DETAILS SHEET - SHEET 1 OF 2	В			
7	SW301	STORMWATER CONCEPT DESIGN - DETAILS SHEET - SHEET 2 OF 2	В			
8	SW400	EROSION AND SEDIMENT CONTROL - PLAN AND DETAILS	В			
9	SW500	STORMWATER CONCEPT DESIGN - MUSIC CATCHMENT PLAN	В			


LOCALITY PLAN NOT TO SCALE
COPYRIGHT OF GOOGLE MAP, VERSION 3

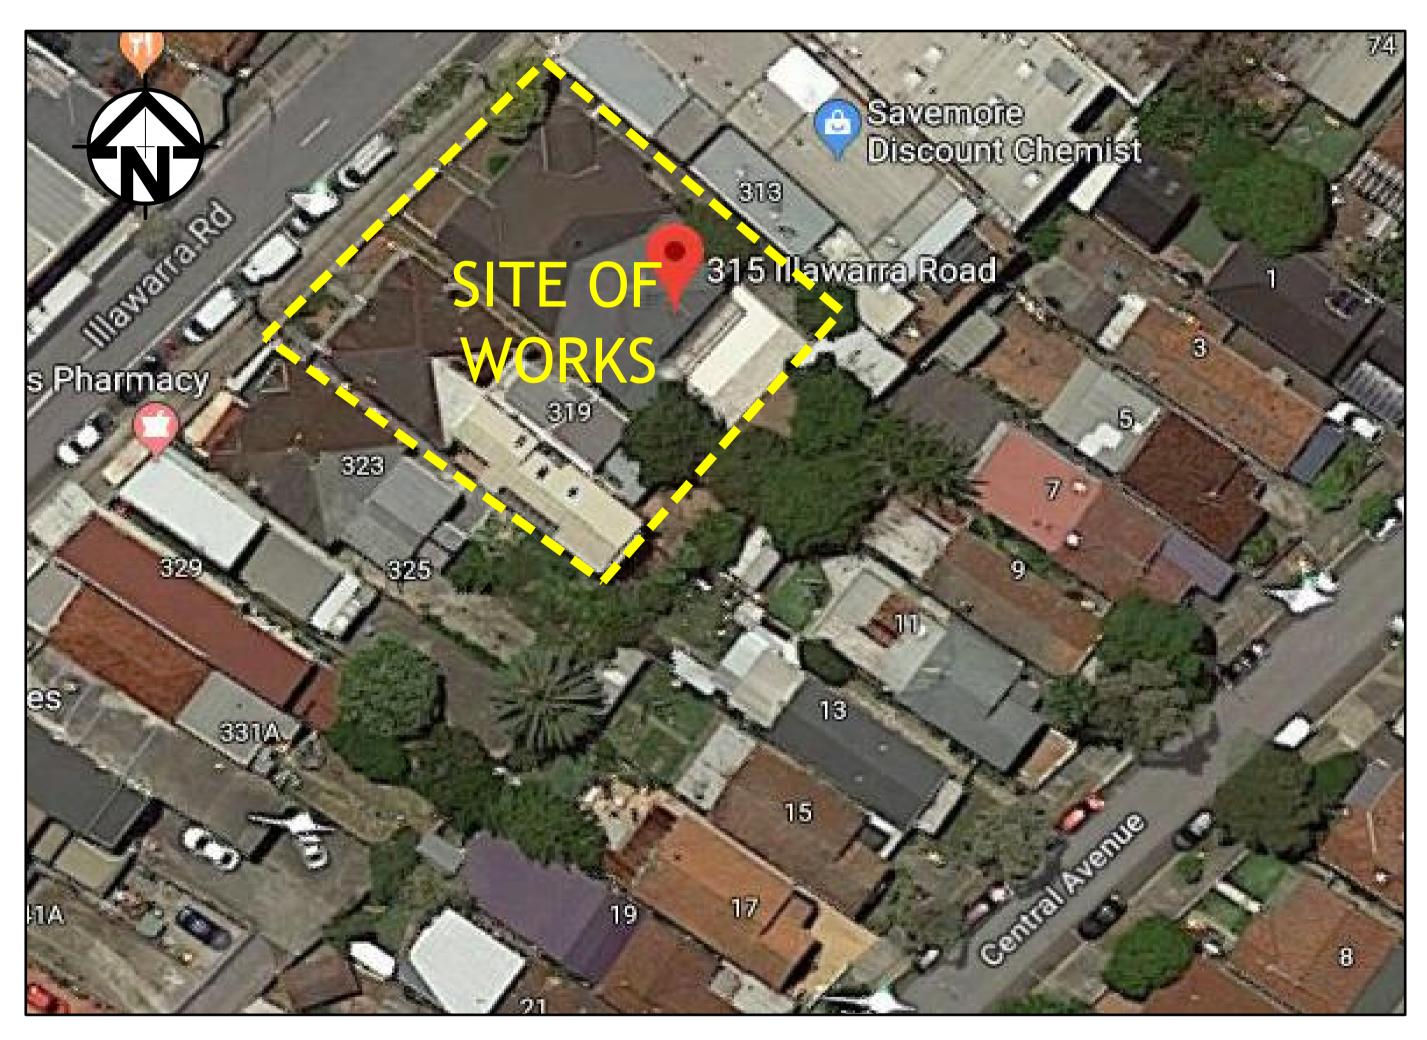

PREPARED BY:

SGC Consulting Engineers Suite 5.03, Level 5 156 Pacific Highway St Leonards, NSW 2065 T: +61 2 8883 4239 Email: office@sgce.com.au Web: www.sgce.com.au


ARCHITECT:

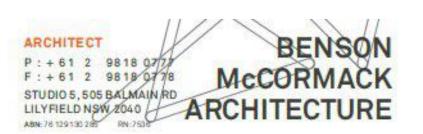


CLIENT:


VINH & SAU


SW100

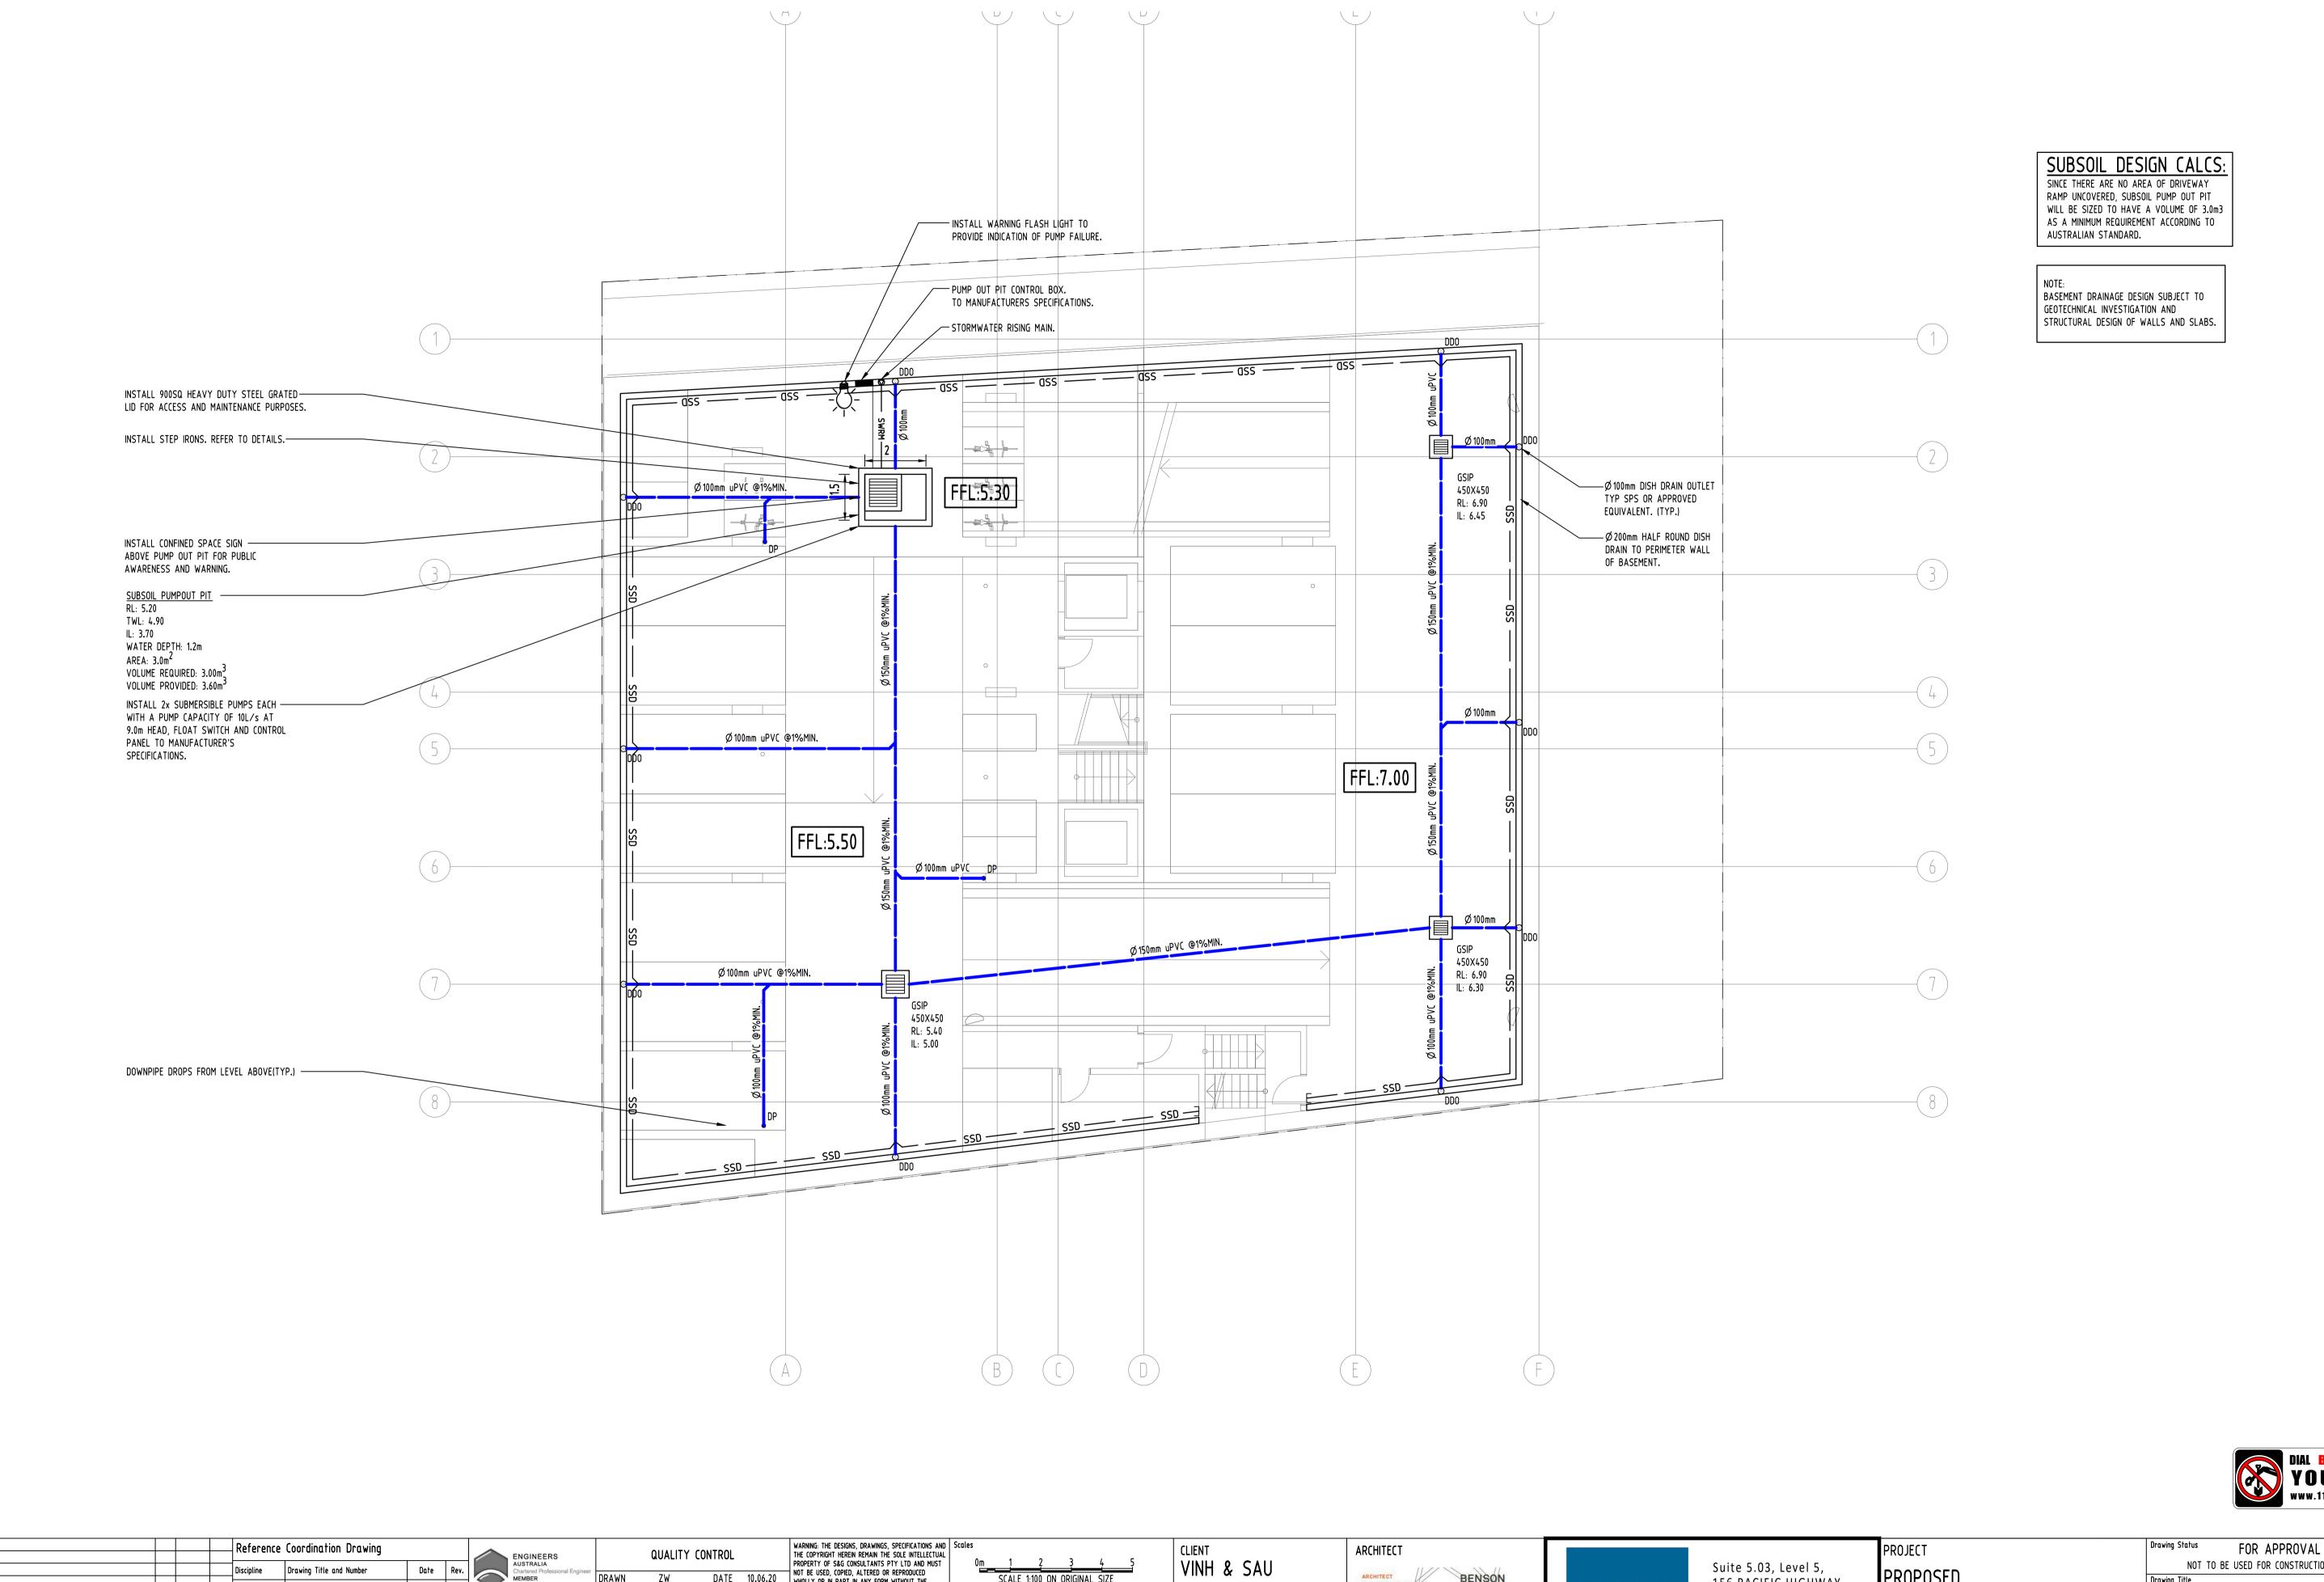

on\2019\20190095 315 IIIaw	B ISSUE FOR DA ZW 10.06.2020 2 A ISSUE FOR DA FZ 10.10.2019 2	Discipline Drawing Title and Number ARCH ARCH STRUCT MECH ELEC	Date Rev. Date Rev. Date Rev. DRAWN ZW DATE 10.06.20 DIMENSIONS NOT SHOWN TO BE CHECKED ON SITE. DO NOT SCALE OF THIS DRAWING. POSITIONS OF AUTHORITIES MAINS AND/OR EXISTING SERVICES ARE TO BE CHECKED DISCREPANCE OF THIS DRAWING. DESIGNED ZW DATE 10.06.20 DESIGNED ZW DATE 10.06.20	SCALE 1:100 ON ORIGINAL SIZE VINH & SAU	ARCHITECT P:+61 2 9818 9778 F:+61 2 9818 9778 MCCORMACK STUDIOS, 505 BAMAIN BD LILYPIELD NEW 2040 ARCHITECTURE	ST LEONARDS, NSW 2065 T: +61 2 8883 4239 Email: office@sgce.com.au	PROPOSED MIXED-USE DEVELOPMENT 315-321 ILLAWARRA ROAD, MARRICKVILLE	NOT TO BE USED FOR CONSTRUCTION PURPOSES Drawing Title STORMWATER CONCEPT DESIGN BASEMENT 02 PLAN
XREF's: \$? CAD FILE: Z:\Producti	P1 PRELIMINARY FZ 15.07.2019 1 ssue Last revision title by Date Stat Issuer internal sequence and revision history 1-preliminary 2-development application 3-construction certificate 4-tender 5-construction 6-other	LANDS	PRIOR TO COMMENCEMENT OF WORK. REPORT ANY DISCREPANCIES TO THE CONSULTING ENGINEER FOR DECISION/CLARIFICATION BEFORE PROCEEDING WITH THE WORK. THIS DRAWING IS TO BE READ IN CONJUNCTION WITH THE SPECIFICATIONS AND OTHER CONSULTANTS' DRAWINGS. VERIFIED SH DATE 10.06.20 APPROVED SH DATE 10.06.20		Engine	Web: www.sgce.com.au eering Value A.B.N. 21 118 222 530	Grid Datum Sheet Scale (at original size) - A.H.D. 2 of 9 1:100 @ A1	Project No Drawing No Revision No 20190095 SW200 B

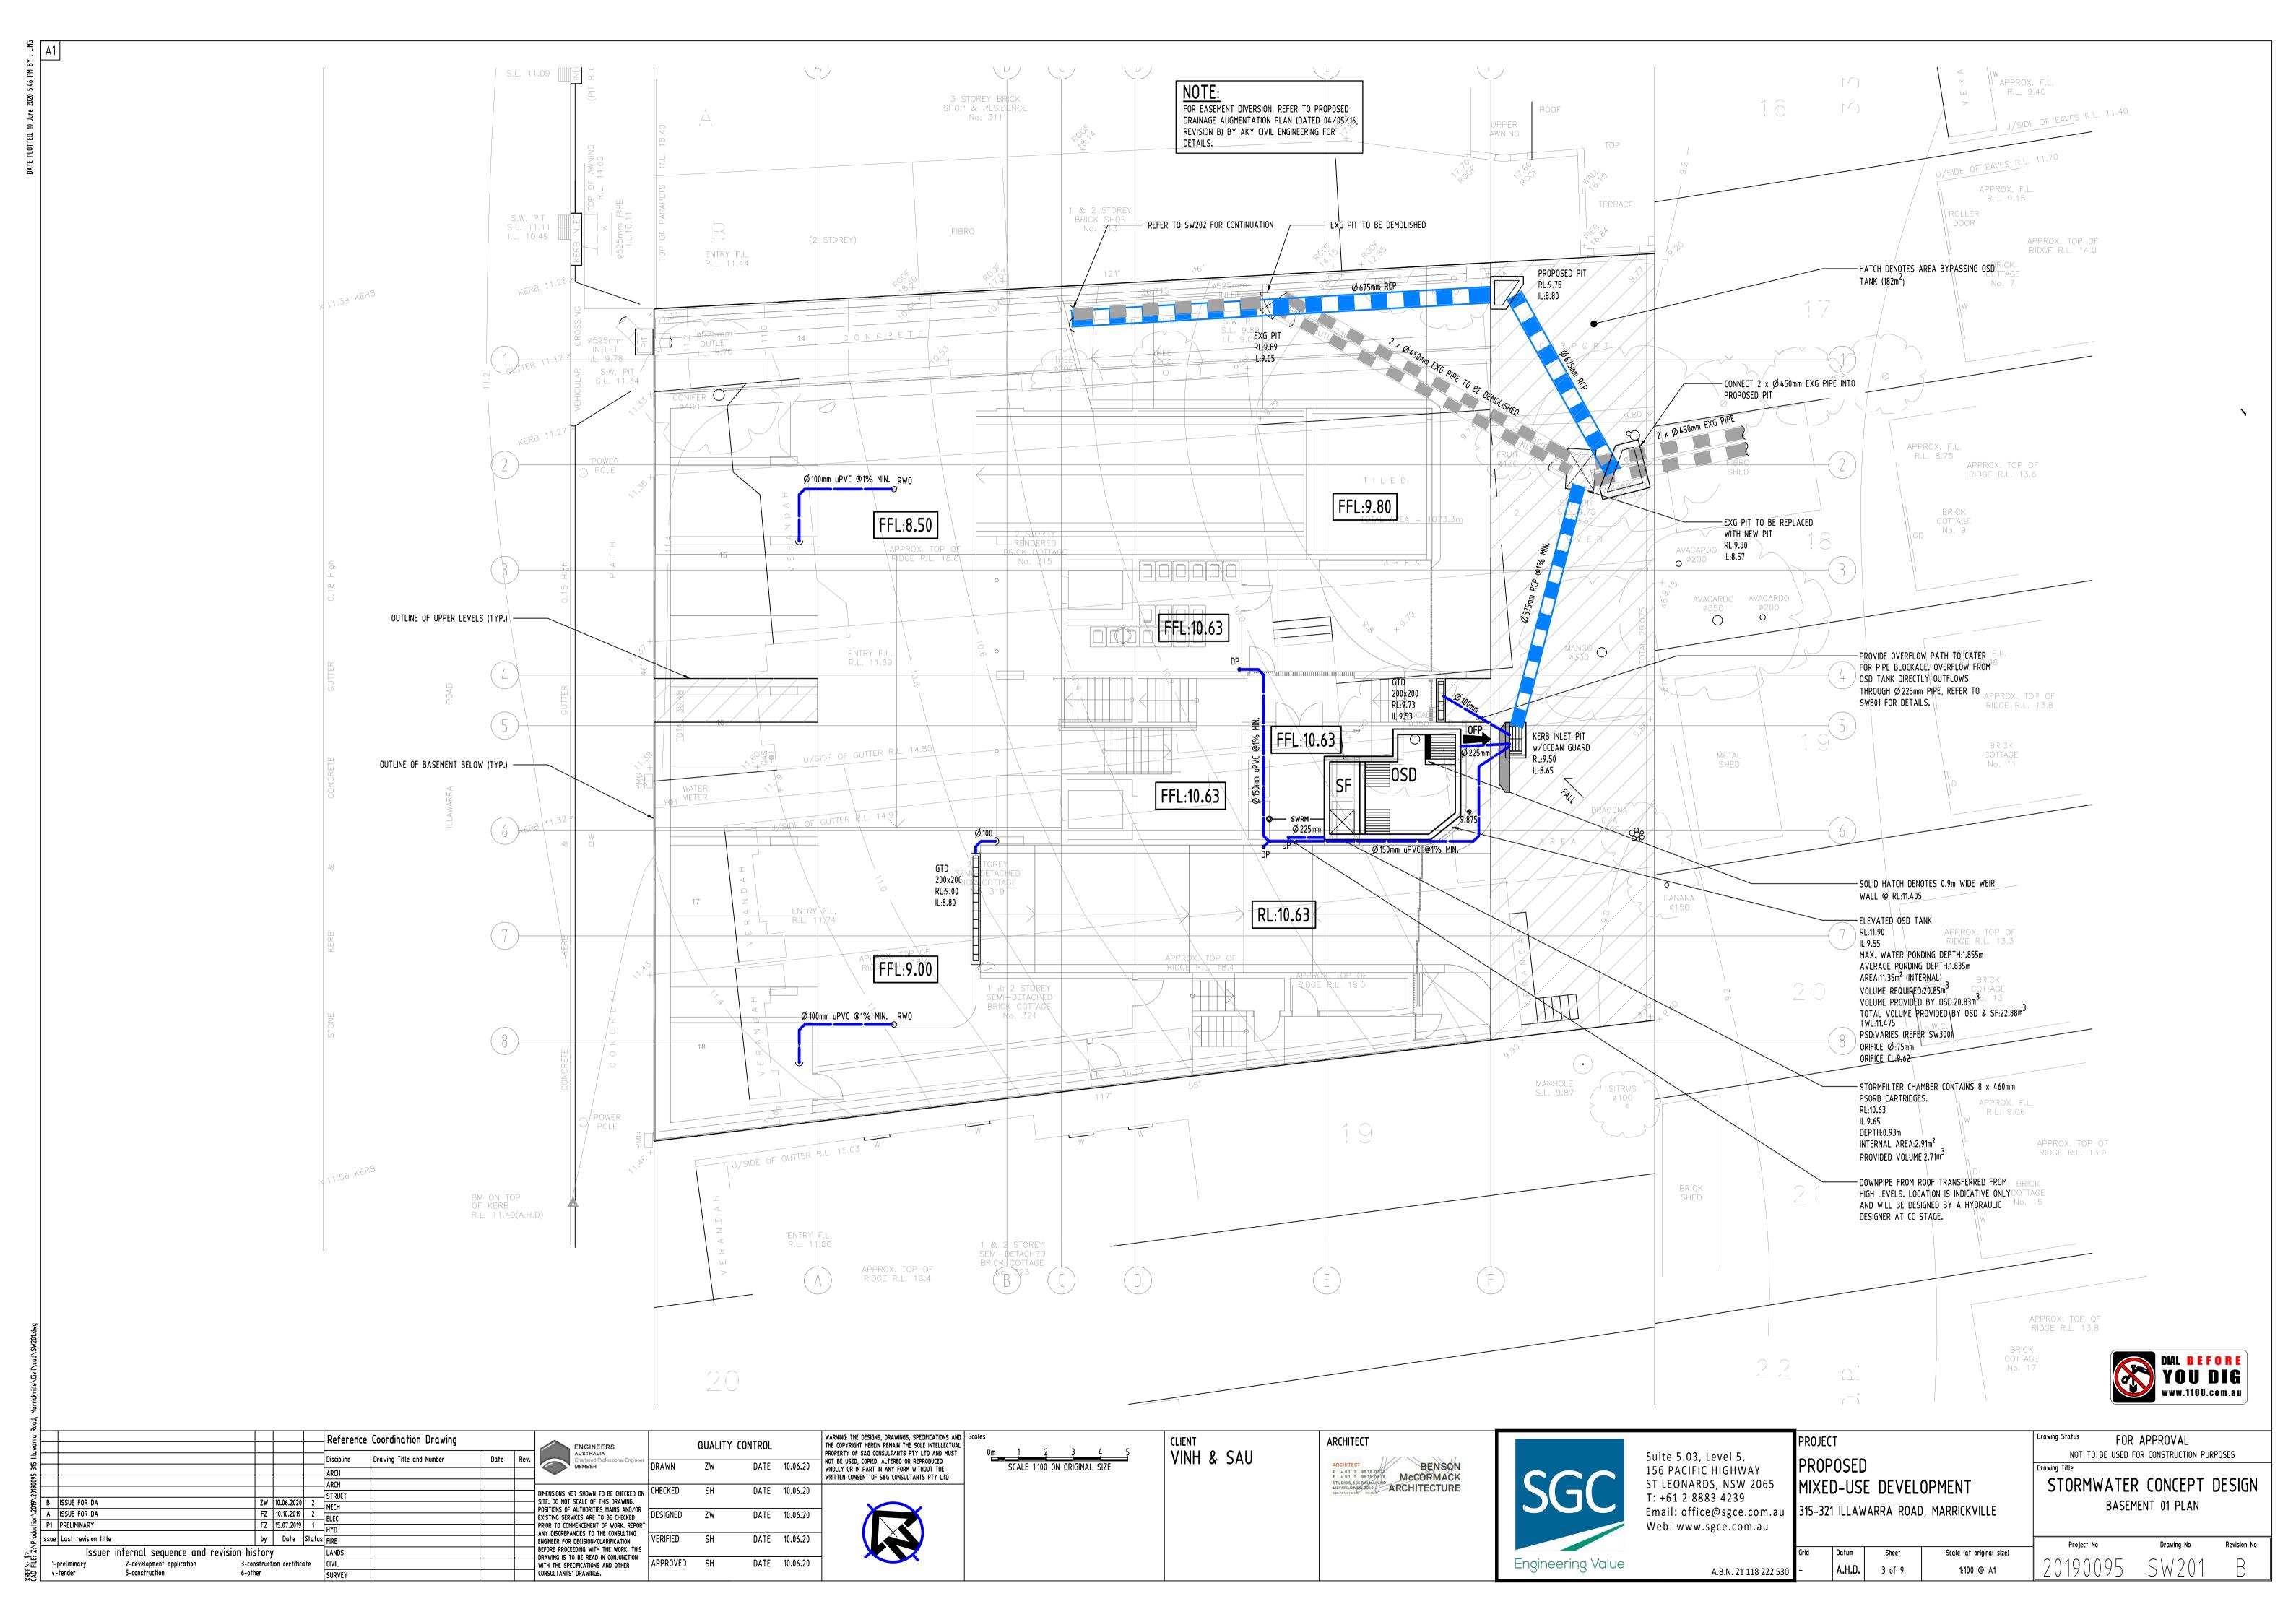

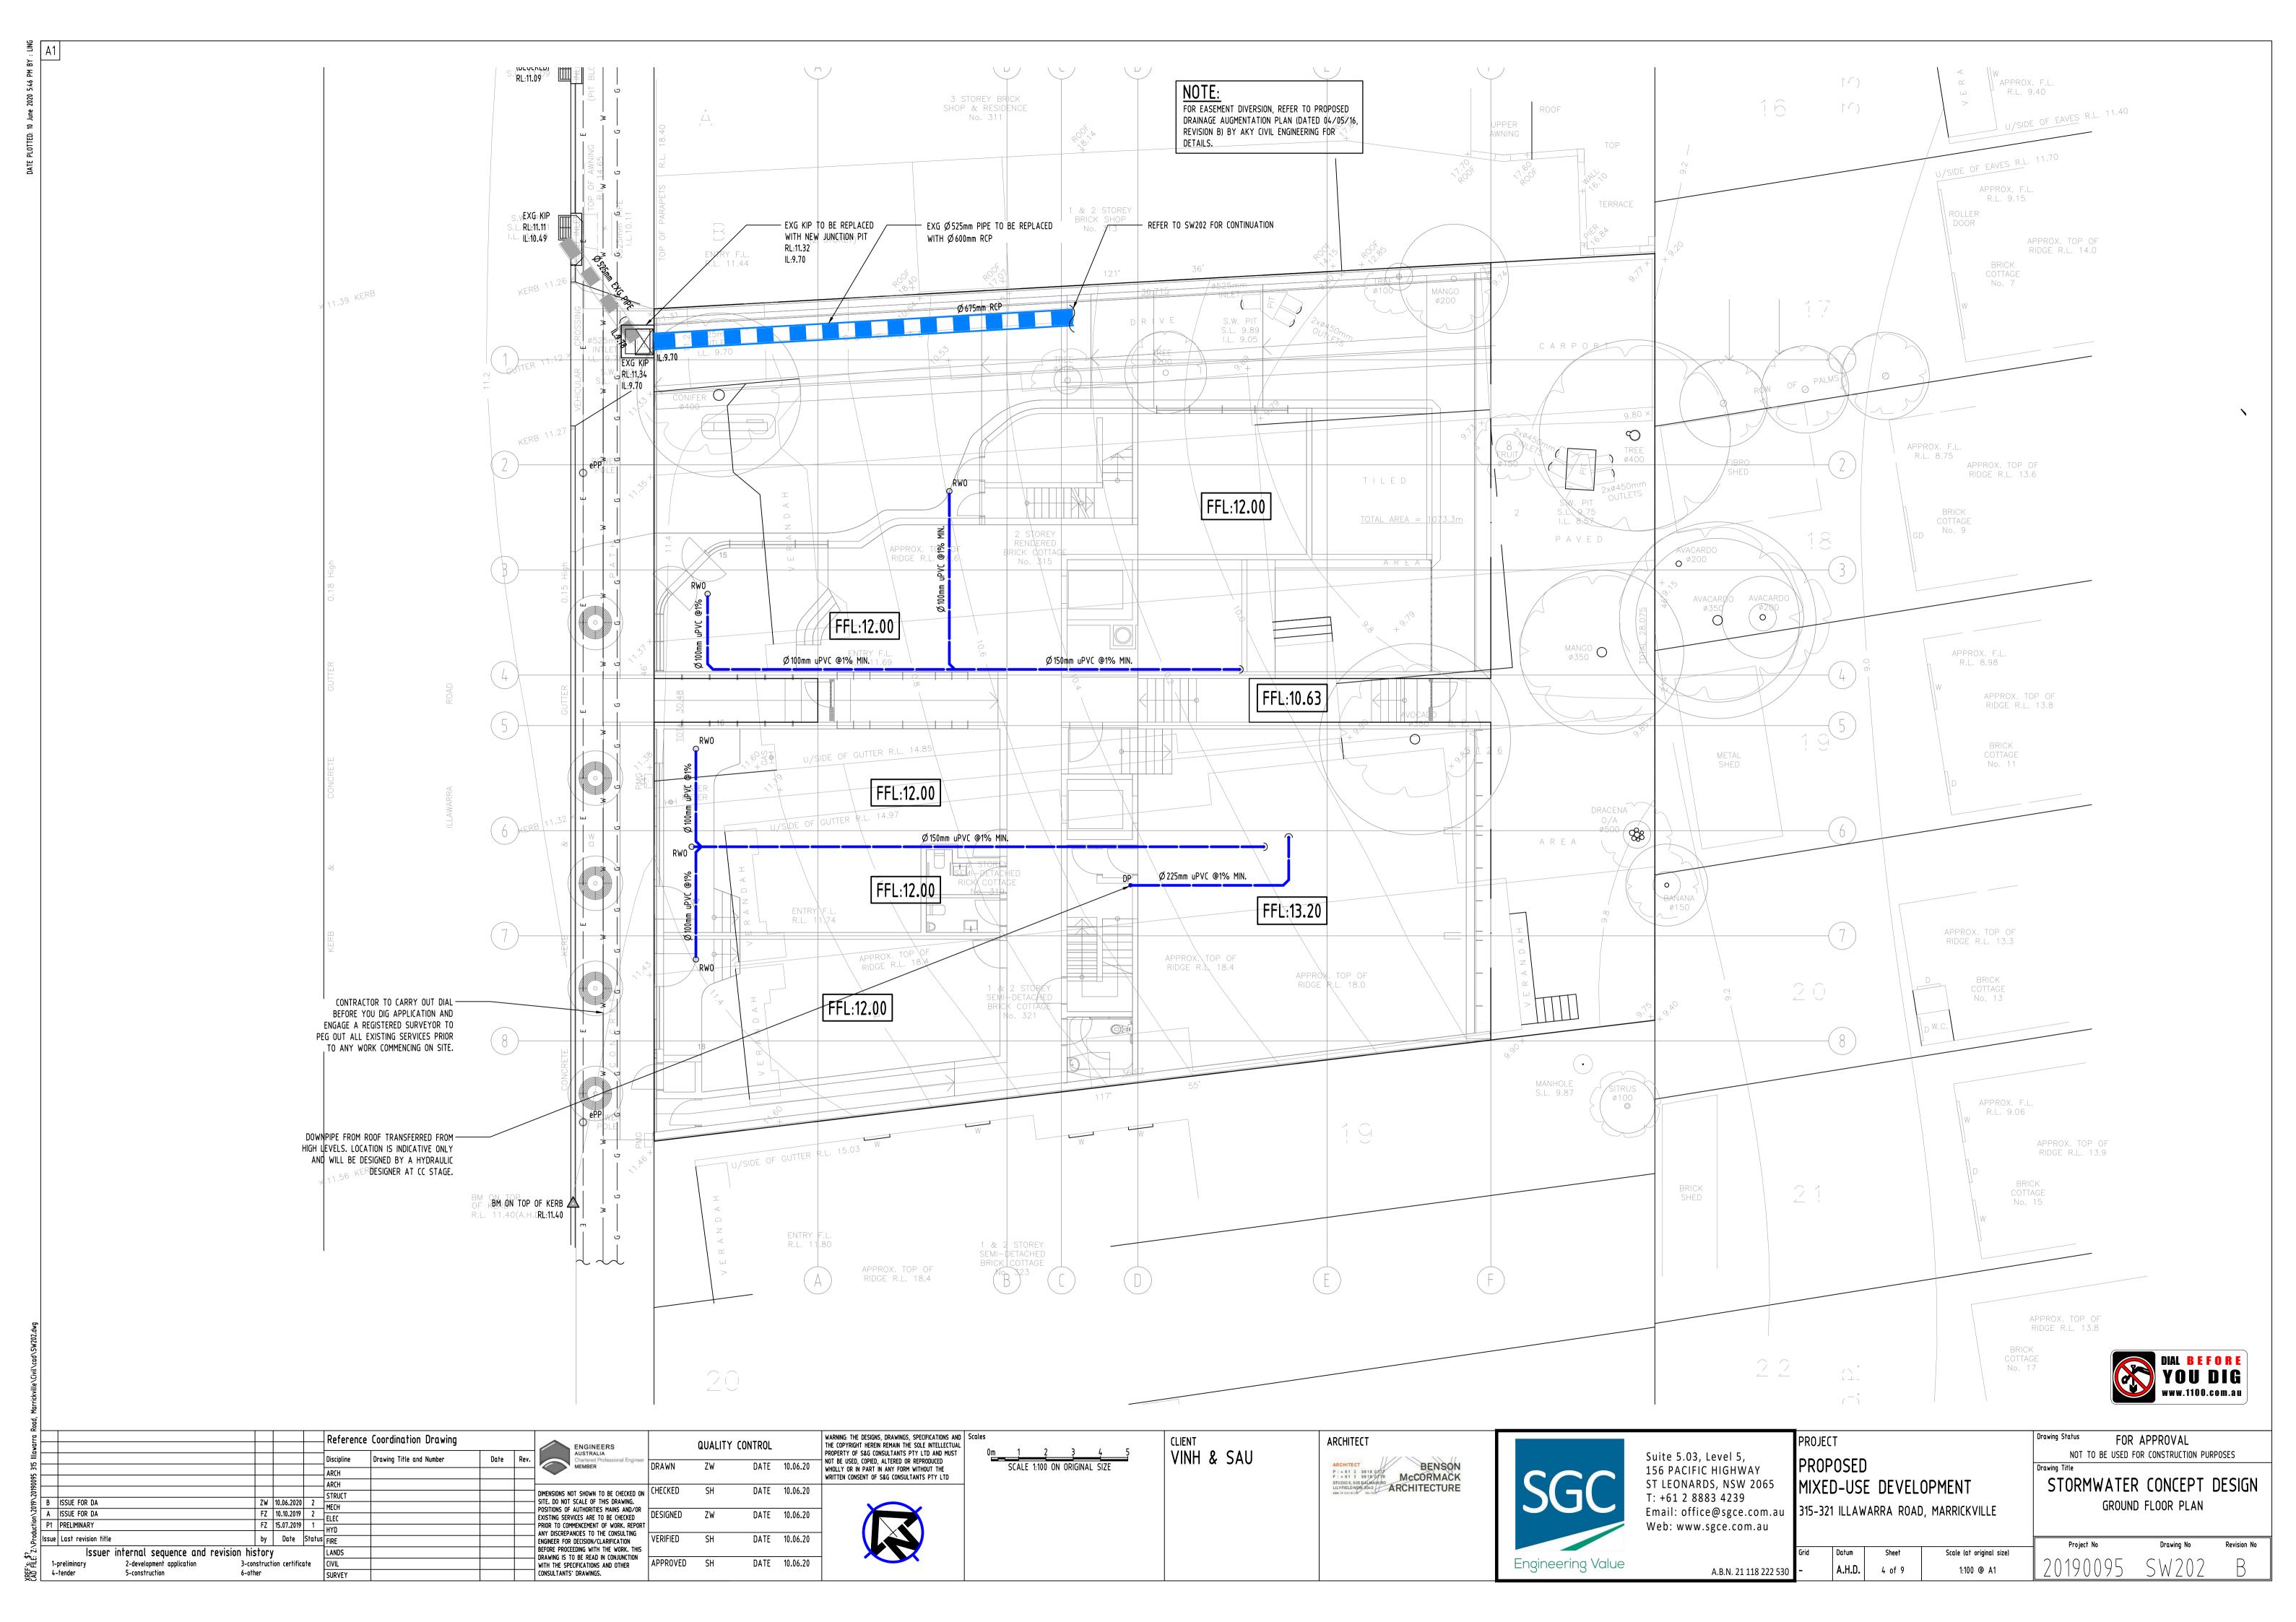

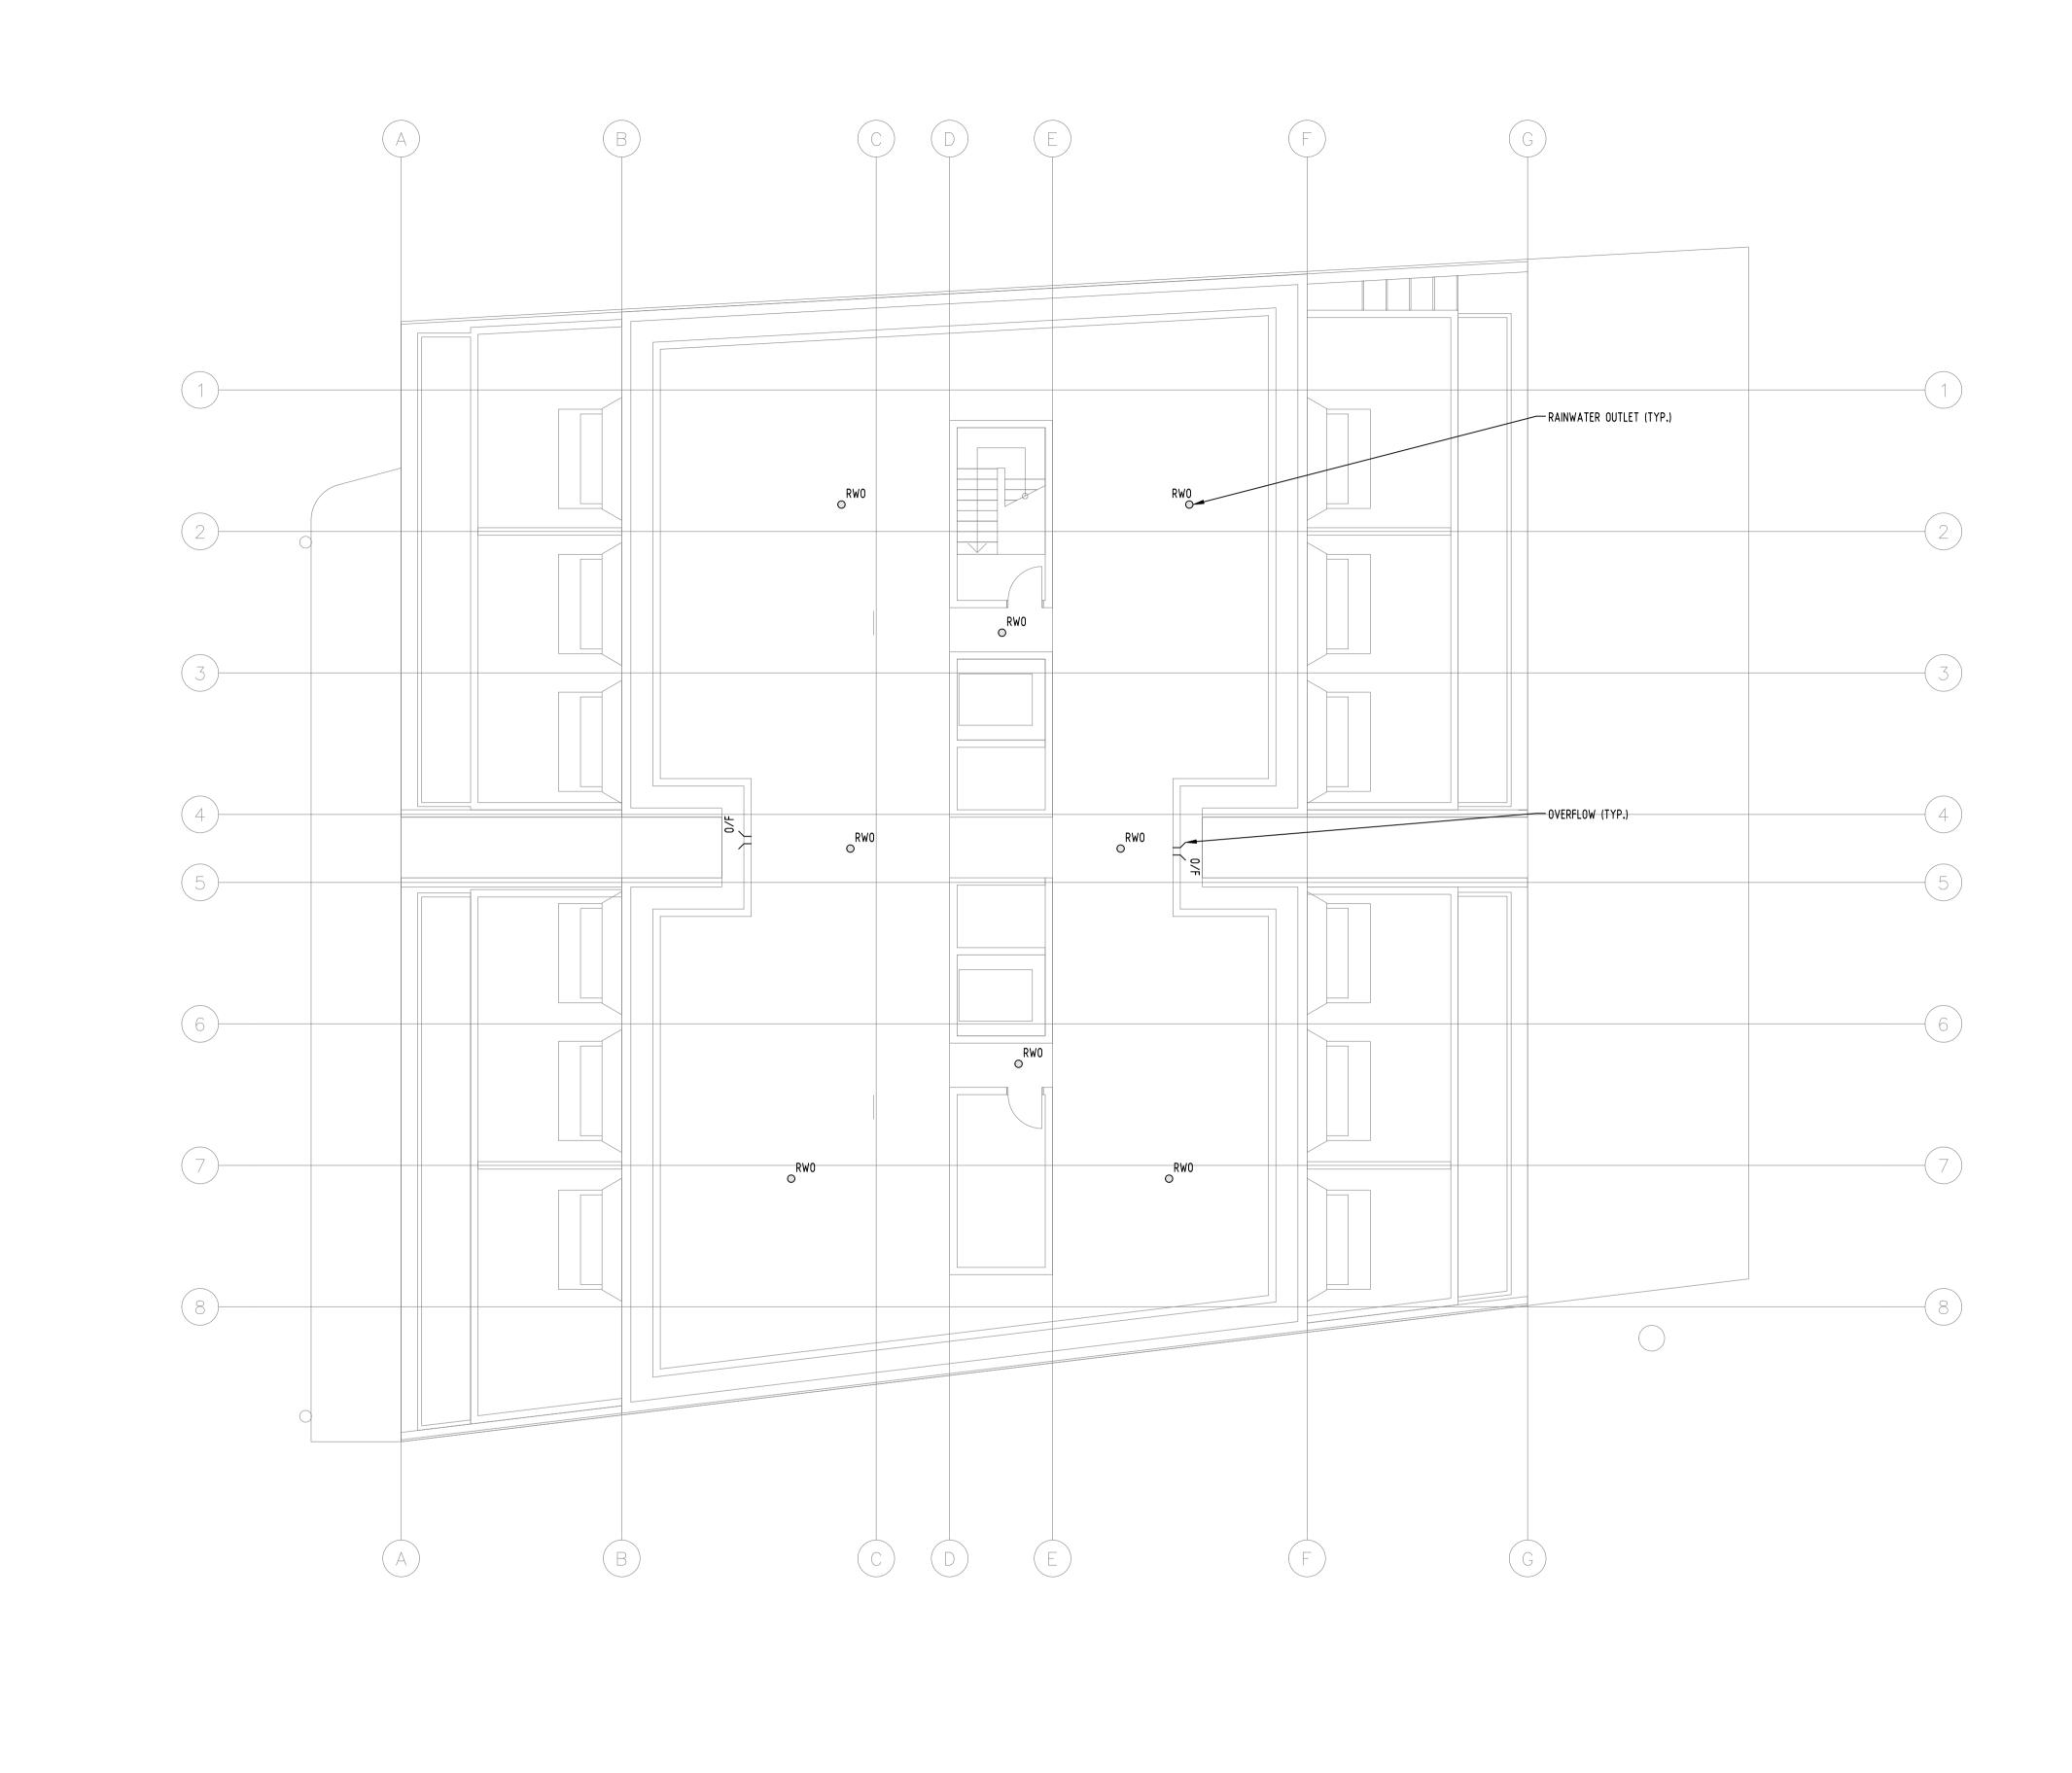




WARNING: THE DESIGNS, DRAWINGS, SPECIFICATIONS AND THE COPYRIGHT HEREIN REMAIN THE SOLE INTELLECTUAL PROJECT FOR APPROVAL Reference Coordination Drawing QUALITY CONTROL 0<u>m 1 2 3 4 5</u> SCALE 1:100 ON ORIGINAL SIZE | Discipline | ARCH | ARCH | STRUCT | MECH | ELEC | HYD | by | Date | Status | FIRE | CARCE | VINH & SAU PROPERTY OF S&G CONSULTANTS PTY LTD AND MUST NOT TO BE USED FOR CONSTRUCTION PURPOSES Suite 5.03, Level 5, NOT BE USED, COPIED, ALTERED OR REPRODUCED WHOLLY OR IN PART IN ANY FORM WITHOUT THE WRITTEN CONSENT OF S&G CONSULTANTS PTY LTD DATE 10.06.20 156 PACIFIC HIGHWAY ST LEONARDS, NSW 2065
T: +61 2 8883 4239
Email: office@sgce.com.au

MIXED-USE DEVELOPMENT
315-321 ILLAWARRA ROAD, MARRICKVILLE STORMWATER CONCEPT DESIGN DIMENSIONS NOT SHOWN TO BE CHECKED ON SITE. DO NOT SCALE OF THIS DRAWING.
POSITIONS OF AUTHORITIES MAINS AND/OR EXISTING SERVICES ARE TO BE CHECKED PRIOR TO COMMENCEMENT OF WORK. REPORT ANY DISCREPANCIES TO THE CONSULTING ENGINEER FOR DECISION/CLARIFICATION BEFORE PROCEEDING WITH THE WORK. THIS DRAWING IS TO BE READ IN CONJUNCTION B ISSUE FOR DA
A ISSUE FOR DA
P1 PRELIMINARY
ISSUE Last revision title ROOF PLAN DATE 10.06.20 Web: www.sgce.com.au DATE 10.06.20 LANDS
CIVIL
SURVEY Issuer internal sequence and revision history Datum Scale (at original size) DRAWING IS TO BE READ IN CONJUNCTION WITH THE SPECIFICATIONS AND OTHER CONSULTANTS' DRAWINGS.

APPROVED SH Engineering Value DATE 10.06.20 1-preliminary 4-tender 2-development application 3-construction certificate A.H.D. 5 of 9 1:100 @ A1 A.B.N. 21 118 222 530 6-other 5-construction

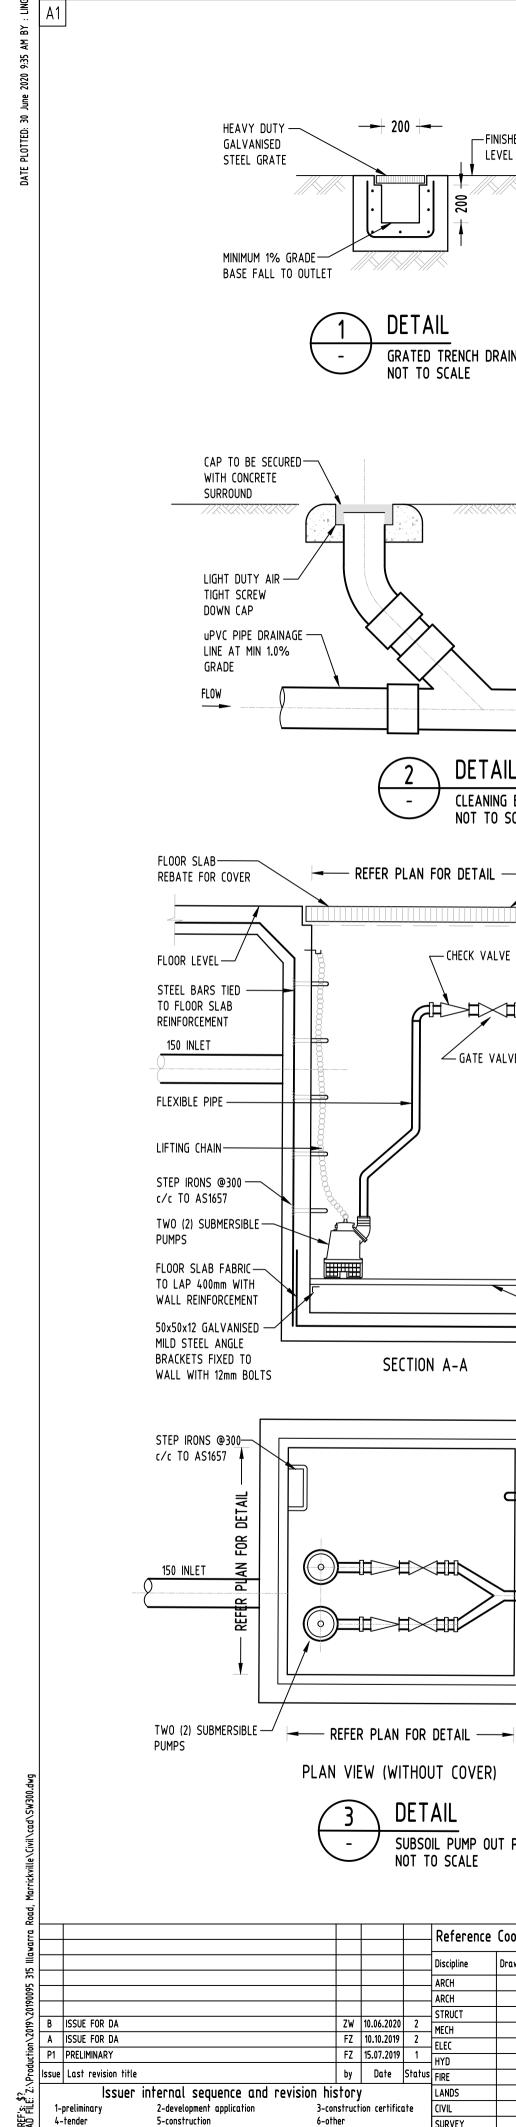

HEAVY DUTY —

GALVANISED

STEEL GRATE

MINIMUM 1% GRADE—

CAP TO BE SECURED—

WITH CONCRETE

LIGHT DUTY AIR -

uPVC PIPE DRAINAGE —

LINE AT MIN 1.0%


TIGHT SCREW DOWN CAP


GRADE


FLOW


SURROUND


BASE FALL TO OUTLET

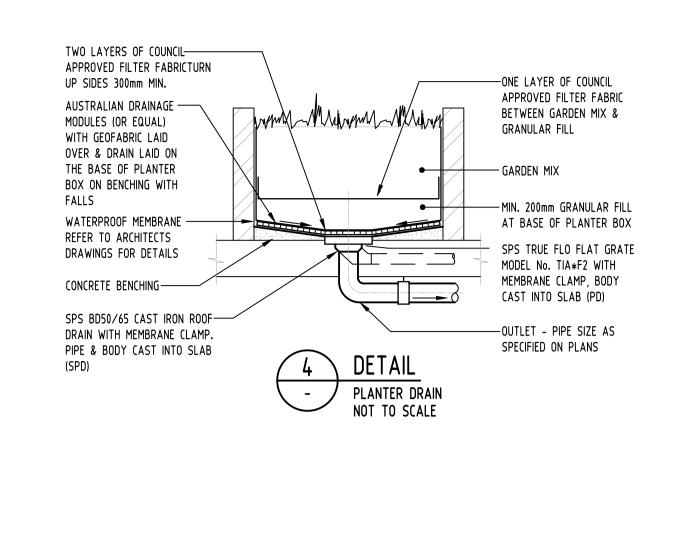


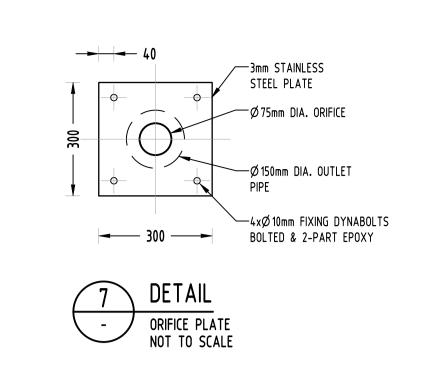

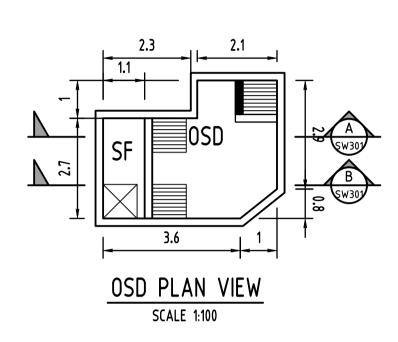

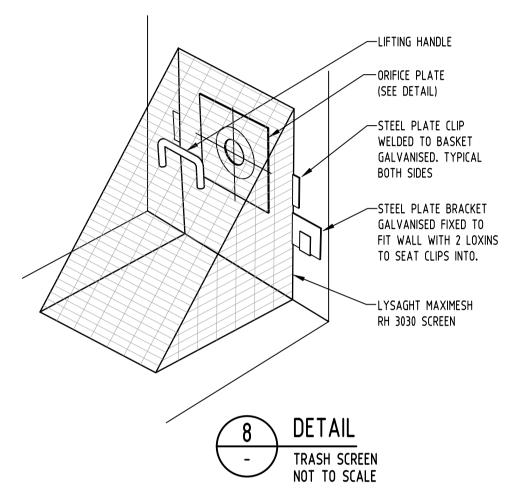

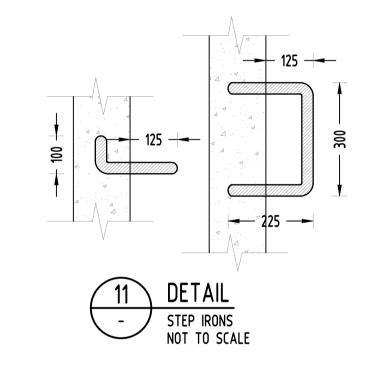

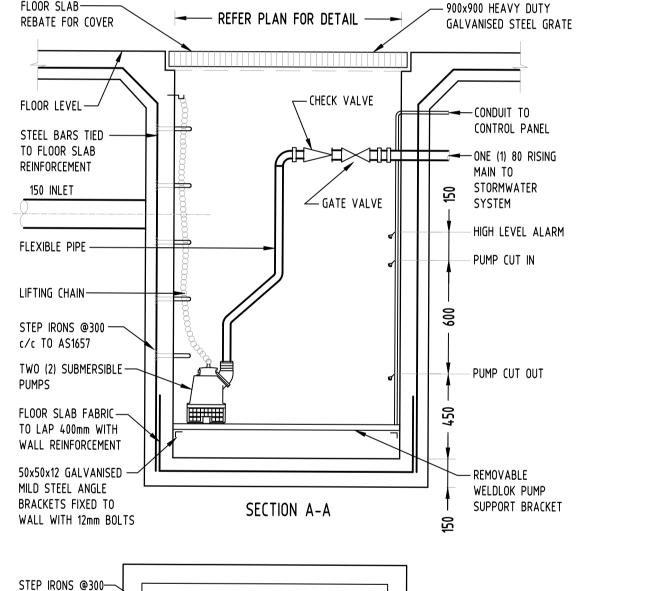

PLAN VIEW (WITHOUT COVER)

ZW 10.06.2020 2 MECH FZ 10.10.2019 2 ELEC

FZ 15.07.2019 1 HYD

by Date Status FIRE

3-construction certificate

6-other

DETAIL

NOT TO SCALE

Discipline

LANDS

SURVEY

CIVIL

SUBSOIL PUMP OUT PIT

Reference Coordination Drawing

Drawing Title and Number

-LINE OF REBATE

FOR COVER OVER

— CONDUIT TO

CONTROL PANEL

RISING MAIN TO STORMWATER

SYSTEM


CLEANING EYE

NOT TO SCALE

LEVEL

GRATED TRENCH DRAIN

NOT TO SCALE

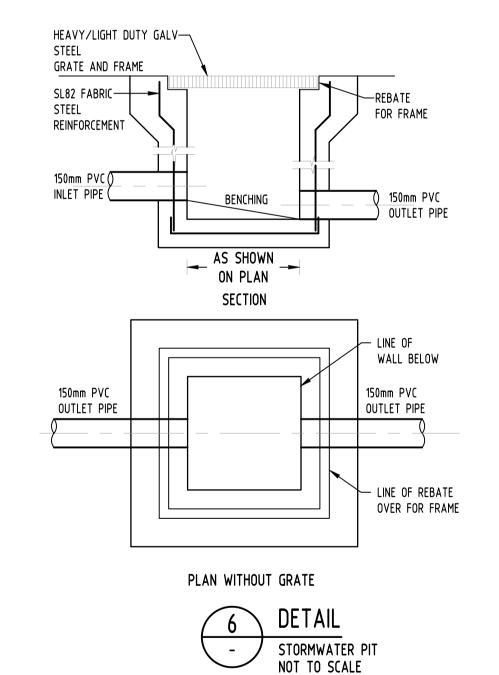

QUALITY CONTROL

DIMENSIONS NOT SHOWN TO BE CHECKED ON SITE. DO NOT SCALE OF THIS DRAWING.

DESIGNED

APPROVED SH

POSITIONS OF AUTHORITIES MAINS AND/OR
EXISTING SERVICES ARE TO BE CHECKED

PRIOR TO COMMENCEMENT OF WORK. REPORT

ANY DISCREPANCIES TO THE CONSULTING

DRAWING IS TO BE READ IN CONJUNCTION

WITH THE SPECIFICATIONS AND OTHER

CONSULTANTS' DRAWINGS.

ENGINEER FOR DECISION/CLARIFICATION BEFORE PROCEEDING WITH THE WORK. THIS DATE 10.06.20

DATE 10.06.20

DATE 10.06.20


DATE 10.06.20


WARNING: THE DESIGNS, DRAWINGS, SPECIFICATIONS AND THE COPYRIGHT HEREIN REMAIN THE SOLE INTELLECTUAL


PROPERTY OF S&G CONSULTANTS PTY LTD AND MUST

NOT BE USED, COPIED, ALTERED OR REPRODUCED


WHOLLY OR IN PART IN ANY FORM WITHOUT THE WRITTEN CONSENT OF S&G CONSULTANTS PTY LTD

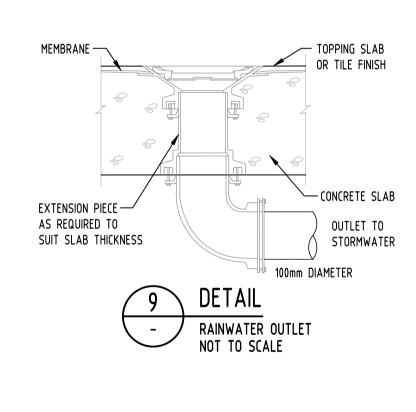

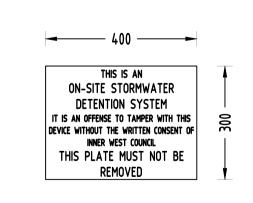

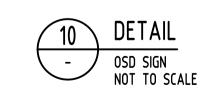

VINH & SAU

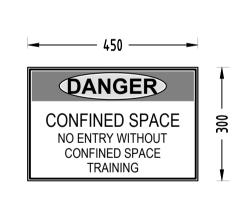





ARCHITECT



A.B.N. 21 118 222 530

PROJECT
PROPOSED
PROPOSED MIXED-USE DEVELOPMENT
315-321 ILLAWARRA ROAD, MARRICKVILL

Grid Datum

Drawing Status	FOR A	APPROVAL	
NOT	TO BE USED FOR	R CONSTRUCTION P	URPOSES
Drawing Title			
STORI	MWATER	CONCEPT	DESIGN
	DETAI	LS SHEET	
	SHEE	T 1 0F 2	

			SHEET 1 UF 2					
_	Charl	Contract of the section	Project No	Drawing No	Revision N			
).	Sheet 6 of 9	Scale (at original size) AS SHOWN	20190095	SW300	В			
•								

LEGEND:

STORMWATER LINE

- SWRM------ SWRM----- STORMWATER RISING MAIN LINE

— w — AUTHORITYWATER LINE

DOWNPIPE

RAINWATER OUTLET

PLANTER DRAINS

— SSD — SUBSOIL DRAINAGE LINE

— G — G — AUTHORITY GAS LINE

—— E —— AUTHORITY ELECTRICITY LINE

DESIGN NOTES:

TOTAL SITE AREA: 1073m²

ARCHITECTURAL PLANS.

TSS:85%

TP:60% TN:45% GP:90%

MET AS PER COUNCIL'S DCP:

SITE IS LOCATED IN INNER WEST COUNCIL LGA.

AREA BYPASSING OSD SYSTEM: 193m² (17.99%)

THE DESIGN COMPLIES WITH MARRICKVILLE COUNCIL'S

DEVELOPMENT CONTROL PLAN (DCP) & PRE-DEVELOPMENT

APPLICATION ADVICE WITH COUNCIL (REF. PDA201700210).

OSD IS REQUIRED AS PER PRE DA MEETING. IT IS SIZED

UP BY USING "DRAINS" SOFTWARE TO LIMIT PSD TO THE

EQUIVALENT FULLY PREVIOUS DISCHARGES FOR THE SITE


THE SITE IS FLOOD AFFECTED AS PER PRE DA MEETING.


FLOOR LEVELS HAVE BEEN RAISED UP AND CREST HAVE


WSUD IS REQUIRED. FOLLOWING TARGETS SHOULD BE

BEEN PROPOSED ON DRIVEWAY AS SHOWN IN

AREA. REFER TO CALCULATION TABLE FOR DETAILS.

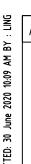

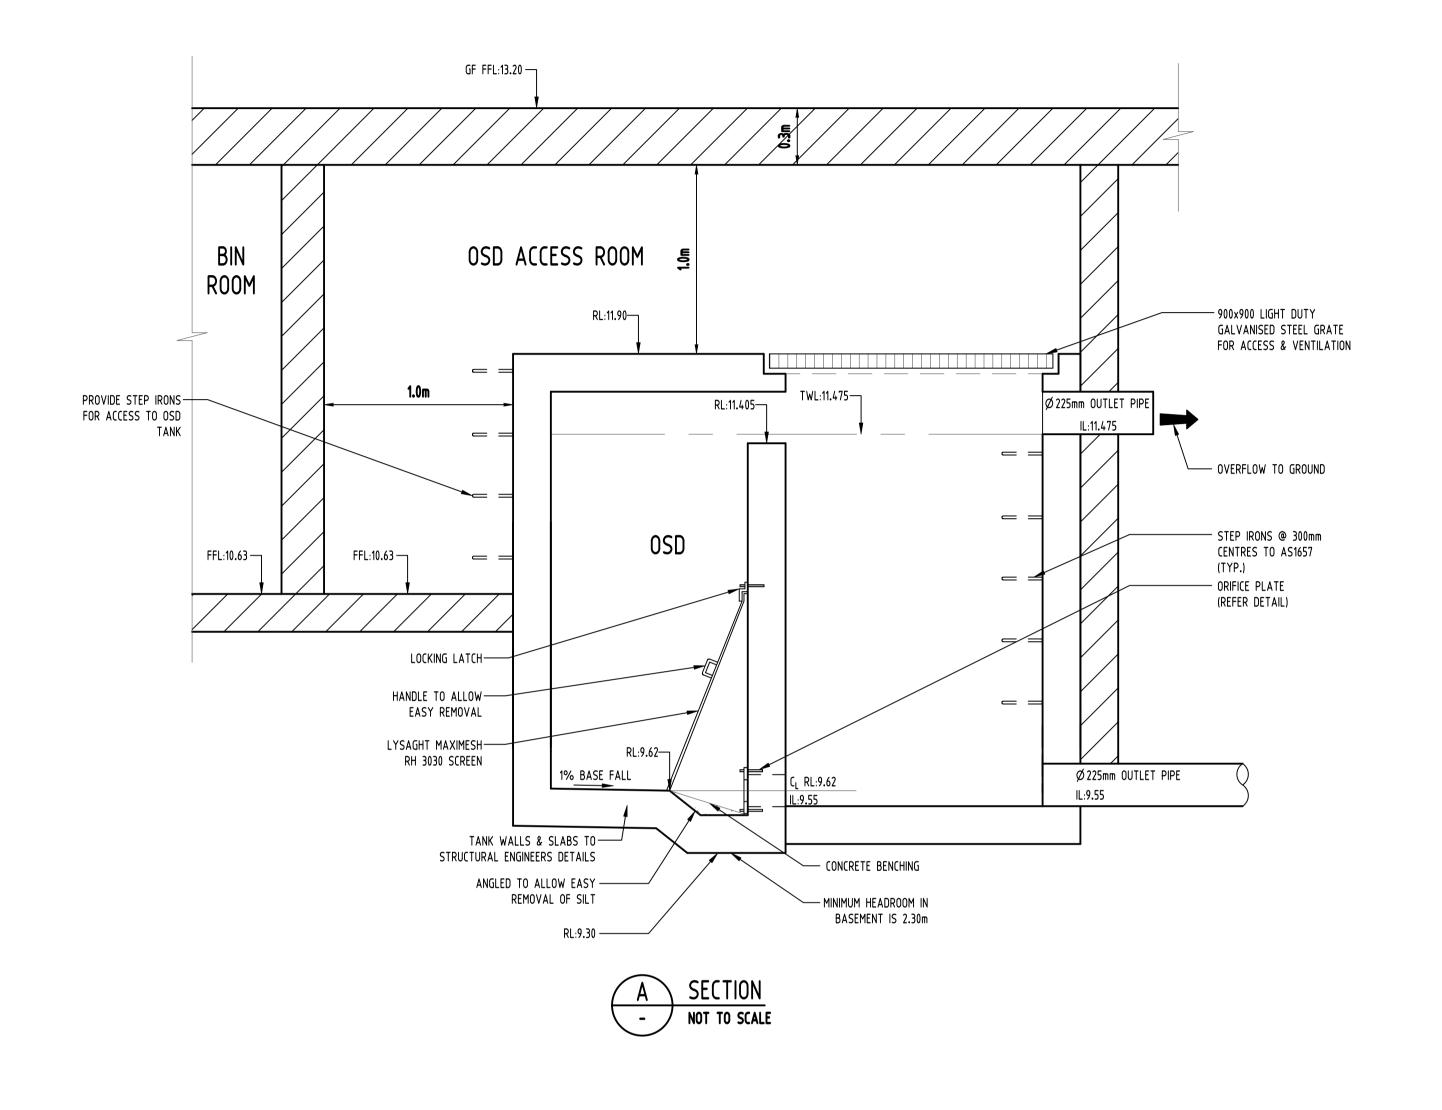

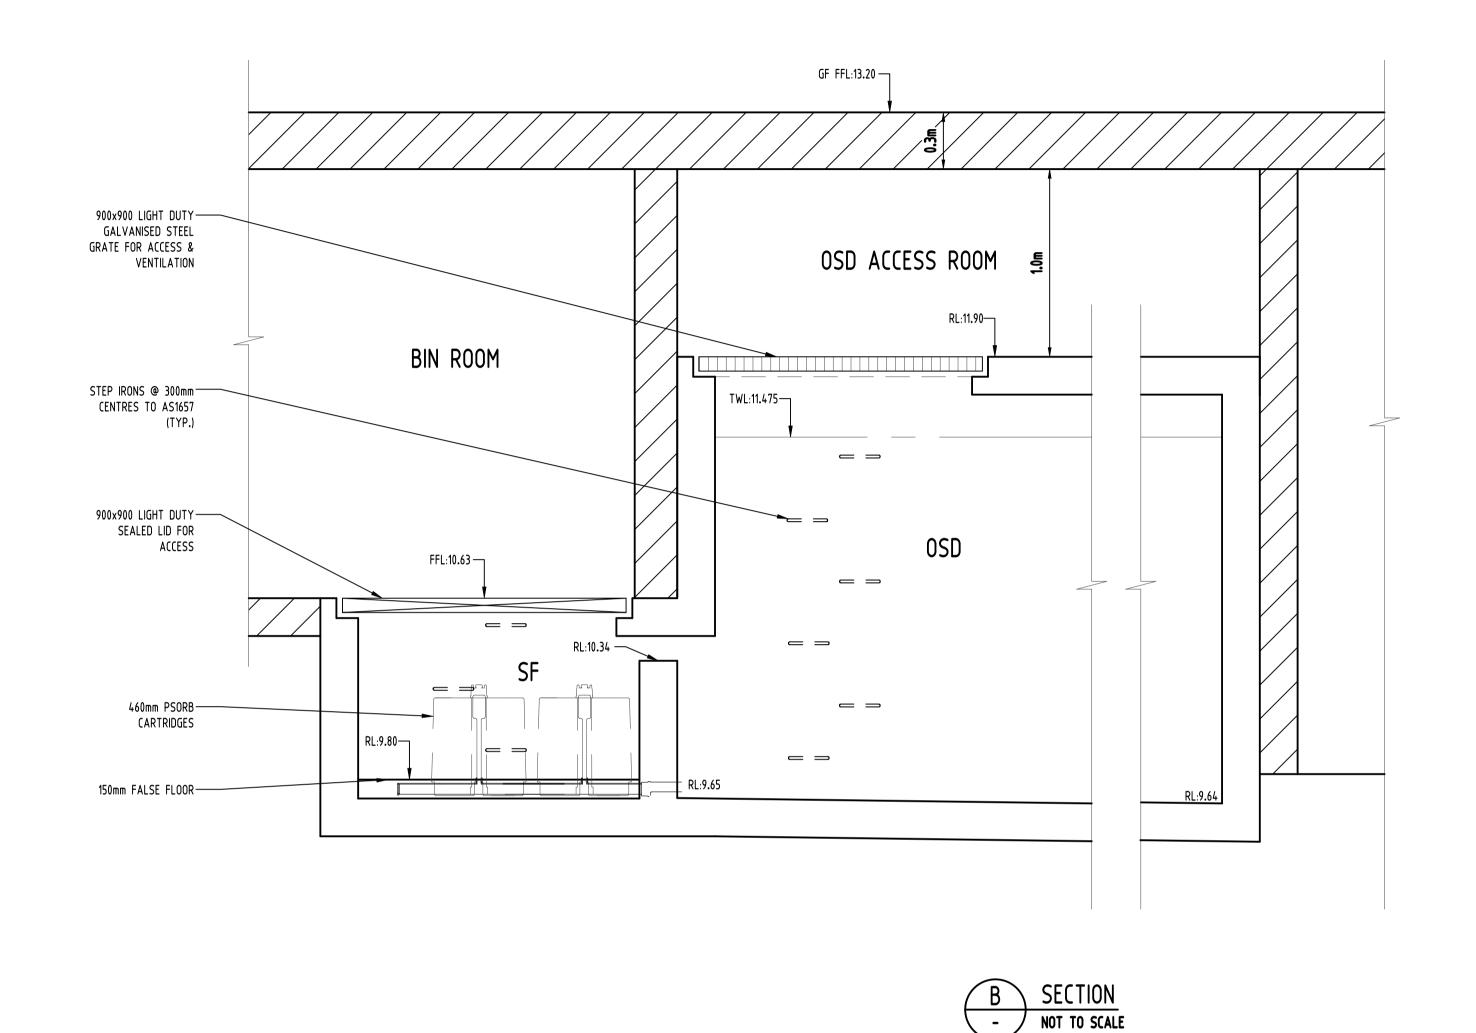

POST-DEVELOPMENT OSD CALCULATIONS TABLE:

LOT AREA (m2)	PRE-DEV IMPERVIOUS (%)	POST-DEV IMPERVIOUS (%)	STORM (YR)	PRE-DEV FLOW (m3/s)	POST-DEV FLOW (m3/s)	PIPE OUTFLOW (m3/s)	WEIR OUTFLOW (m3/s)	BYPASSING PSD (m3/s)	TOTAL PSD (m3/s)	OSD VOLUME (m3)
1073	0	82.01	2	0.014	0.027	0.010	N/A	0.001	0.011	
			5	0.025	0.035	0.012	N/A	0.003	0.015	20.85
			100	0.051	0.058	0.016	0.022	0.007	0.045	

B ISSUE FOR DA
A ISSUE FOR DA
P1 PRELIMINARY
Issue Last revision title 1-preliminary 4-tender

WARNING: THE DESIGNS, DRAWINGS, SPECIFICATIONS AND THE COPYRIGHT HEREIN REMAIN THE SOLE INTELLECTUAL Reference Coordination Drawing QUALITY CONTROL | Discipline | ARCH | ARCH | STRUCT | MECH | ELEC | HYD | by | Date | Status | FIRE | HADDS PROPERTY OF S&G CONSULTANTS PTY LTD AND MUST NOT BE USED, COPIED, ALTERED OR REPRODUCED WHOLLY OR IN PART IN ANY FORM WITHOUT THE WRITTEN CONSENT OF S&G CONSULTANTS PTY LTD DRAWN DATE 10.06.20 DIMENSIONS NOT SHOWN TO BE CHECKED ON SITE. DO NOT SCALE OF THIS DRAWING.
POSITIONS OF AUTHORITIES MAINS AND/OR EXISTING SERVICES ARE TO BE CHECKED

DESIGNED DATE 10.06.20 PRIOR TO COMMENCEMENT OF WORK. REPORT ANY DISCREPANCIES TO THE CONSULTING DATE 10.06.20 ENGINEER FOR DECISION/CLARIFICATION
BEFORE PROCEEDING WITH THE WORK. THIS LANDS Issuer internal sequence and revision history DRAWING IS TO BE READ IN CONJUNCTION
WITH THE SPECIFICATIONS AND OTHER CIVIL DATE 10.06.20 3-construction certificate APPROVED SH 2-development application 6-other 5-construction SURVEY CONSULTANTS' DRAWINGS.

VINH & SAU Engineering Value

Suite 5.03, Level 5, 156 PACIFIC HIGHWAY ST LEONARDS, NSW 2065 T: +61 2 8883 4239 Web: www.sgce.com.au

A.B.N. 21 118 222 530

PROJECT MIXED-USE DEVELOPMENT Email: office@sgce.com.au 315-321 ILLAWARRA ROAD, MARRICKVILLE

7 of 9


Datum

A.H.D.

FOR APPROVAL NOT TO BE USED FOR CONSTRUCTION PURPOSES STORMWATER CONCEPT DESIGN

DETAILS SHEET SHEET 2 OF 2

Scale (at original size) AS SHOWN

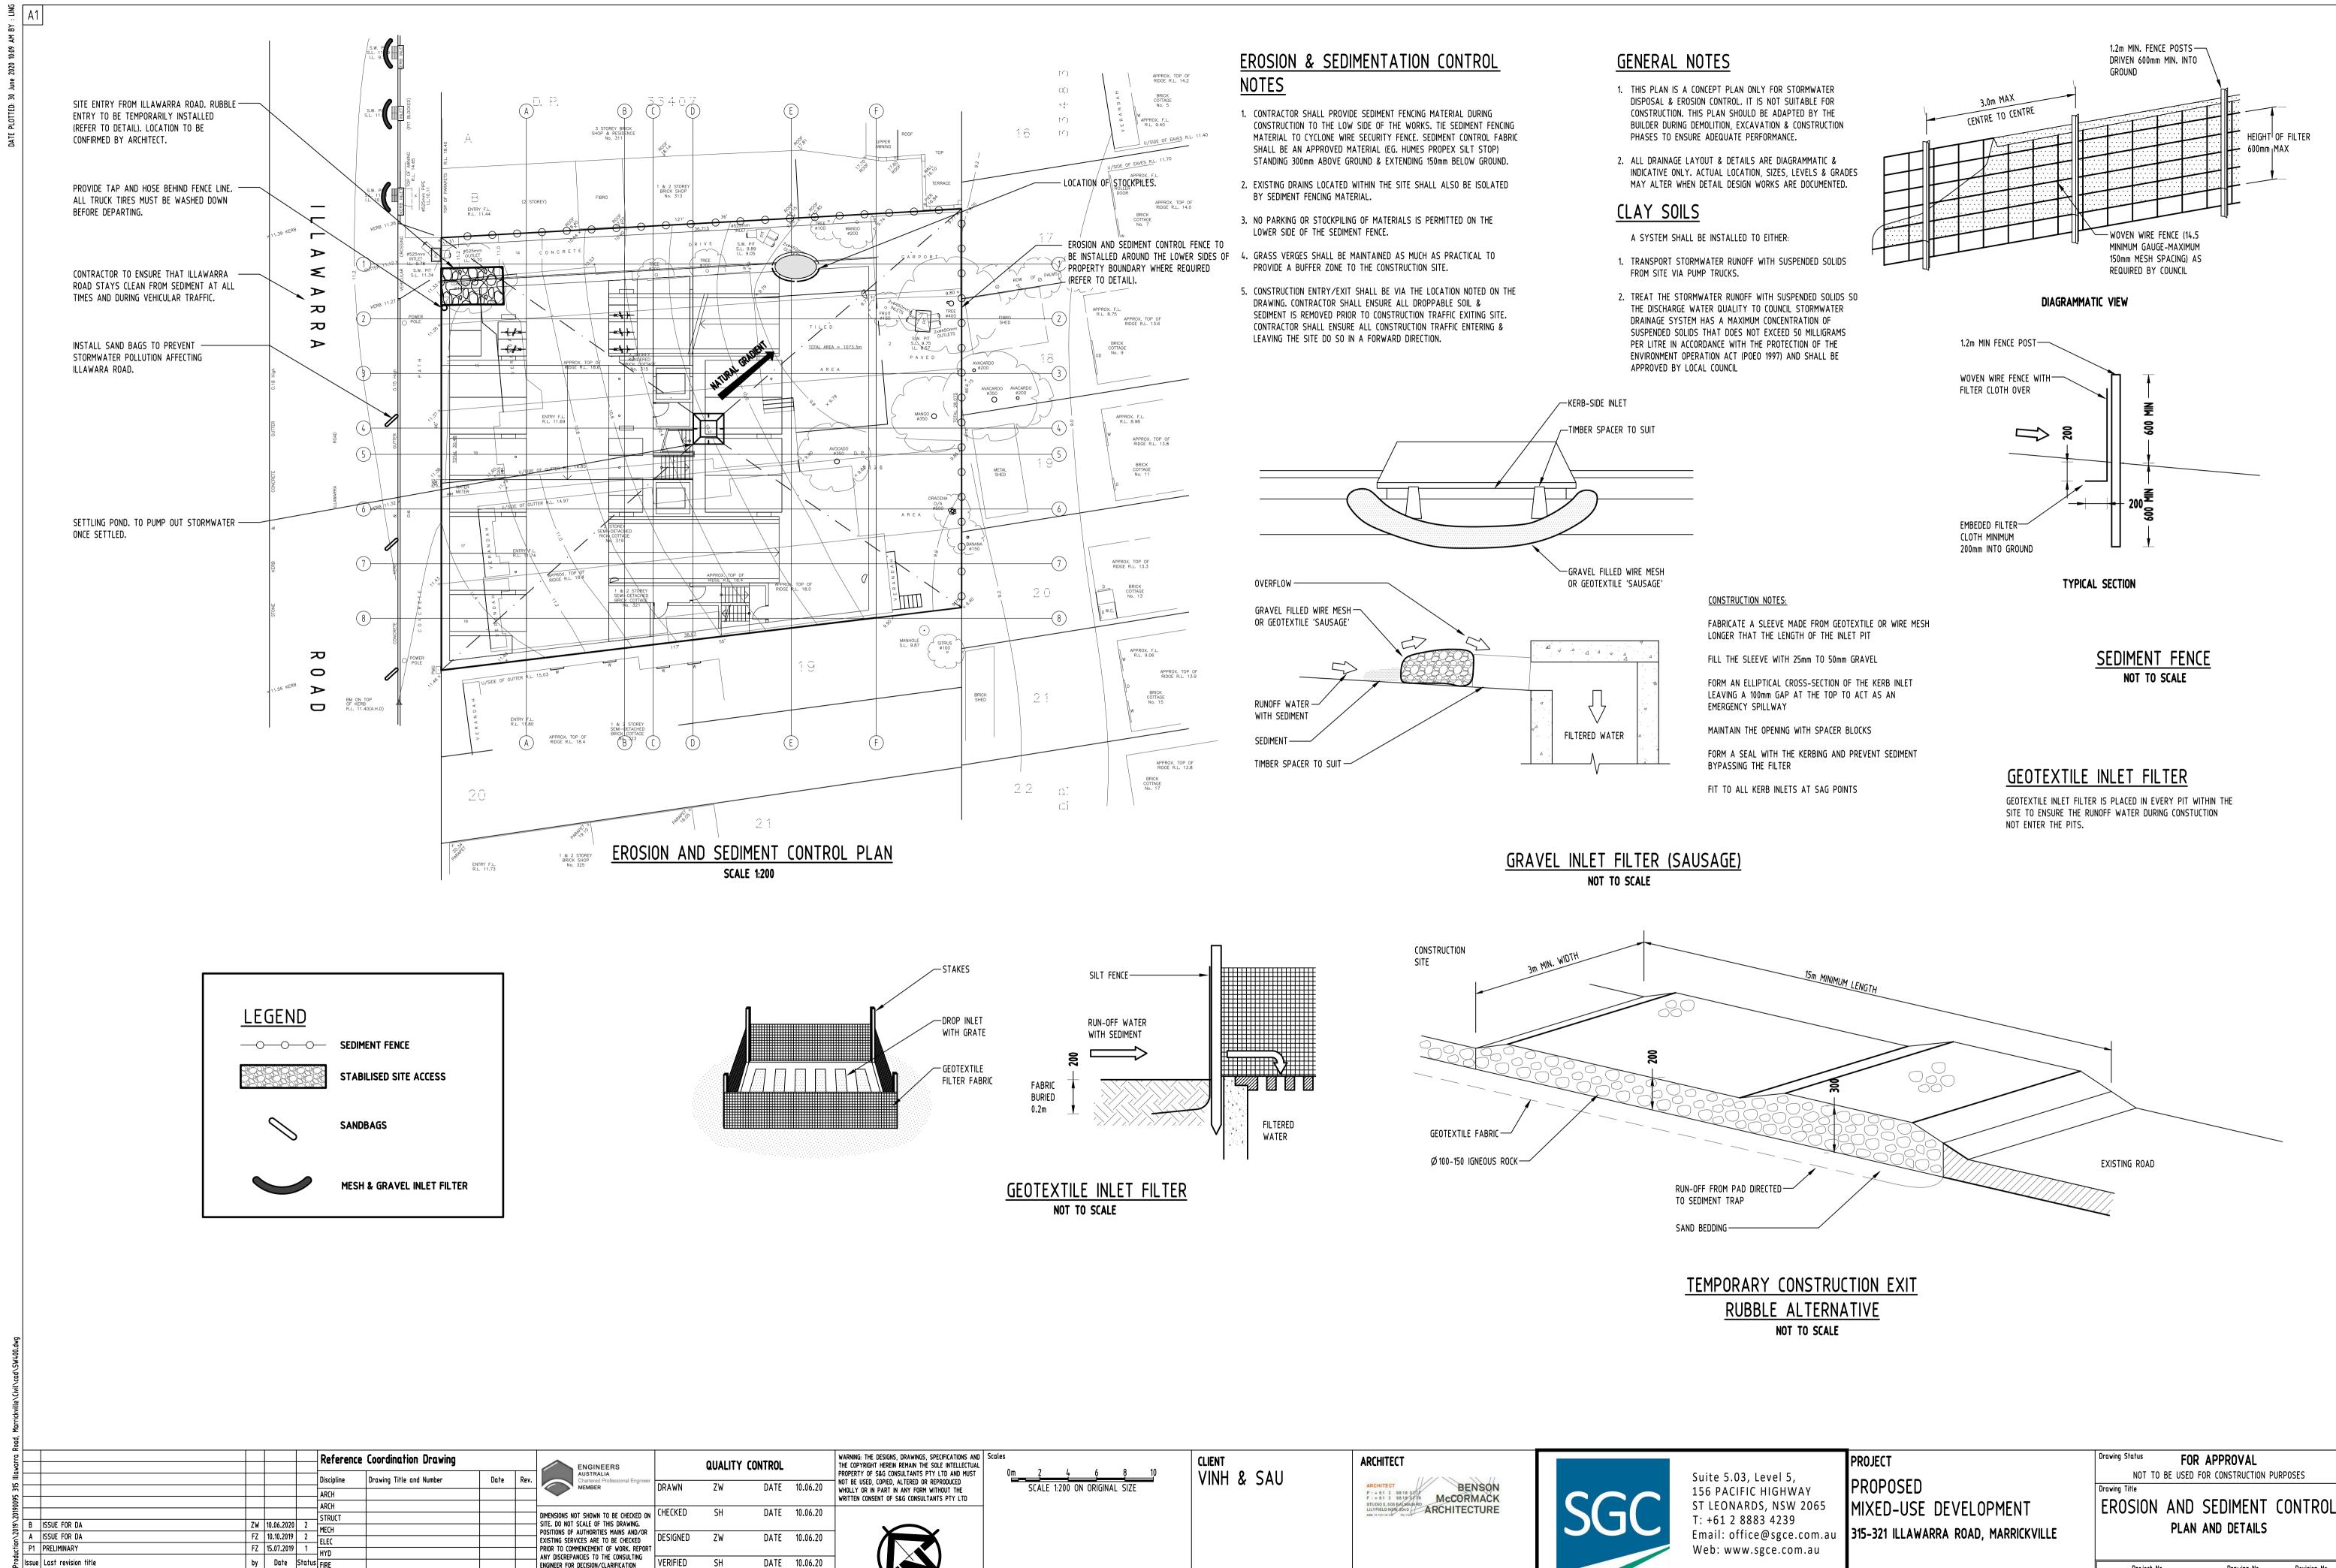

ENGINEER FOR DECISION/CLARIFICATION

BEFORE PROCEEDING WITH THE WORK, THIS

DRAWING IS TO BE READ IN CONJUNCTION

WITH THE SPECIFICATIONS AND OTHER

CONSULTANTS' DRAWINGS.

APPROVED SH

DATE 10.06.20

Issuer internal sequence and revision history

2-development application

5-construction

3-construction certificate

SURVEY

6-other

5 SW

Datum

A.B.N. 21 118 222 530

A.H.D.

8 of 9

Engineering Value

Scale (at original size)

AS SHOWN

