

C OUTDOOR SPACE RELOCATED 25/03/20 D ROOM NUMBERS REDUCED TO 6 20/07/20 28/06/21

10/09/21

E BINS RELOCATED

OPEN SPACE RELOCATED TO NORTHWEST



**14 NYRANG ROAD ORANGE NSW 2800** 


Date Printed Drawn JG ĴĜ 10/9/21

Job Number 1917 Scale As shown @ A3

#### **ROOF AND SITE PLAN**

Drawing Number



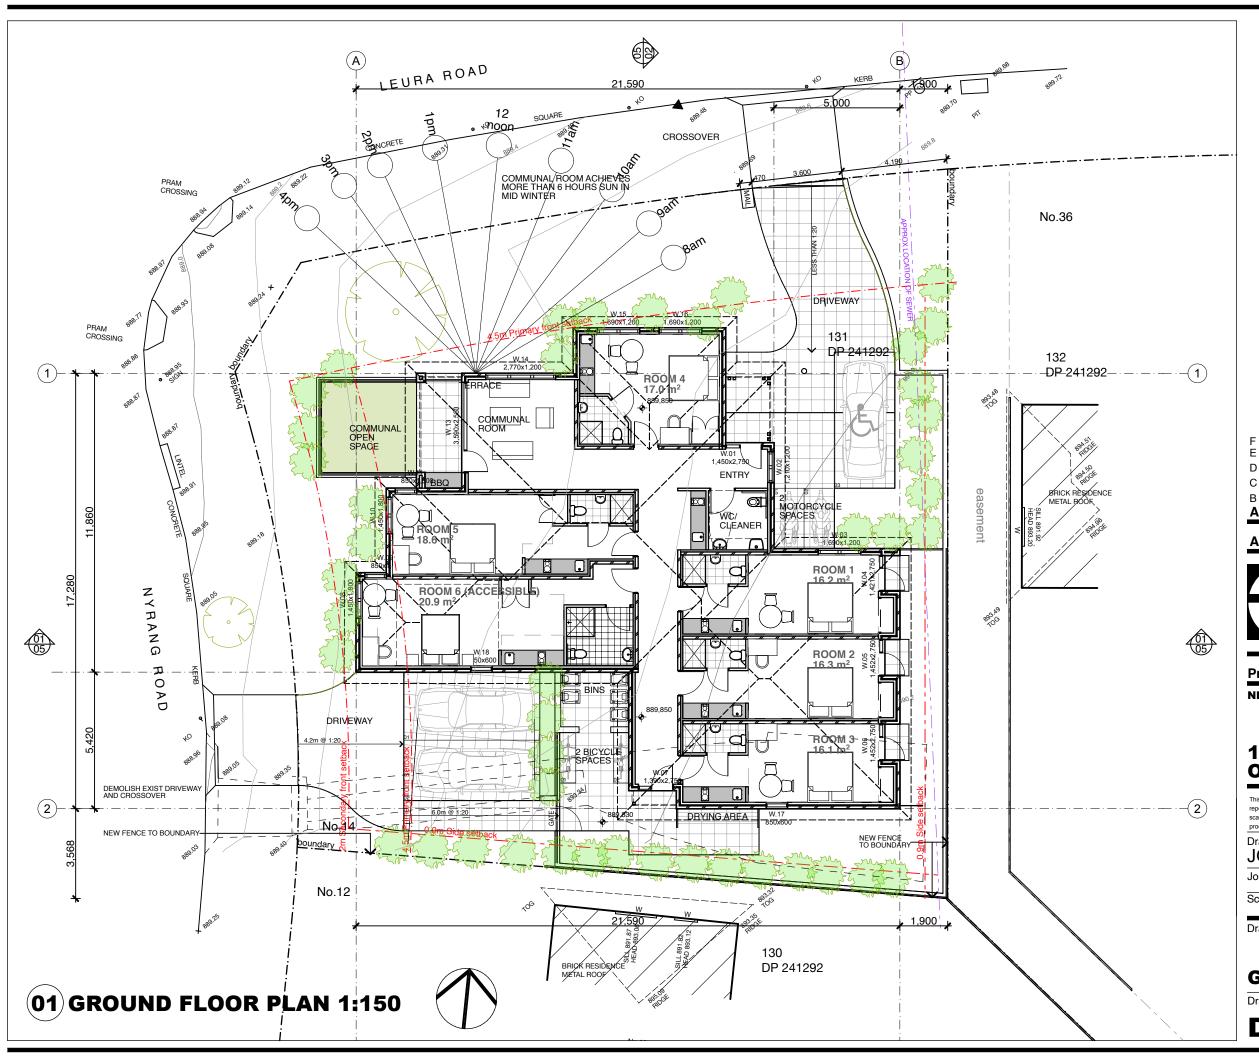

OPEN SPACE RELOCATED TO

NORTHWEST

E BINS RELOCATED

D ROOM NUMBERS REDUCED TO 6

C OUTDOOR SPACE RELOCATED

B ROOM NUMBERS INCREASED TO 8 01/06/19

Amendments\_

#### Architect



### Fortey + Grant Architecture

10//09/21

28/06/21

20/07/20

25/03/20

Suite 3/ Level 1, 1141 Botany Lane
Mascot NSW 2020
mob: 0401 822 223
email: james@fgarch.com.au

**Project Details** 

**NEW BOARDING HOUSE AT** 

#### 14 NYRANG ROAD ORANGE NSW 2800

This drawing should be read in conjunction with all relevant contracts, specifications reports and drawings. All dimensions used to be figured dimensions only. Do not scale from drawings. Report any discepencies to the Architect for a decision before proceeding with work.

Drawn JG	Approved JG	Date Printed 10/9/21
Job Number	1917	


As shown @ A3


Drawing name

#### **GROUND FLOOR PLAN**

Drawing Number

Amendment

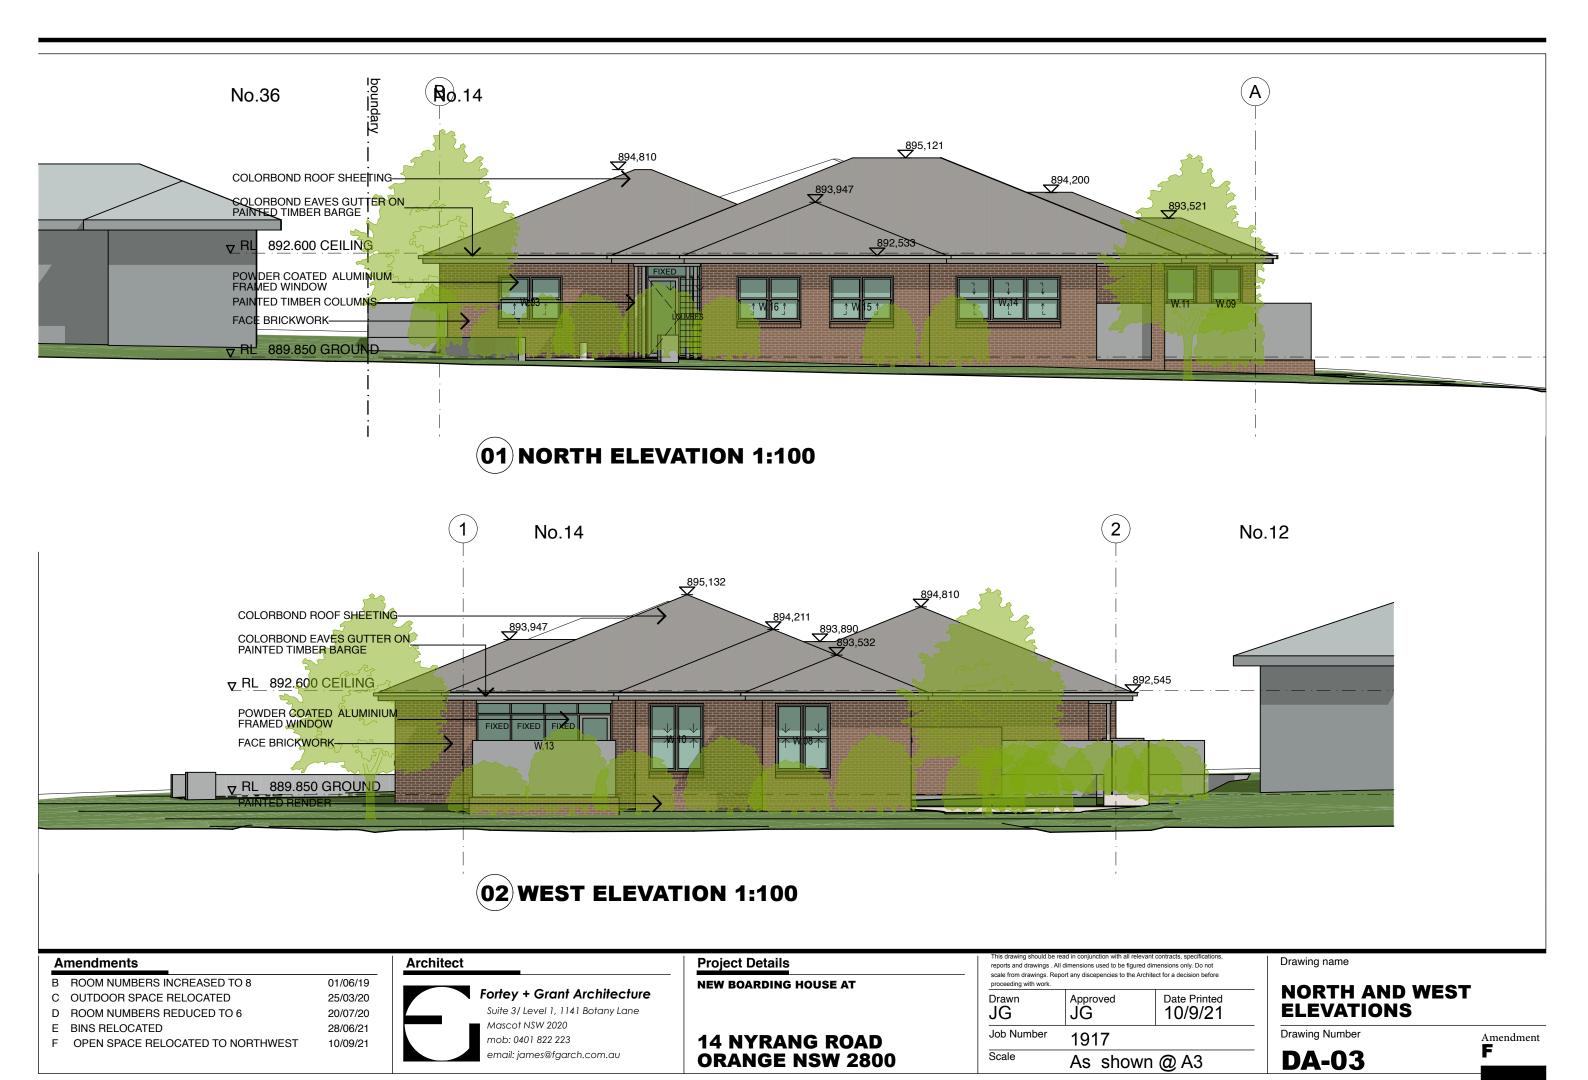

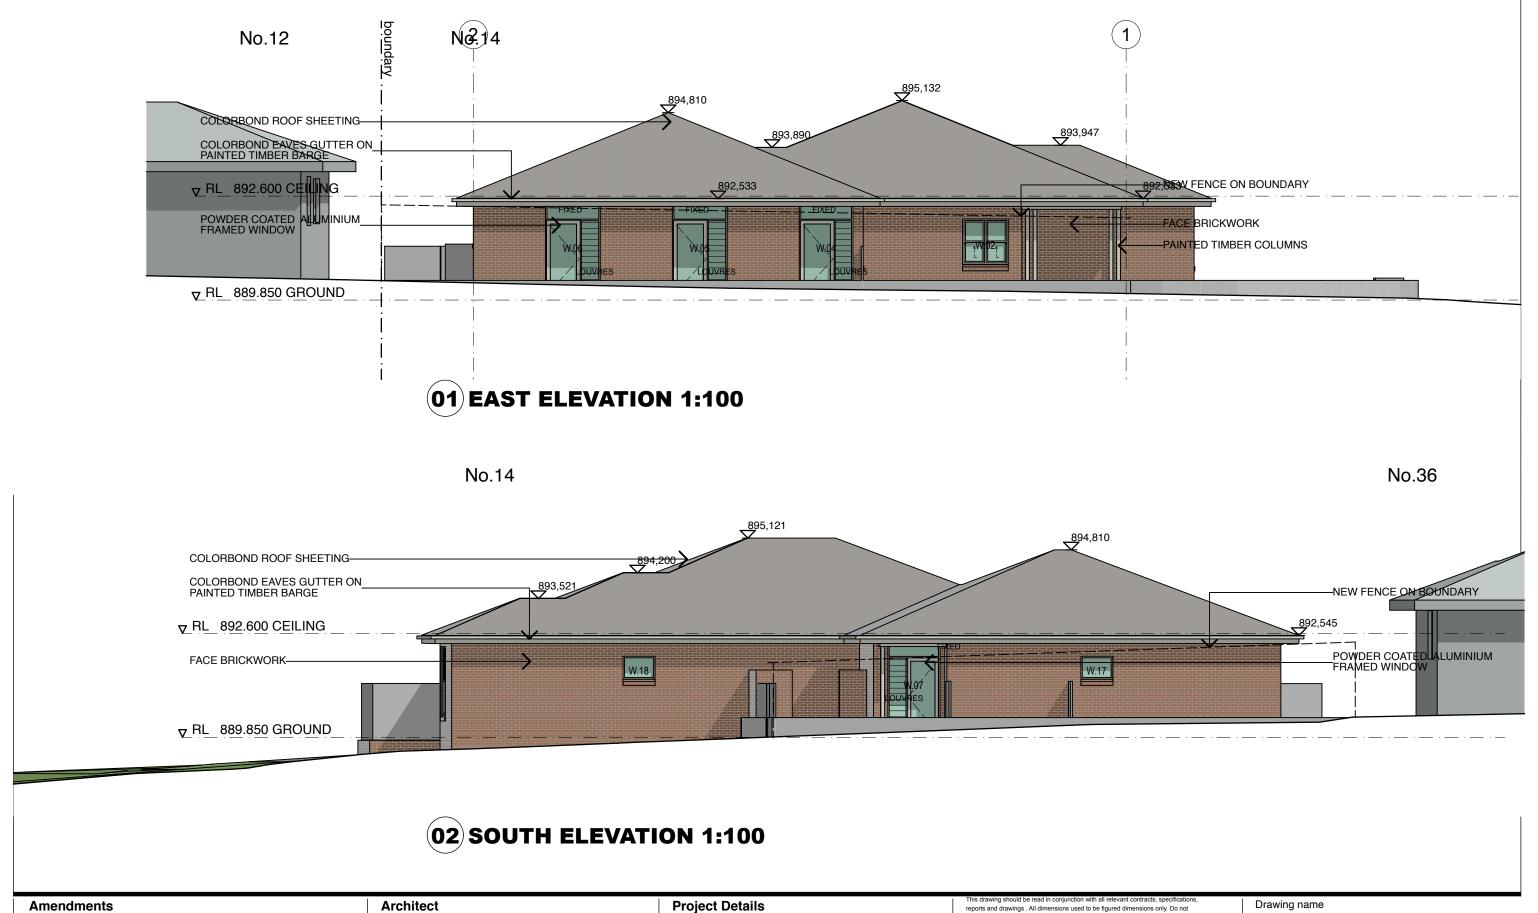

#### 01/06/19 B ROOM NUMBERS INCREASED TO 8 C OUTDOOR SPACE RELOCATED 25/03/20 D ROOM NUMBERS REDUCED TO 6 20/07/20 28/06/21 E BINS RELOCATED F OPEN SPACE RELOCATED TO NORTHWEST 10/09/21



**Project Details NEW BOARDING HOUSE AT** 

**14 NYRANG ROAD ORANGE NSW 2800** 

reports and drawings . All dimensions used to be figured dimensions only. Do not scale from drawings. Report any discepencies to the Architect for a decision before proceeding with work.


Drawn <b>JG</b>	Approved JG	Date Printed 10/9/21
Job Number	1917	
Scale	As show	/n @ A3

Drawing name

**EAST AND SOUTH ELEVATIONS** 


Drawing Number **DA-04** 

Amendment

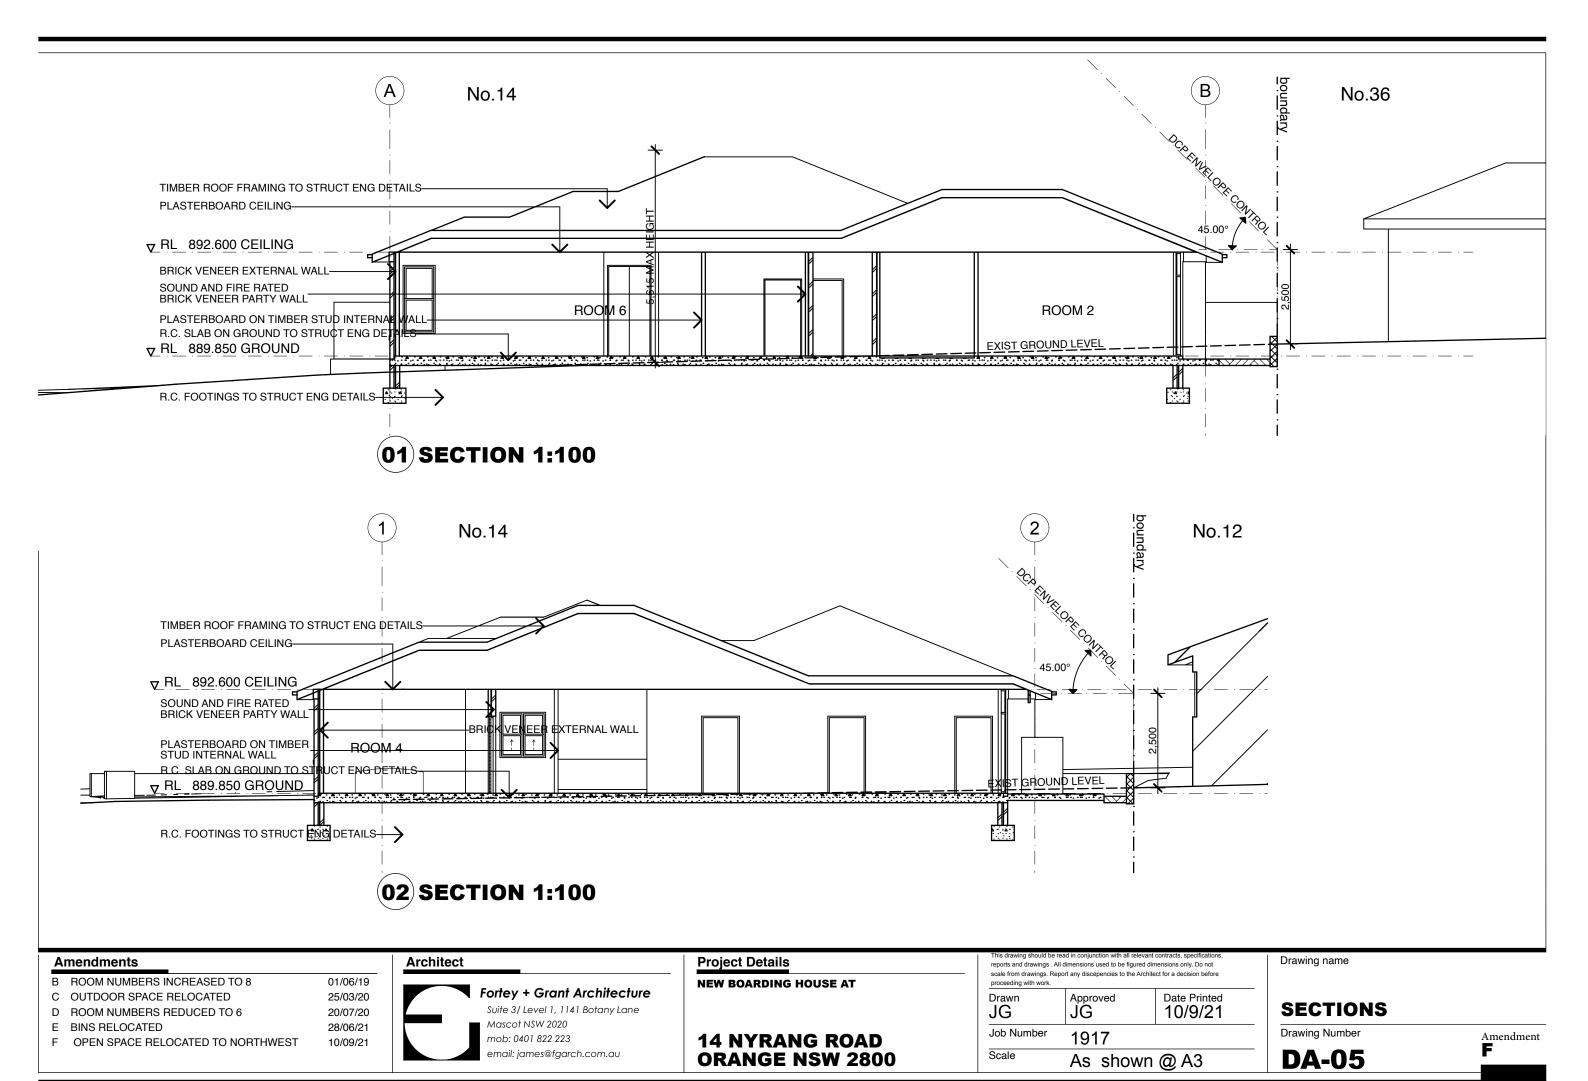



(01) MATERIALS VIEW

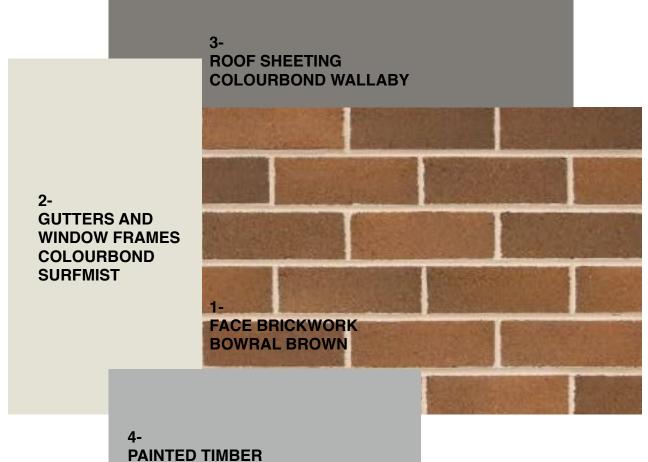

#### **Amendments**

B ROOM NUMBERS INCREASED TO 8 01/06/19 C OUTDOOR SPACE RELOCATED 25/03/20 D ROOM NUMBERS REDUCED TO 6 20/07/20 28/06/21

E BINS RELOCATED

F OPEN SPACE RELOCATED TO NORTHWEST

#### Architect

10/09/21

Fortey + Grant Architecture Suite 3/ Level 1, 1141 Botany Lane Mascot NSW 2020 mob: 0401 822 223 email: james@fgarch.com.au

# **Project Details**

**NEW BOARDING HOUSE AT** 

**14 NYRANG ROAD ORANGE NSW 2800** 

scale from drawings. Report any discepencies to the Architect for a decision before proceeding with work.

**DULUX MILTON MOON** 

Drawn Date Printed JG ĴĜ 10/9/21 Job Number 1917 Scale


As shown @ A3

Drawing name

### **MATERIALS AND FINISHES**

Drawing Number



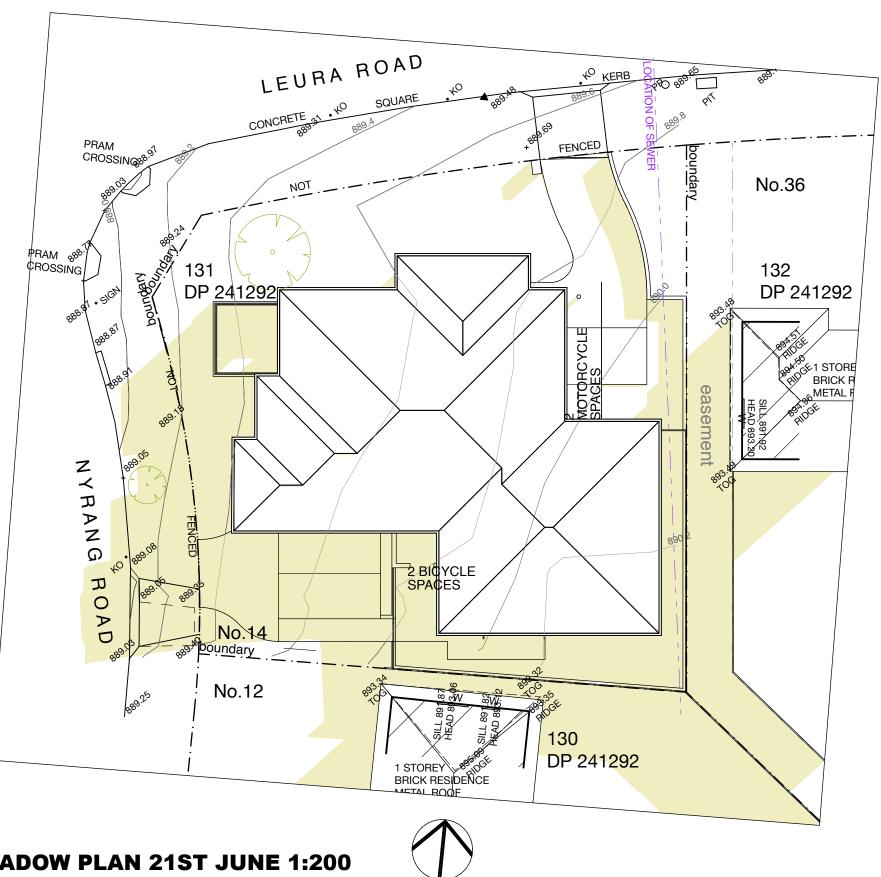

9 AM **3 PM 12 NOON** 

(02) SHADOW PLAN 21ST JUNE 1:200

**Amendments** 

B ROOM NUMBERS INCREASED TO 8 01/06/19 C OUTDOOR SPACE RELOCATED 25/03/20 D ROOM NUMBERS REDUCED TO 6 20/07/20 28/06/21 E BINS RELOCATED F OPEN SPACE RELOCATED TO NORTHWEST 10/09/21

**Architect** 



**Project Details** 

**NEW BOARDING HOUSE AT** 

**14 NYRANG ROAD ORANGE NSW 2800** 


reports and drawings . All dimensions used to be figured dimensions only. Do not scale from drawings. Report any discepencies to the Architect for a decision before

proceeding with work. Drawn Date Printed JG ĴĜ 10/9/21 Job Number 1917 Scale As shown @ A3

**SHADOW DIAGRAM JUNE 21ST 9 AM** 

Drawing Number



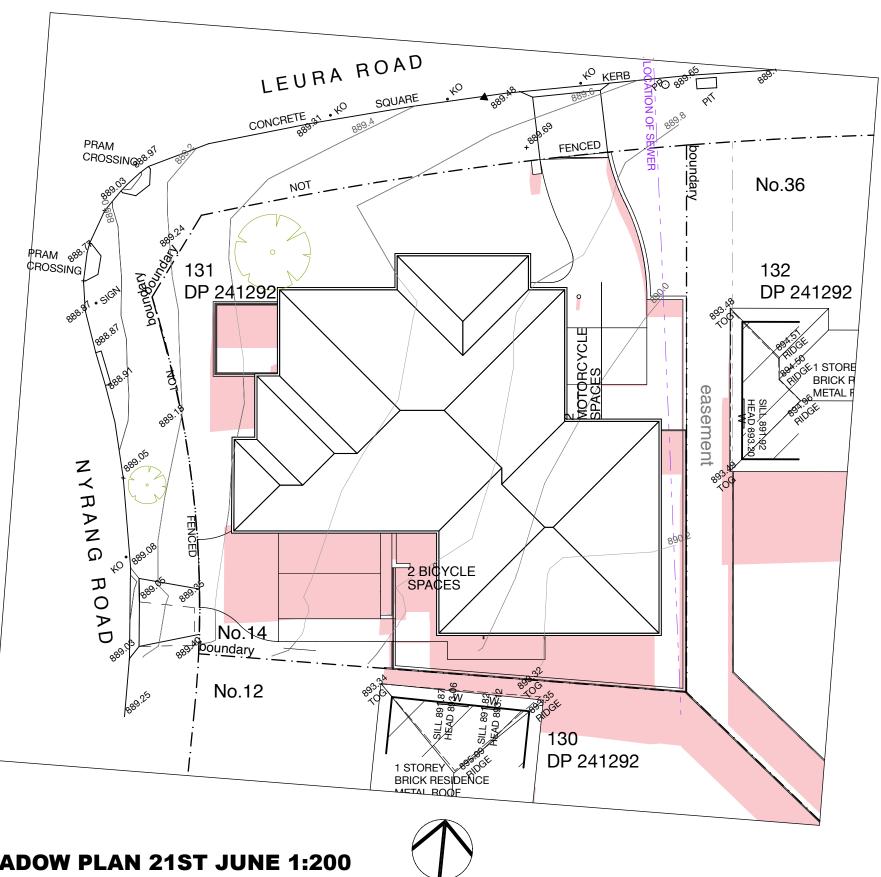

9 AM **3 PM 12 NOON** 

(02) SHADOW PLAN 21ST JUNE 1:200

**Amendments** 

B ROOM NUMBERS INCREASED TO 8 01/06/19 C OUTDOOR SPACE RELOCATED 25/03/20 D ROOM NUMBERS REDUCED TO 6 20/07/20 28/06/21 E BINS RELOCATED F OPEN SPACE RELOCATED TO NORTHWEST 10/09/21

**Architect** 



**Project Details** 

**NEW BOARDING HOUSE AT** 

**14 NYRANG ROAD ORANGE NSW 2800** 

reports and drawings . All dimensions used to be figured dimensions only. Do not scale from drawings. Report any discepencies to the Architect for a decision before


proceeding with work. Drawn Date Printed JG ĴĜ 10/9/21 Job Number 1917 Scale As shown @ A3

Drawing name

### **SHADOW DIAGRAM JUNE 21ST 12 NOON**

Drawing Number

Amendment

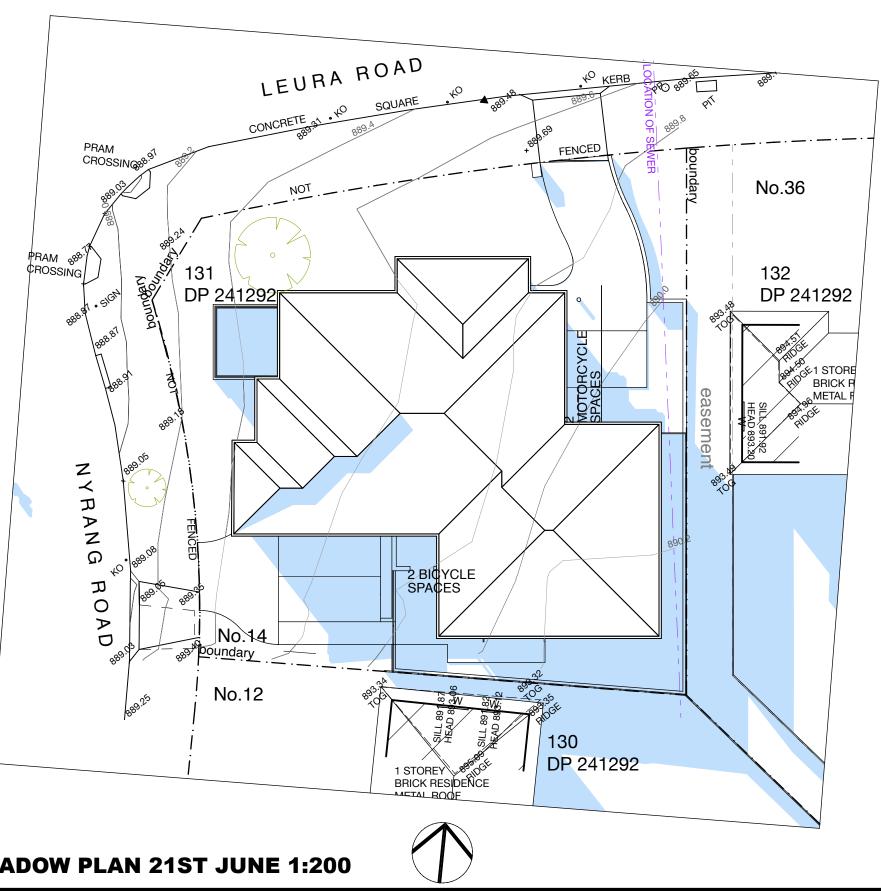

9 AM **3 PM 12 NOON** 

(02) SHADOW PLAN 21ST JUNE 1:200

10/09/21

**Amendments** 

B ROOM NUMBERS INCREASED TO 8 01/06/19 C OUTDOOR SPACE RELOCATED 25/03/20 D ROOM NUMBERS REDUCED TO 6 20/07/20 28/06/21 E BINS RELOCATED

F OPEN SPACE RELOCATED TO NORTHWEST

**Architect** 



**Project Details** 

**NEW BOARDING HOUSE AT** 

**14 NYRANG ROAD ORANGE NSW 2800** 


reports and drawings . All dimensions used to be figured dimensions only. Do not scale from drawings. Report any discepencies to the Architect for a decision before

proceeding with work. Drawn Date Printed JG ĴĜ 10/9/21 Job Number 1917 Scale As shown @ A3


**SHADOW DIAGRAM JUNE 21ST 3 PM** 

Drawing Number




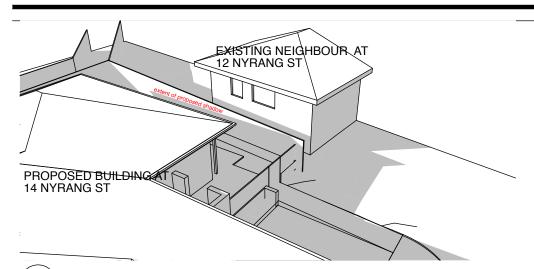

# (01) VIEW JUNE 21ST 9 AM

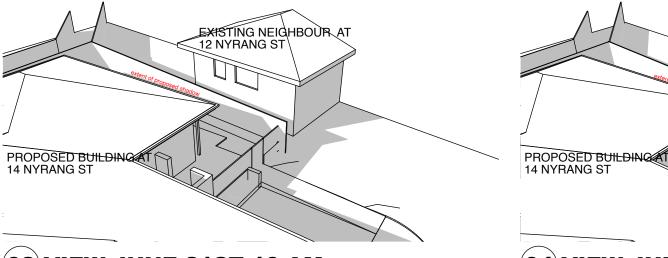

# (02) VIEW JUNE 21ST 10 AM

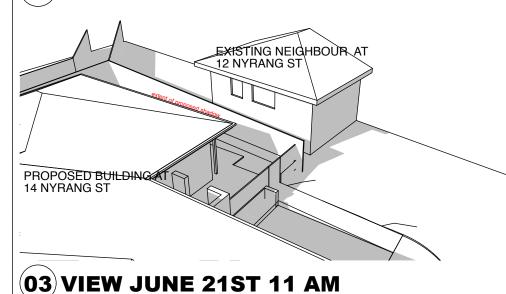

# **04** VIEW JUNE 21ST 12 NOON

#### **CONCLUSION-**

THE SHADOWS FROM THE PROPOSED DEVELOPMENT HAVE NO EFFECT ON THE SOUTHERN NEIGHBOUR. THIS IS OBVIOUS AS THE PROPOSED DEVELOPMENT IS A ONE STOREY BUILDING WHOSE SHADOWS DO NOT GO HIGHER THAN THE BOUNDARY FENCE. THE NEIGHBOUR'S DAYLIGHT IS SIMILARLY UNAFFECTED

EXISTING NEIGHBOUR AT

12 NYRANG ST


#### **CALCULATIONS-**

SOUTHERN NEIGHBOUR SOLAR ACCESS LOSS 0% SOUTHERN NEIGHBOUR DAYLIGHT ACCESS LOSS 0%




(05) VIEW JUNE 21ST 1 PM

PROPOSED BUILDING AT

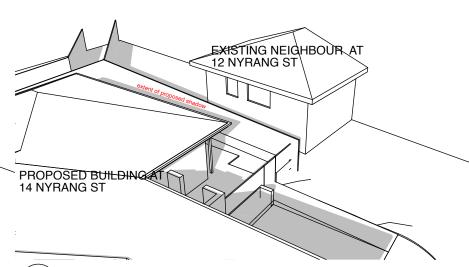

EXISTING NEIGHBOUR AT 12 NYRANG ST

# (06) VIEW JUNE 21ST 2 PM

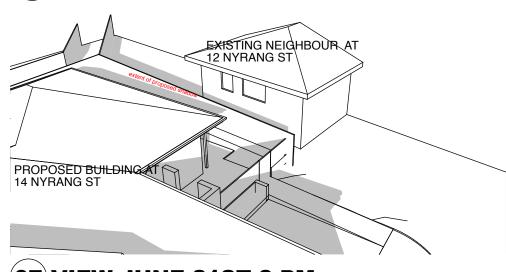

# (07) VIEW JUNE 21ST 3 PM

# US VIEW JONE 2191 11 AN

<u>A</u>	mendments	
В	ROOM NUMBERS INCREASED TO 8	01/06/19
С	OUTDOOR SPACE RELOCATED	25/03/20
D	ROOM NUMBERS REDUCED TO 6	20/07/20
Ε	BINS RELOCATED	28/06/21
F	OPEN SPACE RELOCATED TO NORTHWEST	10/09/21

# Architect

Fortey + Grant Architecture
Suite 3/ Level 1, 1141 Botany Lane
Mascot NSW 2020
mob: 0401 822 223
email: james@fgarch.com.au

## **Project Details**

NEW BOARDING HOUSE AT

14 NYRANG ROAD ORANGE NSW 2800

# This drawing should be read in conjunction with all relevant contracts, specifications, reports and drawings . All dimensions used to be figured dimensions only. Do not scale from drawinos. Report any discepencies to the Architect for a decision before

Drawn
JG
Job Number
Scale

Approved
JG
JOP 10/9/21

Approved
10/9/21

Approved
10/9/21


As shown @ A3

#### Drawing name

# **SHADOW VIEWS**

Drawing Number



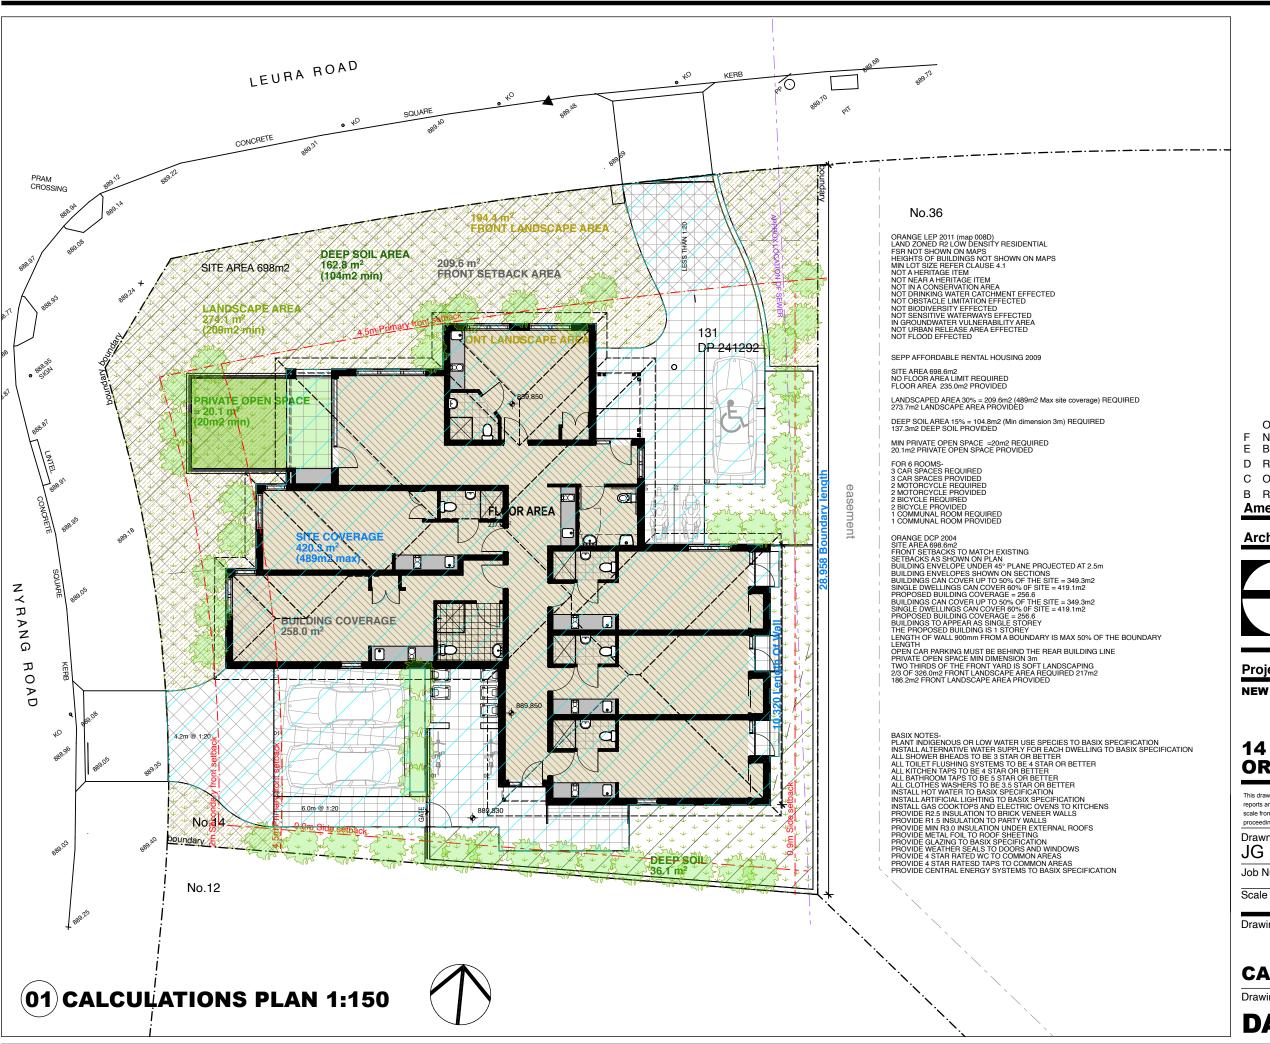

OPEN SPACE RELOCATED TO

NORTHWEST 10/08/21 E BINS RELOCATED 28/06/21 D ROOM NUMBERS REDUCED TO 6 20/07/20 C OUTDOOR SPACE RELOCATED 25/03/20

B ROOM NUMBERS INCREASED TO 8 01/06/19 Amendments

#### **Architect**



#### Fortey + Grant Architecture

Suite 3/ Level 1, 1141 Botany Lane Mascot NSW 2020 mob: 0401 822 223 email: james@fgarch.com.au

**Project Details** 

**NEW BOARDING HOUSE AT** 

#### **14 NYRANG ROAD ORANGE NSW 2800**

This drawing should be read in conjunction with all relevant contracts, specifications reports and drawings . All dimensions used to be figured dimensions only. Do not scale from drawings. Report any discepencies to the Architect for a decision before proceeding with work.

Date Printed Drawn Approved 10/9/21 JG JG Job Number 1917

As shown @ A3

Drawing name

# **CALCULATIONS**

**Drawing Number** 





















#### **CHARCTERISTIC MATERIALS-**

WALLS-1 FACE BRICK **2 PAINTED CLADDING** 

**ROOFS-3 CERAMIC /CONCRETE TILE 4 STEEL SHEET** 

#### **CHARACTERISTIC FORMS**

**5 ONE STOREY (ALL BUILDINGS)** 6 MEDIUM TO LOW ROOF PITCH (ALL BUILDINGS **7 PROMINENT DRIVEWAY 8 PARKING NOT UNDER COVER** 

#### **CHARACTERISTIC LANDSCAPING**

-GRASS IS THE DOMINANT FORM OF LANDSCAPING -LOW BUSHES AND SHRUBS ARE THE **SECONDARY DOMINANT FORM** -NO LARGE TREES

-SMALL AMOUNTS OF MEDIUM AND SMALL TREES







#### **Amendments**

B ROOM NUMBERS INCREASED TO 8

C OUTDOOR SPACE RELOCATED

D ROOM NUMBERS REDUCED TO 6

E BINS RELOCATED

F OPEN SPACE RELOCATED TO NORTHWEST

#### **Architect**

01/06/19

25/03/20

20/07/20

28/06/21

06/09/21

Fortey + Grant Architecture Suite 3/ Level 1, 1141 Botany Lane

Mascot NSW 2020 mob: 0401 822 223 email: james@fgarch.com.au

### **Project Details**

**NEW BOARDING HOUSE AT** 

**14 NYRANG ROAD ORANGE NSW 2800** 

## reports and drawings . All dimensions used to be figured dimensions only. Do not

scale from drawings. Report any discepencies to the Architect for a decision before


Drawn <b>JG</b>	Approved <b>JG</b>	Date Printed 10/9/21
Job Number	1917	
Scale	As show	n @ A3

#### Drawing name

#### **NEIGHBOURHOOD CHARACTER ANALYSIS**

Drawing Number



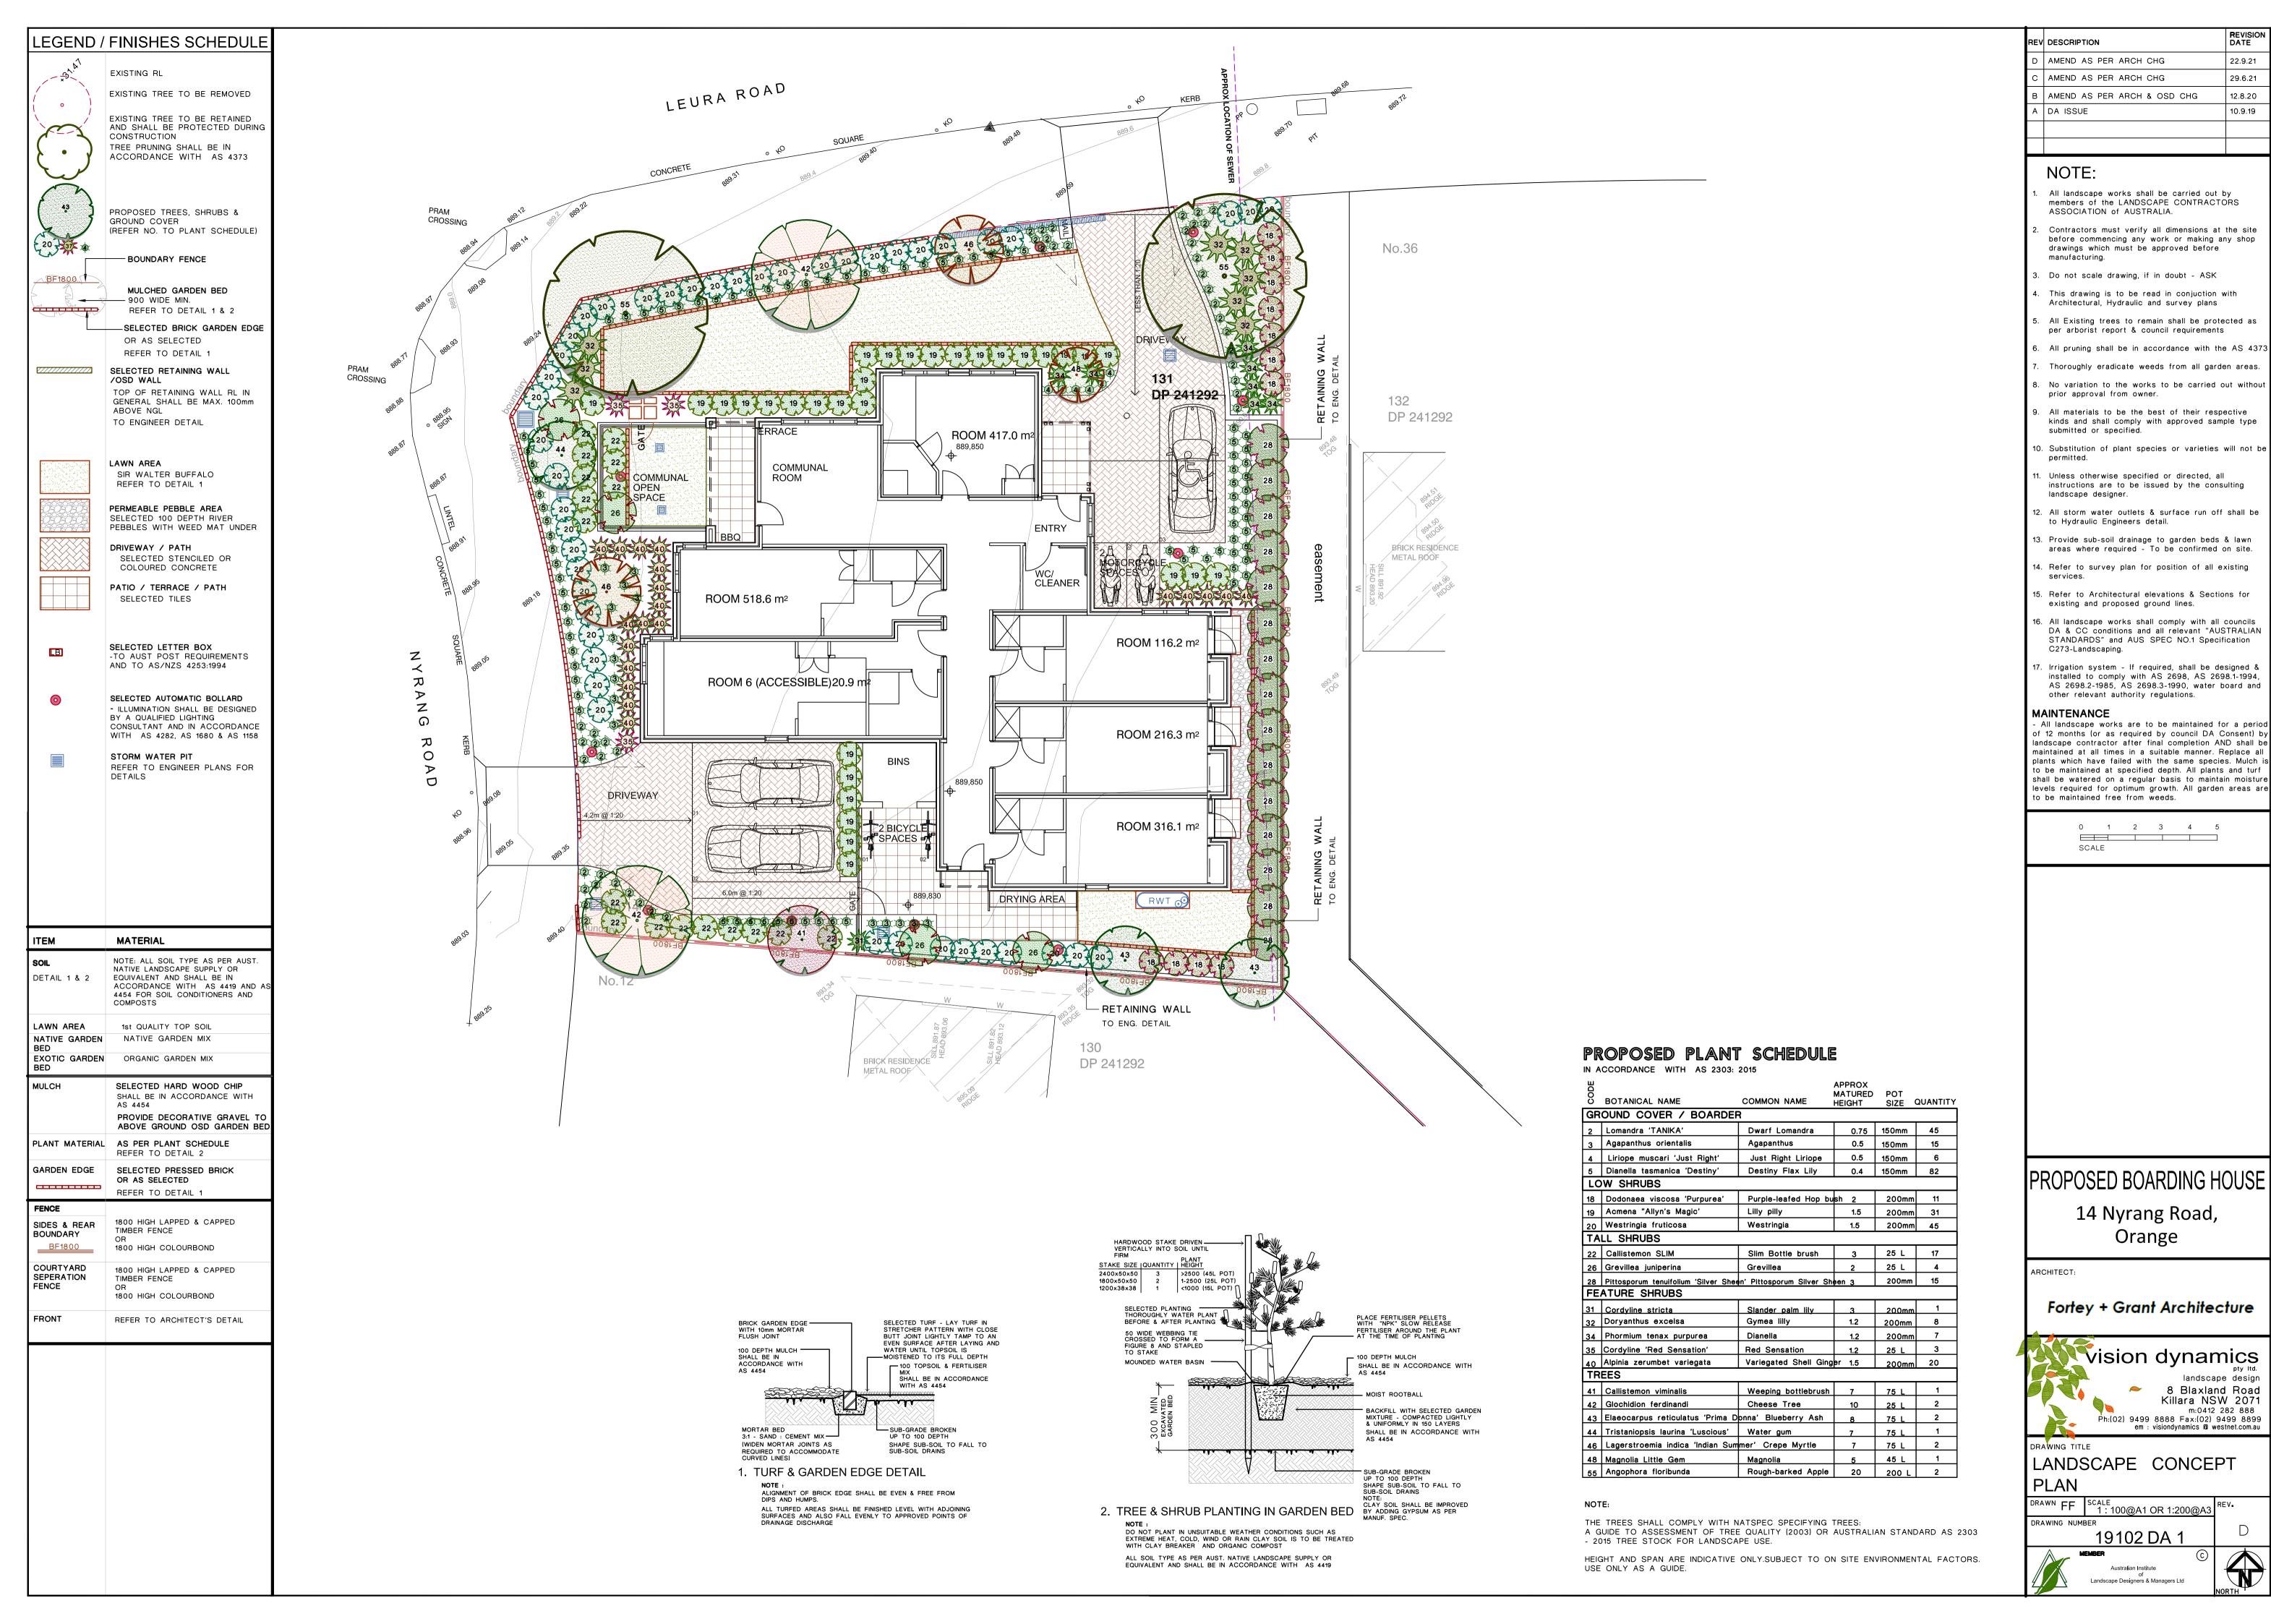

22.9.21

29.6.21

10.9.19

landscape design

8 Blaxland Road

Killara NSW 2071

# STORMWATER MANAGEMENT PLAN PROPOSED BOARDING HOUSE No.14 NYRANG ROAD, ORANGE

#### **GENERAL NOTES:**

- THESE PLANS REMAIN THE PROPERTY OF NY CIVIL ENGINEERING PTY LTD AND ARE SUBJECT TO COPYRIGH
- ALL DIMENSIONS IN MILLIMETERS UNLESS OTHERWISE STATED. ALL REDUCED LEVELS (SURFACE LEVELS, INVERT LEVELS) AND CHAINAGES ARE IN METERS UNLESS OTHERWISE STATED. DO NOT SCALE OFF THE DRAWINGS, SCALES ARE AS SHOWN, USE FIGURED DIMENSIONS
- THIS PLAN IS TO BE READ IN JUNCTION WITH LATEST ARCHITECTURAL STRUCTURAL LITHLITY AND LANDSCAPE PLANS IN ADDITION TO ANY
- ALL WORKS SHALL BE CARRIED OUT TO LOCAL COUNCIL'S DEVELOPMENT CONTROL PLAN AND SPECIFICATIONS. AS/NZS 3500.3 AND B.C.A.
- ALL LEVELS SHALL RELATE TO THE ESTABLISHED BM. PM AND/OR LM. ALL EXISTING SERVICES ARE TO BE VERIFIED FOR LOCATION AND DEPTH PRIOR TO COMMENCEMENT OF ANY WORK. CONTRACTOR TO NOIFY DESIGNER OF ANY DISCREPANCIES OF SERVICE LEVELS QUOTED ON THIS PLAN. ALL SURVEY INFORMATION, BUILDING AND FINISHED SURFACE LEVELS SHOWN IN THESE DRAWINGS ARE BASED ON LEVELS OBTAINED
- IT IS THE RESPONSIBILITY OF THE CONTRACTOR TO ORTAIN ANY PRIOR APPROVAL REQUIRED FROM COUNCIL WITH RESPECT TO POTENTIAL IMPACT ON TREES FOR ANY WORKS SHOWN ON THIS DRAWING PRIOR TO THE COMMENCEMENT OF WORKS. NO TREES SHALL BE REMOVED WITHOUT THE WRITTEN PERMISSION OF COUNCIL
- THE CONTRACTOR SHALL TAKE ALL DUE CARE TO USE THE ABSOLUTE MINIMUM AREA FOR CONSTRUCTION AND THAT NO UNDUE DAMAGE IS
- THE CONTRACTOR SHALL COMPLY WITH CONDITIONS, AND SPECIFICATION OF COUNCIL AND ALL ACTS OF THE NSW EPA.
- THE CONTRACTOR SHALL TAKE ALL REASONABLE CARE TO PROTECT EXISTING SERVICES. DAMAGED SERVICES SHALL BE REPAIRED AT THE
- ALL NEW WORK IS TO MAKE A SMOOTH JUNCTION WITH EXISTING WORK
- SUITABLE WARNING SIGNS AND BARRICADES ARE TO BE PROVIDED IN ACCORDANCE WITH THE AUSTRALIAN STANDARDS AND AS DIRECTED BY
- SERVICES SHOWN ARE INDICATIVE ONLY FROM AVAILABLE INFORMATION AND THE TIME OF SITE INVESTIGATION (IF ANY), THE BUILDER IS TO
- RESTORE ALL TRAFFIC AREAS TO PRE EXISTING CONDITION. FOR ALL SURFACES OTHER THAN IN TRAFFIC AREAS RESTORE DISTURBED
- RESTORE ALL AUTHORITY OWNED AREAS TO COUNCIL AND/OR AUTHORITY STANDARD AND SPECIFICATION.
- THE WORK AS CONSTRUCTED WORKS SHALL BE INSPECTED BY THE ENGINEER, MINIMUM 48 HOURS NOTICE SHALL BE PROVIDED FOR ALL
- THE DESIGN PLANS HEREIN ARE SUBJECT TO COUNCIL APPROVAL PRIOR TO CONSTRUCTION
- WORK AS CONSTRUCTED DRAWINGS TO BE REQUESTED AND RECEIVED IN CAD/DWG FILE TYPE AND HARD COPY 'RED LINE' MARKLIP FROM

### **ROOF STORMWATER DRAINAGE NOTES:**

- ALL ROOF GUTTERS TO HAVE OVERFLOW PROVISION IN ACCORDANCE WITH AS 3500.3 AND SECTIONS 3.5.3, 3.7.5 AND APPENDIX G OF AS 3500.3.
- ALL DOWNPIPES TO BE FITTED VERTICALLY TO THE SOLE OF EAVES GUTTERS, RAINHEAD AND/OR SUMP.
- ALL DOWNPIPES TO DRAIN INTO RAINWATER TANK AND OR PIT PRIOR TO DISCHARGE OFFSITE UNLESS PRIOR APPROVAL IS OBTAINED FROM
- ALL EAVES GUTTERS TO BE SIZED FOR ARI 20 AS PER AS 3500.3 3.5 AND APPENDIX H.
- ROOF DRAINAGE INSTALLATION TO BE IN ACCORDANCE TO AS 3500.3 SECTION 4

#### STORMWATER DRAINAGE NOTES:

- THE MINIMUM PIPE SIZE SHALL BE
- DN90 FOR ALL DOWNPIPES:
- DN100 WHERE THE LINE ONLY RECEIVES ROOF STORMWATER RUNOFF, OR;
- DN100 WHERE THE LINE RECEIVES RUNOFF FROM PAVED OR UNPAVED AREAS.

#### PIPE GRADE:

- THE MINIMUM PIPE GRADE SHALL BE:
- FOR DN100 DN150 1.00% FOR DN225 - 0.50%
- FOR DN300 0.45%

#### STANDARD COVER:

- MINIMUM PIPE COVER FOR PVC PIPES SHALL BE AS PER AS 3500.3 TABLE 6.2.5:
- NOT SUBJECT TO VEHICULAR LOADING
- WITHOUT PAVEMENT OTHER THAN SINGLE DWELLINGS 300mm
- WITH PAVEMENT (BRICK/PAVERS) AND/OR UNREINFORCED CONCRETE 100mm
- SUBJECT TO VEHICULAR LOADING:
- ROADS (LINSEALED) 750mm
- OTHER THAN ROADS (WITH PAVEMENT) 100mm
- OTHER THAN ROADS (WITHOUT PAVEMENT) 450mm

- PIPES AND FITTINGS FOR STORMWATER DRAINAGE SHALL BE AS FOLLOWS:
- FOR PIPE SIZES UP TO DN225 PVC WITH SOLVENT WELDED JOINTS (IN GROUND). FOR PIPE SIZES GREATER THAN DN225 - RCP WITH RUBBER RING JOINTS.
- FOR LARGER PIPE DEPTHS AS SPECIFIED IN AS 3500.3 RCP WITH RUBBER RING JOINTS.
- FOR PIPES AND FITTINGS FOR SUBSOIL DRAINAGE SHALL BE SLOTTED PVS WITH SOLVENT WELDED JOINTS MINIMUM DN150.
- FOR GRATED DRAINS SHALL BE MINIMUM DN150 IN NON-TRAFFICABLE ZONES AND DN225 IN TRAFFICABLE ZONES.
- LAY AND JOINT ALL PIPES IN ACCORDANCE WITH THE MANUFACTURING RECOMMENDATIONS AND
- AS 3725-1989 LOADS ON BURIED CONCRETE PIPES
- AS 2566 1988 BURIED FLEXIBLE PIPELINES
- AS 1597.2 1996 PRECAST REINFORCED CONCRETE BOX CULVERTS
- AS 3500 1990 NATIONAL PLUMBING AND DRAINAGE CODE PART 2 SANITARY PLUMBING AND SANITARY DRAINAGE SYDNEY WATER
- ALLOW TO TEST ALL PIPES AND PITS TO MANUFACTURERS REQUIREMENTS

#### CONNECTIONS TO STORMWATER SYSTEMS UNDER BUILDINGS

IN ACCORDANCE WITH AS 3500.3 SECTION 9.2

#### CONNECTIONS TO COUNCIL STORMWATER SYSTEMS:

CONNECTION TO COUNCIL STORMWATER SYSTEM TO BE IN ACCORDANCE TO LOCAL COUNCIL DCP AND STANDARDS. NO CONNECTIONS TO BE MADE UNTIL PROPER PERMIT/APPROVALS ARE OBTAINED FROM LOCAL COUNCIL IN WRITING

EXISTING SERVICES SHOWN ON THESE PLANS ARE NOT GUARANTEED COMPLETE OR CORRECT AND FURTHER INFORMATION IS REQUIRED FROM THE RELEVANT AUTHORITY AND FIELD INVESTIGATION AND ARE TO BE VERIFIED BY THE CONTRACTOR PRIOR TO CONSTRUCTION.

#### **LEGEND**

SURFACE INLET PIT GRATED TRENCH DRAIN SURFACE INLET PIT ABSORPTION TRENCH (WITH ENVIROPOD 200 MICRON) PROPOSED ROOF GUTTER FALL (WITH GROSS POLLUTANT TRAP) → (SP) PROPOSED DOWNPIPE SPREADER 450 SQUARE INTERVAL 450 X 450 STORMWATER PIPE 100mm DIA, MIN, UNO GRATE LEVEL = 75.50 SL 75.50 SUBSOIL PIPE INVERT LEVEL = RL 75.20 **EXISTING STORMWATER PIPE** PROPOSED DOWNPIPE INSPECTION RISER 90mm DIA. OR 100mm x 50mm MIN. RAINWATER HEAD NATURAL GROUND FINISHED

### STORMWATER PIT/STRUCTURES NOTES:


#### PIT SIZES AND DEPTHS:

PIT SIZES WILL BE AS FOLLOWS:

DEPTH (mm)	MIN. PIT SIZE (mm)
UP TO 450	350x350
450 - 600	450x450
600 - 900	600x600
900 - 1200	600x900
1200+	900x900 (WITH STEP IRONS)

- TRENCH DRAINS: CONTINUOUS TRENCH DRAINS ARE TO BE MIN. DN150 AND MIN. 100mm DEPTH. THE BARS OF THE GRATE ARE TO BE PARALLEL
- STEP IRONS: PITS BETWEEN 1.2m AND 6m ARE TO HAVE STEP IRONS IN ACCORDANCE WITH AS 1657, FOR PITS GREATER THAN 6m OTHER MEANS
- PLASTIC/PVC PITS: PVC PITS WILL ONLY BE PERMITTED IF THEY ARE MAX. 450x450 AND MAX. 450mm DEPTH AS WELL AS BEING HEAVY DUTY
- IN-SITU PITS: IN-SITU PITS ARE TO BE CONSTRUCTED ON A CONCRETE BED OF AT LEAST 150mm THICK. THE WALLS ARE TO BE DESIGNED TO MEET THE MINIMUM REQUIREMENTS OF CLAUSE 4.6.3 OF AS 3500.4. PITS DEEPER THAN 1.8m SHALL BE CONSTRUCTED WITH REINFORCED
- GRATES: GRATES ARE TO BE GALVANIZED STEEL GRID TYPE. GRATES ARE TO BE OF HEAVY-DUTY TYPE IN AREAS WHERE THEY MAY BE SUBJECT

- ALL PIPES INTO PITS TO BE CUT FLUSH WITH PIT WALL
- ALL PITS THAT ARE INSTALLED AT GREATER THAN 600mm DEEP TO BE MIN. 600x600 PIT
- GRATED COVERS ON PITS GREATER THAN 600mm TO BE HINGED
- OUTLET PIPE FROM ANY PIT TO BE 20mm LOWER THAN INLET PIPE/S

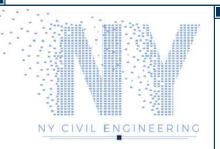

NADER ZAKI MIEAust CPEng NER

ISSUED FOR DA 22.09.2021

**DETAILS, NOTES & LEGEND** 

PROPOSED BOARDING HOUSE No.14 NYRANG ROAD **ORANGE** 


JOB REFERENCE SHEET SIZE A3 E210392 DESIGNED SR DRAWING No.

ISSUE SCALE

CHECKED

No. IN SET 6

D1

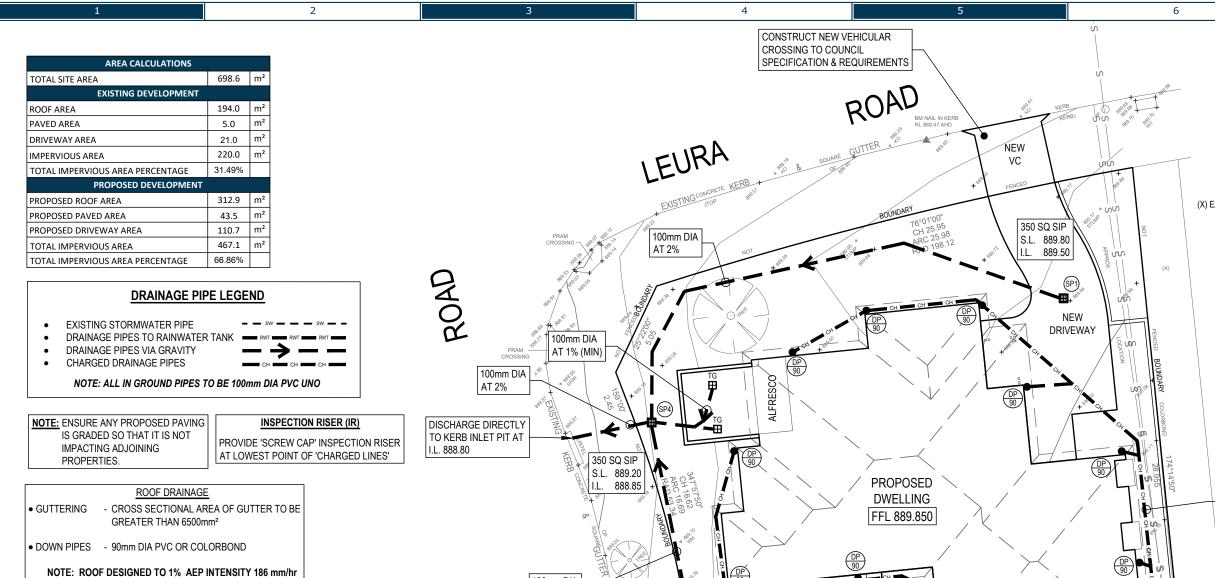


**ON-SITE DETENTION TANK - OSD** 

SIZE: 3,700 LITRES (MIN) MODLINE TANK BY "TANKWORKS" OR SIMILAR (2900L x 800W x 1785H)


INSTALL TO MANUFACTURES SPECIFICATIONS, AS3500 AND COUNCIL REQUIREMENTS

- FOR RE-USE AS SPECIFIED BY BASIX CERTIFICATE
- ENSURE TOP OF TANK IS MIN 1.0m BELOW ROOF GUTTERS TO ENSURE SUFFICIENT HEAD FOR THE SYSTEM
- TANK TO BE INSTALLED BY LICENSED PLUMBER IN ACCORDANCE WITH AS/NZS 3500:2003 AND NSW CODE OF PRACTICE PLUMBING AND DRAINAGE 2006



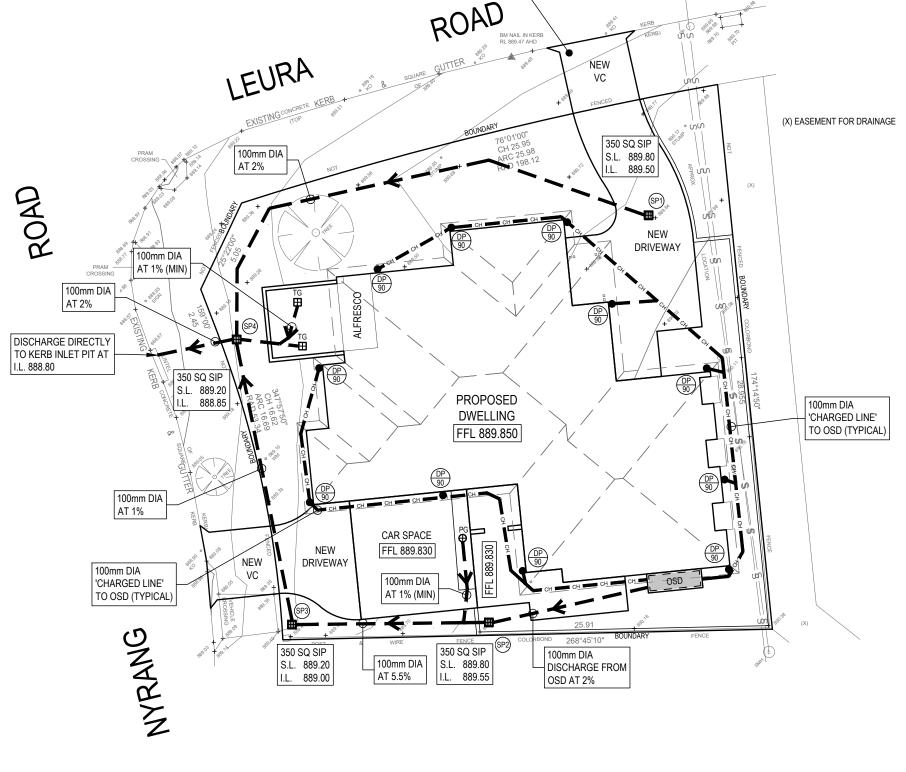

PLANS ARE FOR CONCEPT ONLY AND NOT FOR CONSTRUCTION

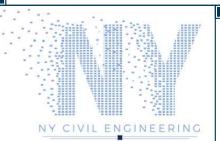

APPROVED BY	REVISION	DRAWN	DESCRIPTION	DATE	
NADER ZAKI	Α	SR	ISSUED FOR DA	22.09.2021	
MIEAust CPEng NER					
$\Lambda$ /					<u> </u>
alli					
T 0416 334 977					1
E admin@nycivilengineering.com.au					
W www.nycivilengineering.com.au					

CTORANA/ATER NAANIA CENAENIT DI ANI	SHEET SIZE
STORMWATER MANAGEMENT PLAN	DESIGNED
PROJECT TITLE	CHECKED
PROPOSED BOARDING HOUSE	
	ISSUE
No.14 NYRANG ROAD	15562

**ORANGE** 

JOB REFERENCE E210392

DRAWING No.

D2


No. IN SET

6

SR

YR

SCALE 1:200

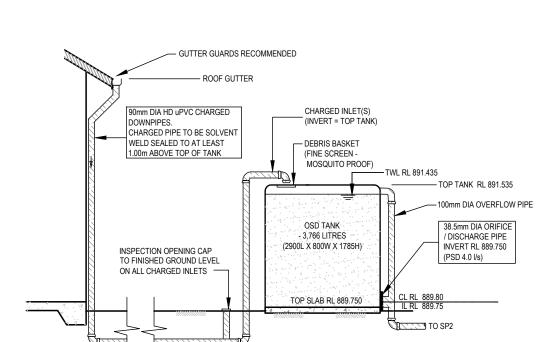

## ON-SITE DETENTION TANK

NTS

# **ORIFICE PLATE SIZE CALCULATIONS**

**Discharge Orifice Design** 

 $Q(m_3/s) = C_d A_o (2gh)^{1/2}$ 

 $C_d = 0.6$  (Assumed)

 $A_0$  = area of orifice

h = head to centre of orifice

Head to orifice centre = 1.685 m

PSD = 4.00 L/s

Area of orifice =  $0.001 \text{ m}^2$ 


Diameter of orifice = 38.4 mm diameter

Area of plate =  $0.006 \text{ m}^2$  5 times area of orifice

Each side (minimum) = 0.076 m


Dimension of Orifice Plate = 76 mm (min. Adopt 200mm x 200m square plate)



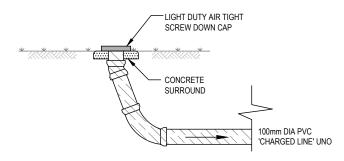

## **INSPECTION RISER - IR**

NTS

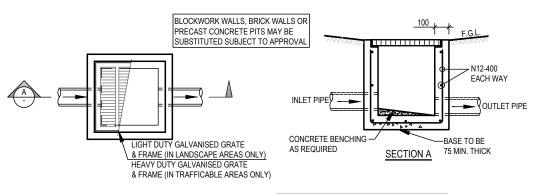

# TYPICAL PIT (SIP)

NOTE:
ALL PROPOSED SITE PITS ARE TO BE
CONSTRUCTED IN CONCRETE CAST IN SITU,
PLASTIC OR BRICK PITS ARE NOT ACCEPTABLE.
HOWEVER, 'COUNCIL MAY CONSIDER PRE-CAST
UNITS IF THE UNITS ARE PLACED ON A SOLID
BASE OF GRAVEL OR CONCRETE OF 75mm
THICK AND BACKFILL UP TO HALF THE DEPTH
OF THE PIT SURROUND WITH CONCRETE.

V. 8.1 a. s.	APPROVED BY	REVISION	DRAWN	DESCRIPTION	DATE	DRAWING TITLE	CHEET CIZE A2	JOB DEFEDENCE
	NADER ZAKI	Α	SR	ISSUED FOR DA	22.09.2021	CTODMWATED DETAILS	SHEET SIZE A3	JOB REFERENCE E210392
	MIEAust CPEng NER					STORMWATER DETAILS	DESIGNED SR	L210332
	1/_					PROJECT TITLE	0.150155 1/5	DRAWING No.
							CHECKED YR	D3
	300					PROPOSED BOARDING HOUSE	ISSUE A	
	T 0416 334 977					No.14 NYRANG ROAD	1550E A	No. IN SET
NY CIVIL ENGINEERING	E admin@nycivilengineering.com.au					ORANGE	SCALE AS NOTED	6
	W www.nycivilengineering.com.au					UKANGL	SCALL NO NOTES	

OSD SUMMARY										
STORM (AEP) 20% 1%										
PRE DEVELOPMENT PSD (L/s)	9	24								
POST DEVELOPMENT OSD DISCHARGE (L/s)	4	7								
POST DEVELOPMENT (L/s) (BYPASSING OSD)	5	14								
OSD VOLUME (m³)	1.6	3.7								
THEREFORE POST DEVELOPMENT I DEVELOPMENT RUNOFF FOR ALL S										


PIT / NOI	DE DETAILS																					
Name	Type	Family	Size	Ponding	Pressure	Surface	Max Pond	Base	Blocking	X	y	Bolt-dow	id	Part Full	Inflow	Pit is	Internal	Inflow is	Minor Sa	f Major Sa	fe	
				Volume	Change	Elev (m)	Depth (m	Inflow	Factor			lid		Shock Loss	Hydrogra	aph	Width	Misaligne	Pond De	p Pond De	pth	
				(cu.m)	Coeff. Ku			(cu.m/s)									(mm)		(m)	(m)		
N1	Node							0		29	-119	9	7		No							
N5	Node					1	l	0		47	- 291	L	15		No							
N3	Node							0		31	-457	7	10	)	No							
DETENTIO	ON BASIN D	ETAILS																				
Name	Elev	Surf. Area	Not Used	Outlet Ty	/ K	Dia(mm)	Centre RL	Pit Family	Pit Type	X	У	HED	Crest RL	Crest Lengt	id id							
Basin2	10	2.21		Orifice		50	10.05			30	-286	No				9						
	12	2.21																				
SUB-CAT	CHMENT DE	TAILS																				
Name	Pit or	Total	Paved	Grass	Supp	Paved	Grass	Supp	Paved	Grass	Supp	Paved	Grass	Supp	Paved	Grass	Supp	Lag Time	Gutter	Gutter	Gutter	Rainfall
	Node	Area	Area	Area	Area	Time	Time	Time	Length	Length	Length	Slope(%)	Slope	Slope	Rough	Rough	Rough	or Factor	Length	Slope	FlowFact	c Multipli
		(ha)	96	%	%	(min)	(min)	(min)	(m)	(m)	(m)	%	%	%					(m)	%		
Predev	N1	0.0698			9 (			_										C				
Roof to C	05Basin2	0.0312	100	(	0 (	) :	3 7	2										C				
Bypass	N3	0.0386	39	6:	1 (	) :	3 7	2										C				
OVERFLO	W ROUTE D	ETAILS																				
Name	From	To	Travel	Spill	Crest	Weir	Cross	Safe Depth	SafeDepth	Safe	Bed	D/S Area		id								
			Time	Level	Length	Coeff. C	Section	Major Storms	Minor Stom	ns DxV	Slope	Contribut	ing									
			(min)	(m)	(m)			(m)	(m)	(sq.m/se	c (%)	%										
OF1	Basin2	N5	0.1	11	2 1	1.6	Dummy u	. 0.2	0.0	0.	5 1	1 100		16	5		1	0				
PIPE COV	/ER DETAILS																					
Name	Type	Dia (mm)	Safe Cove																			
Pipe1	uPVC, not	154	0.3	-0.1	6 Unsafe																	
This mod	del has no pi	pes with r	on-return	valves																		

# **DRAINS DATA**

PIT / NODE D	ETAILS								
Name	Max HGL	Max Pond	Max Surface	Max Pond	Min	Overflow	Constrair	nt	
		HGL	Flow Arriving	Volume	Freeboard	(cu.m/s)			
			(cu.m/s)	(cu.m)	(m)				
N5	9.95		0						
SUB-CATCHN	IENT DETAI	<u>LS</u>							
Name	Max	Paved	Grassed	Paved	Grassed	Supp.	Due to St	orm	
	Flow Q	Max Q	Max Q	Tc	Tc	Tc			
	(cu.m/s)	(cu.m/s)	(cu.m/s)	(min)	(min)	(min)			
Predev	0.009	0.004	0.005	3	7	2	20% AEP,	15 min burs	t, Storm 8
Roof to OSD	0.009	0.009	0	3	7	2	20% AEP,	5 min burst,	Storm 1
Bypass	0.005	0.004	0.003	3	7	2	20% AEP,	15 min burs	t, Storm 6
PIPE DETAILS									
Name	Max Q	Max V	Max U/S	Max D/S	Due to Stor	rm			
	(cu.m/s)	(m/s)	HGL (m)	HGL (m)					
Pipe1	0.004	0.78	10.569	9.952	20% AEP, 1	5 min burs	t, Storm 7		
OVERFLOW F	ROUTE DETA	<u>VILS</u>							
Name	Max Q U/S	Max Q D/S	Safe Q	Max D	Max DxV	Max Widt	Max V	Due to Stor	m
OF1	0	0	0.256	0	0	0	(	)	
DETENTION E	BASIN DETA	ILS							
Name	Max WL	MaxVol	Max Q	Max Q	Max Q				
			Total		High Level				
Basin2	10.71	1.6	0.004		0				
Flows were s	afe in all o	verflow rou	tes						

PIT / NODE D	ETAILS								
Name	Max HGL	Max Pond	Max Surface	Max Pond	Min	Overflow	Constraint	i	
		HGL	Flow Arriving	Volume	Freeboard	(cu.m/s)			
			(cu.m/s)	(cu.m)	(m)				
N5	9.97		0						
SUB-CATCHI	MENT DETAI	LS							
Name	Max	Paved	Grassed	Paved	Grassed	Supp.	Due to Sto	rm	
	Flow Q	Max Q	Max Q	Tc	Тс	Tc			
	(cu.m/s)	(cu.m/s)	(cu.m/s)	(min)	(min)	(min)			
Predev	0.024	0.009	0.016	3	7	2	1% AEP, 10	0 min burs	t, Storm 4
Roof to OSD	0.016	0.016	0	3	7	2	1% AEP, 5	min burst,	Storm 1
Bypass	0.014	0.006	0.008	3	7	2	1% AEP, 10	0 min burs	t, Storm 4
PIPE DETAILS									
Name	Max Q	Max V	Max U/S	Max D/S	Due to Sto	orm			
	(cu.m/s)	(m/s)	HGL (m)	HGL (m)					
Pipe1	0.007	0.88	11.341	9.966	1% AEP, 1	5 min burs	t, Storm 5		
OVERFLOW	ROUTE DETA	<u>ILS</u>							
Name	Max Q U/S	Max Q D/S	Safe Q	Max D	Max DxV	Max Widt	Max V	Due to Sto	rm
OF1	0	0	7.665	0	0	0	0		
DETENTION	BASIN DETA	ILS							
Name	Max WL	MaxVol	Max Q	Max Q	Max Q				
			Total	Low Level	High Leve	l			
Basin2	11.66	3.7	0.007	0.007	0				
Flows were	safe in all ov	erflow rout	- Ac						

# DRAINS RESULTS (1% AEP)

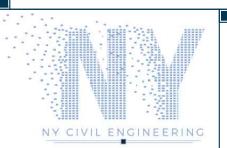

APPROVED BY	REVISION	DRAWN	DESCRIPTION	DATE	L
NADER ZAKI	Α	SR	ISSUED FOR DA	22.09.2021	Ī
MIEAust CPEng NER					
11-					Ī
alki					
T 0416 334 977 E admin@nycivilengineering.com.au					
W www.nycivilengineering.com.au					

DRAINS RESULTS	
PROJECT TITLE	
DDODOCED BOADDING HOUSE	

PROPOSED BOARDING HOUSE No.14 NYRANG ROAD ORANGE


JOB REFERENCE SHEET SIZE A3 E210392 DESIGNED SR DRAWING No.

CHECKED YR D4

ISSUE

SCALE AS NOTED


No. IN SET 6

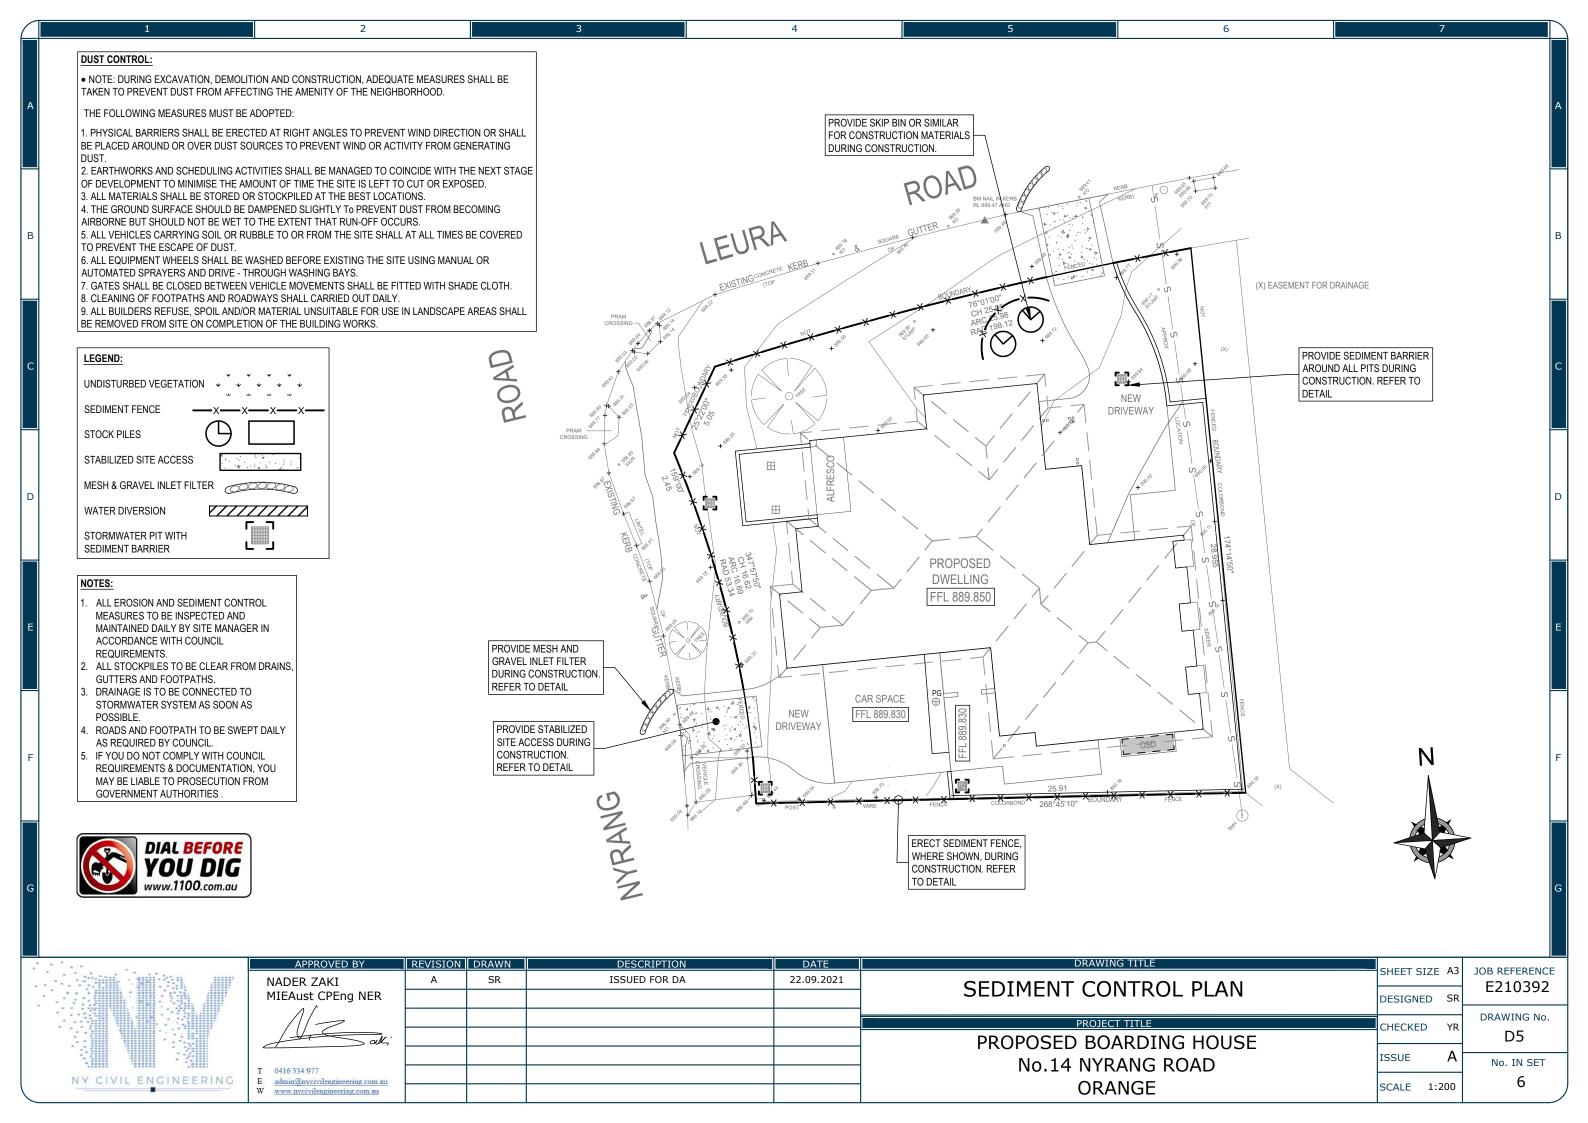


### SEDIMENT FENCE DETAIL

#### **CONSTRUCTION NOTES:**

- CONSTRUCT SEDIMENT FENCES AS CLOSE AS POSSIBLE TO BEING PARALLEL TO THE CONTOURS OF THE SITE, BUT WITH SMALL RETURNS AS SHOWN IN THE DRAWING TO LIMIT THE CATCHMENTS AREA OF ANY ONE SECTION. THE CATCHMENTS AREA SHOULD BE SMALL ENOUGH TO LIMIT WATER FLOW IF CONCENTRATED AT ONE POINT TO 50 LITRES PER SECOND IN THE DESIGN STORM EVENT, USUALLY THE 10 YEAR EVENT
- CUT A 150mm DEEP TRENCH ALONG THE UPSLOPE LINE OF THE FENCE FOR THE BOTTOM OF THE FABRIC TO BE ENTRENCHED.
- DRIVE 1.5m LONG STAR PICKETS INTO GROUND AT 2.5m INTERVALS (MAX) AT THE DOWNSLOPE EDGE OF THE TRENCH. ENSURE ANY STAR PICKETS ARE FITTED WITH SAFETY CAPS.
- FIX SELF-SUPPORTING GEOTEXTILE TO THE UPSLOPE SIDE OF THE POSTS ENSURING IT GOES TO THE BASE OF THE TRENCH. FIX THE GEOTEXTILE WITH WIRE TIES OR AS RECOMMENDED BY THE MANUFACTURER. ONLY USE GEOTEXTILE SPECIFICALLY PRODUCED FOR SEDIMENT FENCING. THE USE OF SHADE CLOTH FOR THIS PURPOSE IS NOT SATISFACTORY.
- JOIN SECTIONS OF FABRIC AT A SUPPORT POST WITH 150mm OVERLAP.
- BACKFILL THE TRENCH OVER THE BASE OF THE FABRIC AND COMPACT IT THOROUGHLY OVER THE GEOTEXTILE.

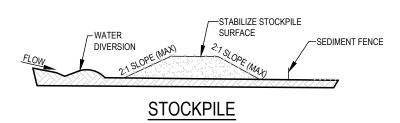


- PLACE STOCKPILES MORE THAN 2 ( PREFERABLY 5) METERS FROM EXISTING VEGETATION, CONCENTRATED WATER FLOW, ROADS AND HAZARD AREAS.
- CONSTRUCT ON THE CONTOUR AS LOW, FLAT, ELONGATED MOUNDS.
- WHERE THERE IS SUFFICIENT AREA, TOPSOIL STOCKPILES SHALL BE LESS THAN 2 METERS IN HEIGHT
- WHERE THEY ARE TO BE IN PLACE FOR MORE THAN 10 DAYS, STABILIZE FOLLOWING
- THE APPROVED ESCP OR SWMP TO REDUCE THE C-FACTOR TO LESS THAN 0.10. CONSTRUCT EARTH BANKS (LOW FLOW) ON THE UPSLOPE SIDE TO DIVERT WATER AROUND STOCKPILES AND SEDIMENT FENCES 1 TO 2 METERS ON THE DOWNSLOPE

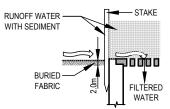

# SEDIMENT BARRIER AROUND PIT


- FABRICATE A SEDIMENT BARRIER MADE FROM GEOTEXTILE OR STRAW BALES
- FOLLOW STRAW FILTER AND SEDIMENT FENCE FOR INSTALLATION PROCEDURES FOR THE STRAW BALES OR GEOFABRIC. REDUCE THE PICKET SPACING TO 1 METRE CENTRES.
- IN WATERWAYS, ARTIFICIAL SAG POINTS CAN BE CREATED WITH SANDBAGS OR EARTH BANKS AS SHOWN IN THE DRAWING.
- DO NOT COVER THE INLET WITH GEOTEXTILE UNLESS THE DESIGN IS ADEQUATE TO ALLOW FOR ALL WATERS TO BYPASS IT

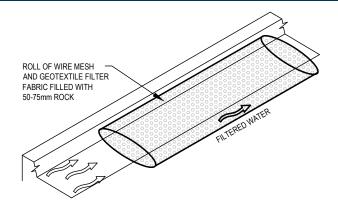

## MESH AND GRAVEL FILTER

#### CONSTRUCTION NOTES:

- INSTALL FILTERS TO KERB INLETS ONLY AT SAG POINTS
- FABRICATE A SLEEVE MADE FROM GEOTEXTILE OR WIRE MESH LONGER THAN THE LENGTH OF THE INLET PIT AND FILL IT WITH 25mm TO 50mm GRAVEL.
- FORM AN ELLIPTICAL CROSS-SECTION ABOUT 150mm(h) x 400mm(w).
- PLACE THE FILTER AT THE OPENING LEAVING AT LEAST 100mm SPACE BETWEEN IT AND THE KERB INLET. MAINTAIN THE OPENING WITH SPACER BLOCKS.
- FORM A SEAL WITH THE KERB TO PREVENT SEDIMENT BYPASSING THE FILTER
- SANDBAGS FILLED WITH GRAVEL CAN SUBSTITUTE FOR THE MESH OR GEOTEXTILE PROVIDING THEY ARE PLACED SO THAT THEY FIRMLY ABUT EACH OTHER AND SEDIMENT-LADEN WATERS CANNOT PASS BETWEEN.

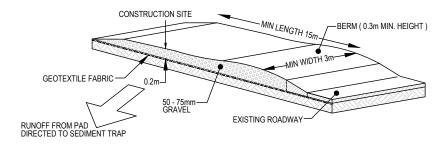

# STABILIZED SITE ACCESS

#### CONSTRUCTION NOTES:

- STRIP THE TOPSOIL, LEVEL THE SITE AND COMPACT THE SUBGRADE COVER THE AREA WITH NEEDLE-PUNCHED GEOTEXTILE CONSTRUCT A 200mm THICK PAD OVER THE GEOTEXTILE USING ROAD
- BASED OR 30mm AGGREGATE ENSURE THE STRUCTURE IS AT LEAST 15m LONG OR TO BUILD ALIGNMEN
- AND AT LEAST 3 METERS WIDE WHERE A SEDIMENT FENCE JOINS ONTO THE STABILIZED ACCESS.
- CONSTRUCT A HUMP IN THE STABILIZED ACCESS TO DIVERT WATER TO THE SEDIMENT FENCE



NADER ZAKI MIEAust CPEng NER

www.nycivilengineering.com.au

	REVISION	DRAWN	DESCRIPTION	DATE	
	Α	SR	ISSUED FOR DA	22.09.2021	
<u></u>					
227					
u					

SEDIMENT CONTROL DETAILS

PROPOSED BOARDING HOUSE No.14 NYRANG ROAD **ORANGE** 

JOB REFERENCE SHEET SIZE A3 E210392 DESIGNED SR

DRAWING No.

D6

CHECKED

ISSUE

No. IN SET 6 SCALE AS NOTED



# TRANSPORT AND TRAFFIC PLANNING ASSOCIATES

Suite 502, Level 5, 282 Victoria Avenue, Chatswood NSW 2067 **P** (02) 9411 5660 **F** (02) 9904 6622 **W** ttpa.com.au **E** ross@ttpa.com.au

1 June 2021 Ref: 335/2019

Mr Rob Hart
Director
County Construction

E: robhart@countyconstruction.com.au

Dear Mr Hart

### Proposed Boarding House 14 Nyrang Road, Orange

I have considered the "traffic and parking" issues raised in the SOF&C and set out my response in the following.

#### **Traffic Assessment**

The TfNSW Development Guidelines do not contain any traffic generation criteria for Boarding House use, however an indication of the potential traffic impact can be deduced using "first principles". The Development Guidelines specify the following for Medium Density Residential.

Parking 1 space per one bed unit

1.2 spaces per two bed unit1.7 spaces per three bed unit

Traffic 0.4-0.5 vtph per two bed unit

So, 10 two bed units with 12 cars would generate 4-5 vtph or 0.33 to 0.42 vtph per car and on this basis, the proposed 3 Boarding House cars will generate 1.0 to 1.25 vtph. The Development Guidelines specify a peak traffic generation for a single residential dwelling as 0.85 vtph and it is apparent therefore that the traffic generation of the proposed Boarding House will be very little more than that of the former single dwelling that was on the site.

. . . . . / cont'

#### **Parking Assessment**

Orange Council's DCP, unlike most Country Regional Council DCP's, does not have a parking criteria for Boarding House use. Examples of Country Regional Council DCP's with a Boarding House parking criteria are provided in the following:

Cowra 1 space per 4 beds Kiama 1 space per 4 beds Kempsey 1 per 3 rooms

Mid Coast 1 space per 2 rooms

Armidale As per SEPP

Bathurst 1 space per 3 beds

Young As per SEPP

Albury 1 space per 3 beds Inverell 1 space per 3 rooms Eurobodalla 1 space per 3 beds Bland 1 space per 3 rooms

It is apparent that the common "theme" of Regional Council's parking criteria, as with the SEPP, is in the range of 1 space per 2-3 rooms (or 1 space per 4 beds).

It would appear that Orange Council has just not "got around to" incorporating Boarding House use in its Parking DCP criteria while the Development Guidelines are entirely reliant on the SEPP requirements for parking provision. To suggest that the "RTA rates would generate a demand for 6 parking spaces" is simply incorrect as is the contention that the Boarding rooms equate to a one bed unit.

The simple fact is that Boarding House residents only have a very low car ownership characteristic and the site is located in close proximity to a regular bus service as well as easy walking distance for workers at:

- Glenroi Height Primary School
- Technology High School
- Kinross Wolaroi School
- Merryfields School
- St Marys School
- Council's Works Depot
- Bloomfield Hospital
- TAFE
- Orange Grove Homemakers Centre
- Orange South Industrial Area

#### **Driveway Assessment**

It is understood that Councils DCP requires residential developments of 3 or more units to not reverse to/from the street, and if there were 3 x three bed units, there would be a minimum of 4.5 (5) cars plus a visitor space using the driveway. Whereas in this case, there are 2 cars using one driveway and 1 car using the other driveway which reflects the same circumstances as virtually all residential dwellings.

I have not seen the letter from Essential Energy, however the normal distance criteria is 1.0m and the attached Streetview images of nearby properties in Nyrang Street and Leura Street indicate that this is the "norm" although the proposed driveway is some 2.0m from the power pole.

Yours faithfully

Ross Nettle Director

Transport and Traffic Planning Associates



Building Sustainability Index www.basix.nsw.gov.au

# Multi Dwelling

Certificate number: 1047792M\_03

This certificate confirms that the proposed development will meet the NSW government's requirements for sustainability, if it is built in accordance with the commitments set out below. Terms used in this certificate, or in the commitments, have the meaning given by the document entitled "BASIX Definitions" dated 10/09/2020 published by the Department. This document is available at www.basix.nsw.gov.au

This certificate is a revision of certificate number 1047792M\_02 lodged with the consent authority or certifier on 04 November 2020 with application DA 424/2020.

It is the responsibility of the applicant to verify with the consent authority that the original, or any revised certificate, complies with the requirements of Schedule 1 Clause 2A, 4A or 6A of the Environmental Planning and Assessment Regulation 2000

#### Secretary

**BASIX** 

Date of issue: Friday, 24 September 2021

To be valid, this certificate must be lodged within 3 months of the date of issue.



Project summary	
Project name	4270A Nyrang Orange - Rob Hart_03
Street address	14 Nyrang Road Orange 2800
Local Government Area	Orange City Council
Plan type and plan number	deposited 241292
Lot no.	131
Section no.	-
No. of residential flat buildings	1
No. of units in residential flat buildings	6
No. of multi-dwelling houses	0
No. of single dwelling houses	0
Project score	
Water	✓ 40 Target 40
Thermal Comfort	✓ Pass Target Pass
Energy	✓ 37 Target 25

Certificate Prepared by	
Name / Company Name: Lin & Associates Ptv I td	

Name / Company Name: Lin & Associates Pty Ltd

ABN (if applicable): 34097383821

Planning, Industry & Environment www.basix.nsw.gov.au Version: 3.0 / DARWINIA\_3\_18\_5 Certificate No.: 1047792M\_03 Friday, 24 September 2021 page 1/14

# **Description of project**

BASIX

Project address	
Project name	4270A Nyrang Orange - Rob Hart_03
Street address	14 Nyrang Road Orange 2800
Local Government Area	Orange City Council
Plan type and plan number	deposited 241292
Lot no.	131
Section no.	-
Project type	
No. of residential flat buildings	1
No. of units in residential flat buildings	6
No. of multi-dwelling houses	0
No. of single dwelling houses	0
Site details	
Site area (m²)	698
Roof area (m²)	348
Non-residential floor area (m²)	-
Residential car spaces	3
Non-residential car spaces	-

Common area landscape	
Common area lawn (m²)	78.0
Common area garden (m²)	145.0
Area of indigenous or low water use species (m²)	40.0
Assessor details	
Assessor number	DMN/19/1894
Certificate number	0005225690
Climate zone	65
Ceiling fan in at least one bedroom	No
Ceiling fan in at least one living room or other conditioned area	No
Project score	
Water	✓ 40 Target 40
Thermal Comfort	✓ Pass Target Pass
Energy	✓ 37 Target 25

Planning, Industry & Environment www.basix.nsw.gov.au Version: 3.0 / DARWINIA\_3\_18\_5 Certificate No.: 1047792M\_03 Friday, 24 September 2021 page 2/14

# **Description of project**

The tables below describe the dwellings and common areas within the project

## Residential flat buildings - Building1, 6 dwellings, 2 storeys above ground

Dwelling no.	No. of hedrooms	Conditioned floor area (m²)	Unconditioned floor area (m²)	Area of garden & Iawn (m²)	Indigenous species (min area m²)
1	1	21.0	3.0	2.0	0.0
6	1	31.0	6.0	0.0	0.0

BASIX

Dwelling no.	No. of hedrooms	Conditioned floor area (m²)	Unconditioned floor area (m²)	Area of garden & lawn (m²)	Indigenous species (min area m²)
2	1	21.0	3.0	1.8	0.0

Dwelling no.	No. of hedrooms	Conditioned floor area (m²)	Unconditioned floor area (m²)	Area of garden & Iawn (m²)	Indigenous species (min area m²)
3	1	21.0	3.0	1.8	0.0

Dwelling no.	No. of hedrooms	Conditioned floor area (m²)	Unconditioned floor area (m²)	Area of garden & lawn (m²)	Indigenous species (min area m²)
4	1	20.0	3.0	0.0	0.0

Dwelling no.	No. of bedrooms		Unconditioned floor area (m²)	Area of garden & lawn (m²)	Indigenous species (min area m²)
5	1	25.0	3.0	0.0	0.0

Planning, Industry & Environment www.basix.nsw.gov.au Version: 3.0 / DARWINIA\_3\_18\_5 Certificate No.: 1047792M\_03 Friday, 24 September 2021 page 3/14

# **Description of project**

BASIX

The tables below describe the dwellings and common areas within the project

## Common areas of unit building - Building1

Common area	Floor area (m²)	Common area	Floor area (m²)
Cleaner	5.0	Lobby	52.0

Planning, Industry & Environment www.basix.nsw.gov.au Version: 3.0 / DARWINIA\_3\_18\_5 Certificate No.: 1047792M\_03 Friday, 24 September 2021 page 4/14

# Schedule of BASIX commitments

- 1. Commitments for Residential flat buildings Building1
  - (a) Dwellings
    - (i) Water
    - (ii) Energy
    - (iii) Thermal Comfort
  - (b) Common areas and central systems/facilities
    - (i) Water
    - (ii) Energy
- 2. Commitments for multi-dwelling houses
- 3. Commitments for single dwelling houses
- 4. Commitments for common areas and central systems/facilities for the development (non-building specific)
  - (i) Water
  - (ii) Energy

BASIX

Planning, Industry & Environment www.basix.nsw.gov.au Version: 3.0 / DARWINIA\_3\_18\_5 Certificate No.: 1047792M\_03 Friday, 24 September 2021 page 5/14

#### **Schedule of BASIX commitments**

The commitments set out below regulate how the proposed development is to be carried out. It is a condition of any development consent granted, or complying development certificate issued, for the proposed development, that BASIX commitments be complied with.

#### 1. Commitments for Residential flat buildings - Building1

#### (a) Dwellings

BASIX

(i) Water	Show on DA plans	Show on CC/CDC plans & specs	Certifier check
(a) The applicant must comply with the commitments listed below in carrying out the development of a dwelling listed in a table below.			
(b) The applicant must plant indigenous or low water use species of vegetation throughout the area of land specified for the dwelling in the "Indigenous species" column of the table below, as private landscaping for that dwelling. (This area of indigenous vegetation is to be contained within the "Area of garden and lawn" for the dwelling specified in the "Description of Project" table).	~	~	
(c) If a rating is specified in the table below for a fixture or appliance to be installed in the dwelling, the applicant must ensure that each such fixture and appliance meets the rating specified for it.		<b>✓</b>	~
(d) The applicant must install an on demand hot water recirculation system which regulates all hot water use throughout the dwelling, where indicated for a dwelling in the "HW recirculation or diversion" column of the table below.		~	~
(e) The applicant must install:			
(aa) a hot water diversion system to all showers, kitchen sinks and all basins in the dwelling, where indicated for a dwelling in the "HW recirculation or diversion" column of the table below; and		<b>✓</b>	-
(bb) a separate diversion tank (or tanks) connected to the hot water diversion systems of at least 100 litres. The applicant must connect the hot water diversion tank to all toilets in the dwelling.		<b>✓</b>	~
(e) The applicant must not install a private swimming pool or spa for the dwelling, with a volume exceeding that specified for it in the table below.	~	~	
(f) If specified in the table, that pool or spa (or both) must have a pool cover or shading (or both).		~	
(g) The pool or spa must be located as specified in the table.	~	<b>✓</b>	
(h) The applicant must install, for the dwelling, each alternative water supply system, with the specified size, listed for that dwelling in the table below. Each system must be configured to collect run-off from the areas specified (excluding any area which supplies any other alternative water supply system), and to divert overflow as specified. Each system must be connected as specified.	~	~	~

Planning, Industry & Environment www.basix.nsw.gov.au Version: 3.0 / DARWINIA\_3\_18\_5 Certificate No.: 1047792M\_03 Friday, 24 September 2021 page 6/14

	Fixtures			Appli	ances	Individual pool			Individual spa					
Dwelling no.	All shower- heads	All toilet flushing systems	All kitchen taps	All bathroom taps	HW recirculation or diversion	All clothes washers	All dish- washers	Volume (max volume)	Pool cover	Pool location	Pool shaded	Volume (max volume)	Spa cover	Spa shaded
All dwellings	3 star (> 6 but <= 7.5 L/min)	4 star	4 star	5 star	no	3.5 star	-	-	-	-	-	-	-	-

		Alternative water source								
Dwelling no.	Alternative water supply systems	Size	Configuration	Landscape connection	Toilet connection (s)	Laundry connection	Pool top-up	Spa top-up		
None	-	-	-	-	-	-	-	-		

(ii) Energy	Show on DA plans	Show on CC/CDC plans & specs	Certifier check
(a) The applicant must comply with the commitments listed below in carrying out the development of a dwelling listed in a table below.			
(b) The applicant must install each hot water system specified for the dwelling in the table below, so that the dwelling's hot water is supplied by that system. If the table specifies a central hot water system for the dwelling, then the applicant must connect that central system to the dwelling, so that the dwelling's hot water is supplied by that central system.	~	~	~
(c) The applicant must install, in each bathroom, kitchen and laundry of the dwelling, the ventilation system specified for that room in the table below. Each such ventilation system must have the operation control specified for it in the table.		~	~
(d) The applicant must install the cooling and heating system/s specified for the dwelling under the "Living areas" and "Bedroom areas" headings of the "Cooling" and "Heating" columns in the table below, in/for at least 1 living/bedroom area of the dwelling. If no cooling or heating system is specified in the table for "Living areas" or "Bedroom areas", then no systems may be installed in any such areas. If the term "zoned" is specified beside an air conditioning system, then the system must provide for day/night zoning between living areas and bedrooms.		~	~
(e) This commitment applies to each room or area of the dwelling which is referred to in a heading to the "Artificial lighting" column of the table below (but only to the extent specified for that room or area). The applicant must ensure that the "primary type of artificial lighting" for each such room in the dwelling is fluorescent lighting or light emitting diode (LED) lighting. If the term "dedicated" is specified for a particular room or area, then the light fittings in that room or area must only be capable of being used for fluorescent lighting or light emitting diode (LED) lighting.		•	~

Planning, Industry & Environment www.basix.nsw.gov.au Version: 3.0 / DARWINIA\_3\_18\_5 Certificate No.: 1047792M\_03 Friday, 24 September 2021 page 7/14

BASIX

(ii) Energy	Show on DA plans	Show on CC/CDC plans & specs	Certifier check	
(f) This commitment applies to each room or area of the dwelling which is referred to in a heading to the "Natural lighting" column of the table below (but only to the extent specified for that room or area). The applicant must ensure that each such room or area is fitted with a window and/or skylight.	~	~	~	
(g) This commitment applies if the applicant installs a water heating system for the dwelling's pool or spa. The applicant must:				
(aa) install the system specified for the pool in the "Individual Pool" column of the table below (or alternatively must not install any system for the pool). If specified, the applicant must install a timer, to control the pool's pump; and		•		
(bb) install the system specified for the spa in the "Individual Spa" column of the table below (or alternatively must not install any system for the spa). If specified, the applicant must install a timer to control the spa's pump.		•		
(h) The applicant must install in the dwelling:				
(aa) the kitchen cook-top and oven specified for that dwelling in the "Appliances & other efficiency measures" column of the table below;		•		
(bb) each appliance for which a rating is specified for that dwelling in the "Appliances & other efficiency measures" column of the table, and ensure that the appliance has that minimum rating; and		•	-	
(cc) any clothes drying line specified for the dwelling in the "Appliances & other efficiency measures" column of the table.		•		
(i) If specified in the table, the applicant must carry out the development so that each refrigerator space in the dwelling is "well ventilated".		~		

	Hot water	Bathroom ven	tilation system	Kitchen venti	lation system	Laundry ventilation system		
Dwelling no.	Hot water system	Each bathroom	Operation control	Each kitchen	Operation control	Each laundry	Operation control	
All dwellings	central hot water system 1	individual fan, ducted to façade or roof	manual switch on/off	individual fan, ducted to façade or roof	manual switch on/off	natural ventilation only, or no laundry	-	

	Coo	ling	Hea	ting	Artificial lighting						Natural lighting	
Dwellinç no.	living areas	bedroom areas	living areas	bedroom areas	No. of bedrooms &/or study	No. of living &/or dining rooms	Each kitchen	All bathrooms/ toilets	Each Iaundry	All hallways	No. of bathrooms &/or toilets	Main kitchen
All dwellings	-	-	-	-	1	1	no	no	no	no	0	no

BASIX

Planning, Industry & Environment www.basix.nsw.gov.au Version: 3.0 / DARWINIA\_3\_18\_5 Certificate No.: 1047792M\_03 Friday, 24 September 2021 page 8/14

	Individual p	ool	Individual s	ра			Appliances & other efficiency measures					
Dwelling no.	Pool heating system	Timer	Spa heating system	Timer	Kitchen cooktop/oven	Refrigerator	Well ventilated fridge space	Dishwasher	Clothes washer	Clothes dryer	Indoor or sheltered clothes drying line	Private outdoor or unsheltered clothes drying line
All dwellings	-	-	-	-	gas cooktop & electric oven	2.5 star	no	-	3 star	-	no	no

iii) Thermal Comfort	Show on DA plans	Show on CC/CDC plans & specs	Certifier check
(a) The applicant must attach the certificate referred to under "Assessor details" on the front page of this BASIX certificate (the "Assessor Certificate") to the development application and construction certificate application for the proposed development (or, if the applicant is applying for a complying development certificate for the proposed development, to that application). The applicant must also attach the Assessor Certificate to the application for a final occupation certificate for the proposed development.			
(b) The Assessor Certificate must have been issued by an Accredited Assessor in accordance with the Thermal Comfort Protocol.			
(c) The details of the proposed development on the Assessor Certificate must be consistent with the details shown in this BASIX Certificate, including the details shown in the "Thermal Loads" table below.			
(d) The applicant must show on the plans accompanying the development application for the proposed development, all matters which the Thermal Comfort Protocol requires to be shown on those plans. Those plans must bear a stamp of endorsement from the Accredited Assessor, to certify that this is the case.	~		
(e) The applicant must show on the plans accompanying the application for a construction certificate (or complying development certificate, if applicable), all thermal performance specifications set out in the Assessor Certificate, and all aspects of the proposed development which were used to calculate those specifications.		~	
(f) The applicant must construct the development in accordance with all thermal performance specifications set out in the Assessor Certificate, and in accordance with those aspects of the development application or application for a complying development certificate which were used to calculate those specifications.		~	~
(g) Where there is an in-slab heating or cooling system, the applicant must:	~	~	V
(aa) Install insulation with an R-value of not less than 1.0 around the vertical edges of the perimeter of the slab; or			
(bb) On a suspended floor, install insulation with an R-value of not less than 1.0 underneath the slab and around the vertical edges of the perimeter of the slab.			
(h) The applicant must construct the floors and walls of the development in accordance with the specifications listed in the table below.	V	~	~

BASIX Planning, Industry & Environment www.basix.nsw.gov.au Version: 3.0 / DARWINIA\_3\_18\_5 Certificate No.: 1047792M\_03 Friday, 24 September 2021 page 9/14

Thermal loads							
Dwelling no.	Area adjusted heating load (in mJ/m²/yr)	Area adjusted cooling load (in mJ/m²/yr)					
1	249.2	9.2					
2	185.7	9.5					
3	273.5	10.0					
4	244.0	7.0					
5	268,2	3.1					
All other dwellings	264.6	2.8					

Planning, Industry & Environment www.basix.nsw.gov.au Version: 3.0 / DARWINIA\_3\_18\_5 Certificate No.: 1047792M\_03 Friday, 24 September 2021 page 10/14

BASIX

#### (b) Common areas and central systems/facilities

BASIX

(i) Water	Show on DA plans	Show on CC/CDC plans & specs	Certifier check
(a) If, in carrying out the development, the applicant installs a showerhead, toilet, tap or clothes washer into a common area, then that item must meet the specifications listed for it in the table.		~	V
(b) The applicant must install (or ensure that the development is serviced by) the alternative water supply system(s) specified in the "Central systems" column of the table below. In each case, the system must be sized, be configured, and be connected, as specified in the table.	~	~	~
(c) A swimming pool or spa listed in the table must not have a volume (in kLs) greater than that specified for the pool or spa in the table.	~	~	
(d) A pool or spa listed in the table must have a cover or shading if specified for the pool or spa in the table.		~	
(e) The applicant must install each fire sprinkler system listed in the table so that the system is configured as specified in the table.		~	~
(f) The applicant must ensure that the central cooling system for a cooling tower is configured as specified in the table.		~	V

Common area	Showerheads rating	Toilets rating	Taps rating	Clothes washers rating
All common areas	no common facility	4 star	4 star	no common laundry facility

(ii) Energy	Show on DA plans	Show on CC/CDC plans & specs	Certifier check
(a) If, in carrying out the development, the applicant installs a ventilation system to service a common area specified in the table below, then that ventilation system must be of the type specified for that common area, and must meet the efficiency measure specified.		~	~
(b) In carrying out the development, the applicant must install, as the "primary type of artificial lighting" for each common area specified in the table below, the lighting specified for that common area. This lighting must meet the efficiency measure specified. The applicant must also install a centralised lighting control system or Building Management System (BMS) for the common area, where specified.		~	~
(c) The applicant must install the systems and fixtures specified in the "Central energy systems" column of the table below. In each case, the system or fixture must be of the type, and meet the specifications, listed for it in the table.	~	~	~

Planning, Industry & Environment www.basix.nsw.gov.au Version: 3.0 / DARWINIA\_3\_18\_5 Certificate No.: 1047792M\_03 Friday, 24 September 2021 page 11/14

	Common area ventilation system		Common area lighting		
Common area	Ventilation system type	Ventilation efficiency measure	Primary type of artificial lighting	Lighting efficiency measure	Lighting control system/BMS
Cleaner	ventilation exhaust only	interlocked to light	fluorescent	manual on / manual off	No
Lobby	no mechanical ventilation	-	fluorescent	time clock and motion sensors	No

Central energy systems	Туре	Specification
Central hot water system (No. 1)	solar - electric boosted	Solar collector area (minimum, in square metres): 15.0 Piping insulation (ringmain & supply risers): (b) Piping internal to building: R0.45 (~20 mm)

Planning, Industry & Environment www.basix.nsw.gov.au Version: 3.0 / DARWINIA\_3\_18\_5 Certificate No.: 1047792M\_03 Friday, 24 September 2021 page 12/14

BASIX

#### 4. Commitments for common areas and central systems/facilities for the development (non-building specific)

#### (b) Common areas and central systems/facilities

BASIX

(i) Water	Show on DA plans	Show on CC/CDC plans & specs	Certifier check
(a) If, in carrying out the development, the applicant installs a showerhead, toilet, tap or clothes washer into a common area, then that item must meet the specifications listed for it in the table.		<b>~</b>	~
(b) The applicant must install (or ensure that the development is serviced by) the alternative water supply system(s) specified in the "Central systems" column of the table below. In each case, the system must be sized, be configured, and be connected, as specified in the table.	~	~	~
(c) A swimming pool or spa listed in the table must not have a volume (in kLs) greater than that specified for the pool or spa in the table.	~	<b>~</b>	
(d) A pool or spa listed in the table must have a cover or shading if specified for the pool or spa in the table.		<b>~</b>	
(e) The applicant must install each fire sprinkler system listed in the table so that the system is configured as specified in the table.		~	~
(f) The applicant must ensure that the central cooling system for a cooling tower is configured as specified in the table.		<b>~</b>	~

Common area	Showerheads rating	Toilets rating	Taps rating	Clothes washers rating
All common areas	no common facility	4 star	4 star	no common laundry facility

(ii) Energy	Show on DA plans	Show on CC/CDC plans & specs	Certifier check
(a) If, in carrying out the development, the applicant installs a ventilation system to service a common area specified in the table below, then that ventilation system must be of the type specified for that common area, and must meet the efficiency measure specified.		~	~
(b) In carrying out the development, the applicant must install, as the "primary type of artificial lighting" for each common area specified in the table below, the lighting specified for that common area. This lighting must meet the efficiency measure specified. The applicant must also install a centralised lighting control system or Building Management System (BMS) for the common area, where specified.		~	~
(c) The applicant must install the systems and fixtures specified in the "Central energy systems" column of the table below. In each case, the system or fixture must be of the type, and meet the specifications, listed for it in the table.	~	~	-

Planning, Industry & Environment www.basix.nsw.gov.au Version: 3.0 / DARWINIA\_3\_18\_5 Certificate No.: 1047792M\_03 Friday, 24 September 2021 page 13/14

#### **Notes**

- 1. In these commitments, "applicant" means the person carrying out the development.
- 2. The applicant must identify each dwelling, building and common area listed in this certificate, on the plans accompanying any development application, and on the plans and specifications accompanying the application for a construction certificate / complying development certificate, for the proposed development, using the same identifying letter or reference as is given to that dwelling, building or common area in this certificate.
- 3. This note applies if the proposed development involves the erection of a building for both residential and non-residential purposes (or the change of use of a building for both residential and non-residential purposes). Commitments in this certificate which are specified to apply to a "common area" of a building or the development, apply only to that part of the building or development to be used for residential purposes.
- 4. If this certificate lists a central system as a commitment for a dwelling or building, and that system will also service any other dwelling or building within the development, then that system need only be installed once (even if it is separately listed as a commitment for that other dwelling or building).
- 5. If a star or other rating is specified in a commitment, this is a minimum rating.
- 6. All alternative water systems to be installed under these commitments (if any), must be installed in accordance with the requirements of all applicable regulatory authorities. NOTE: NSW Health does not recommend that stormwater, recycled water or private dam water be used to irrigate edible plants which are consumed raw, or that rainwater be used for human consumption in areas with potable water supply.

#### Legend

**BASIX** 

- 1. Commitments identified with a " in the "Show on DA plans" column must be shown on the plans accompanying the development application for the proposed development (if a development application is to be lodged for the proposed development).
- 2. Commitments identified with a " in the "Show on CC/CDC plans and specs" column must be shown in the plans and specifications accompanying the application for a construction certificate / complying development certificate for the proposed development.
- 3. Commitments identified with a " in the "Certifier check" column must be certified by a certifying authority as having been fulfilled. (Note: a certifying authority must not issue an occupation certificate (either interim or final) for a building listed in this certificate, or for any part of such a building, unless it is satisfied that each of the commitments whose fulfillment it is required to monitor in relation to the building or part, has been fulfilled).

Planning, Industry & Environment www.basix.nsw.gov.au Version: 3.0 / DARWINIA\_3\_18\_5 Certificate No.: 1047792M\_03 Friday, 24 September 2021 page 14/14

# Nationwide House Energy Rating Scheme\* — Class 2 summary





#### **Assessor details**

Accreditation

number: VIC/BDAV/19/1894

Name: Ailin Zhang

Organisation: Victor Lin Associates Pty Ltd Email: ailin@linassociates.com.au

Phone: **1800884199** 

Declaration None

of interest:

Software: **BERS Pro v4.3.0.2f (3.13)** 

AAO: Design Matters National


### **Dwelling details**

Street: 14 Nyrang Road

Suburb: Orange
State: NSW
Postcode: 2800


Scan to access this certificate online and confirm this is valid.



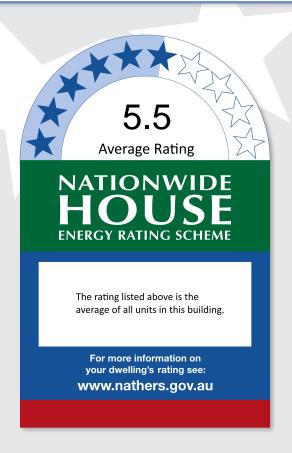


# Summary of all dwellings

Certificate Details					
Certificate number	Unit number	Heating load	Cooling load	Total load	Star Rating
0006500631-04	Room 1	249.2	9.2	258.4	5.4
0006501514-03	Room 2	185.7	9.5	195.2	6.4
0006501506-02	Room 3	273.5	10.0	283.5	5
0006501498-02	Room 4	244.0	7.0	251.0	5.4
0006501480-02	Room 5	268.2	3.1	271.2	5.2
0006501472-03	Room 6	264.6	2.8	267.5	5.3
0000501472-05	KUUIII 0	204.0	2.0	207.3	5.5

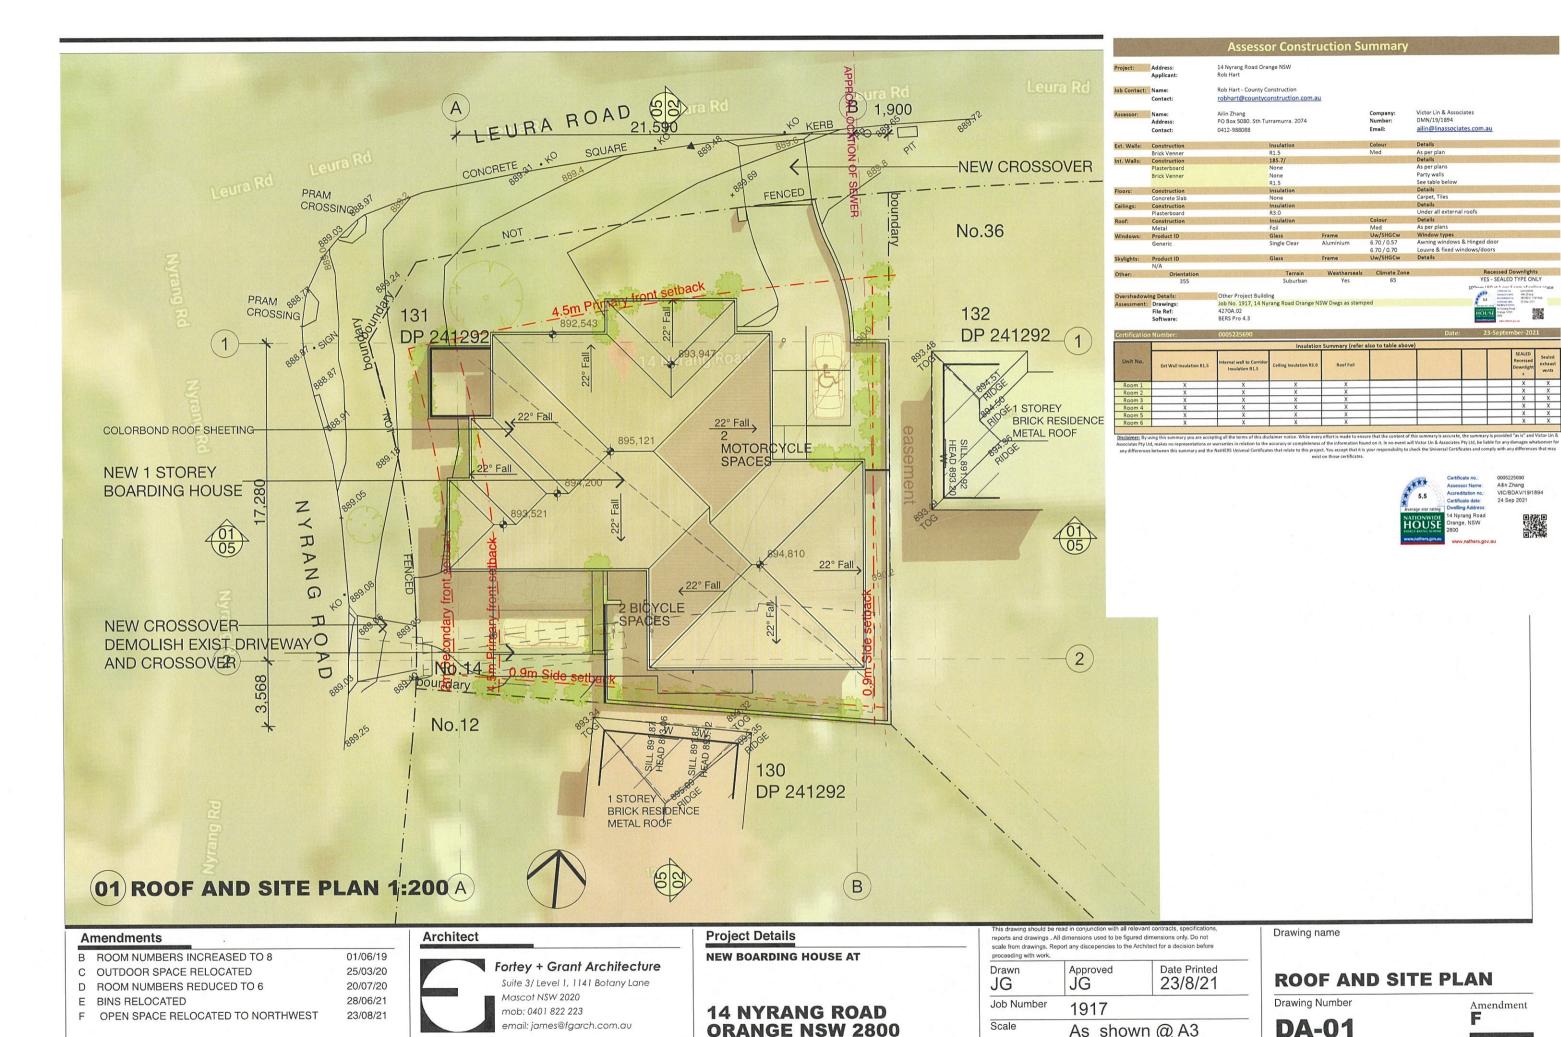

**ORANGE NSW 2800** 

As shown @ A3

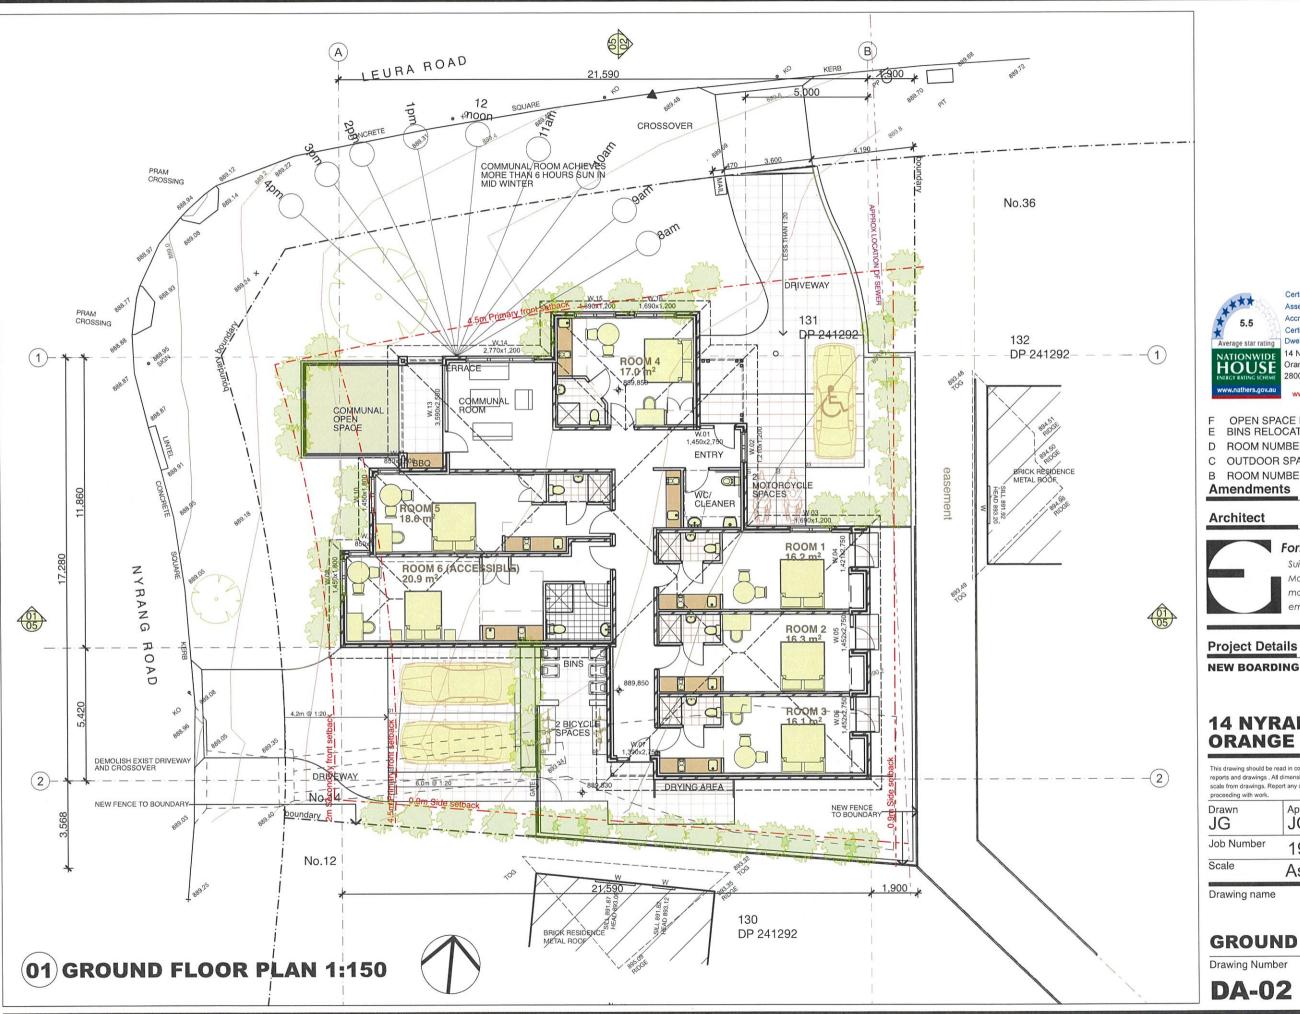



Certificate no.: Assessor Name: Accreditation no Certificate date: **Dwelling Address** 

0005225690 Ailin Zhang VIC/BDAV/19/1894 24 Sep 2021

14 Nyrang Road Orange, NSW

OPEN SPACE RELOCATED TO NORTH 18/05/09/21 E BINS RELOCATED

D ROOM NUMBERS REDUCED TO 6 20/07/20

25/03/20 C OUTDOOR SPACE RELOCATED B ROOM NUMBERS INCREASED TO 8 01/06/19

#### Amendments

#### **Architect**



#### Fortey + Grant Architecture

Suite 3/ Level 1, 1141 Botany Lane Mascot NSW 2020 mob: 0401 822 223 email: james@fgarch.com.au

**NEW BOARDING HOUSE AT** 

### **14 NYRANG ROAD ORANGE NSW 2800**

This drawing should be read in conjunction with all relevant contracts, specifications reports and drawings. All dimensions used to be figured dimensions only. Do not scale from drawings. Report any discepencies to the Architect for a decision before proceeding with work.

Date Printed 23/8/21 Drawn JG JG Job Number 1917 Scale As shown @ A3


Drawing name

### **GROUND FLOOR PLAN**

Drawing Number

**DA-02** 



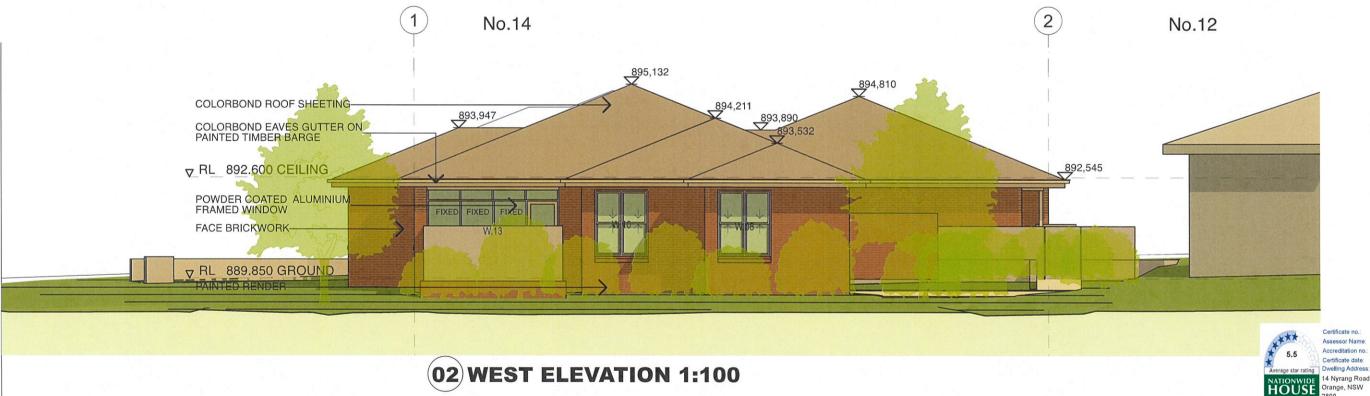



 B
 ROOM NUMBERS INCREASED TO 8
 01/06/19

 C
 OUTDOOR SPACE RELOCATED
 25/03/20

 D
 ROOM NUMBERS REDUCED TO 6
 20/07/20

 E
 BINS RELOCATED
 28/06/21

BINS RELOCATED 28/06/21

OPEN SPACE RELOCATED TO NORTHWEST 23/08/21

#### **Architect**



Project Details

**NEW BOARDING HOUSE AT** 

14 NYRANG ROAD ORANGE NSW 2800 This drawing should be read in conjunction with all relevant contracts, specifications reports and drawings. All dimensions used to be figured dimensions only, Do not scale from drawings. Report any discepencies to the Architect for a decision before proceeding with work.

Drawn Approved Date Printed 23/8/21

Job Number 1917

Scale As shown @ A3

Drawing name

# NORTH AND WEST ELEVATIONS

**Drawing Number** 

**DA-03** 

Amendment

Ailin Zhang VIC/BDAV/19/1894

24 Sep 2021







Dwelling Address: 14 Nyrang Road Orange, NSW 2800

Ailin Zhang VIC/BDAV/19/1894 24 Sep 2021

#### Amendments

B ROOM NUMBERS INCREASED TO 8 01/06/19 C OUTDOOR SPACE RELOCATED 25/03/20 D ROOM NUMBERS REDUCED TO 6 20/07/20 E BINS RELOCATED 28/06/21 OPEN SPACE RELOCATED TO NORTHWEST 23/08/21

▼ RL 889.850 GROUND

**Architect** 

Fortey + Grant Architecture Suite 3/ Level 1, 1141 Botany Lane Mascot NSW 2020 mob: 0401 822 223 email: james@fgarch.com.au

#### **Project Details**

**NEW BOARDING HOUSE AT** 

**14 NYRANG ROAD ORANGE NSW 2800** 

# This drawing should be read in conjunction with all relevant contracts, specification reports and drawings. All dimensions used to be figured dimensions only. Do not scale from drawings. Report any discepencies to the Architect for a decision before proceeding with work.

Approved Date Printed 23/8/21 JG JG Job Number 1917

As shown @ A3


Scale

Drawing Number

Drawing name

**EAST AND SOUTH ELEVATIONS** 

**DA-04** 

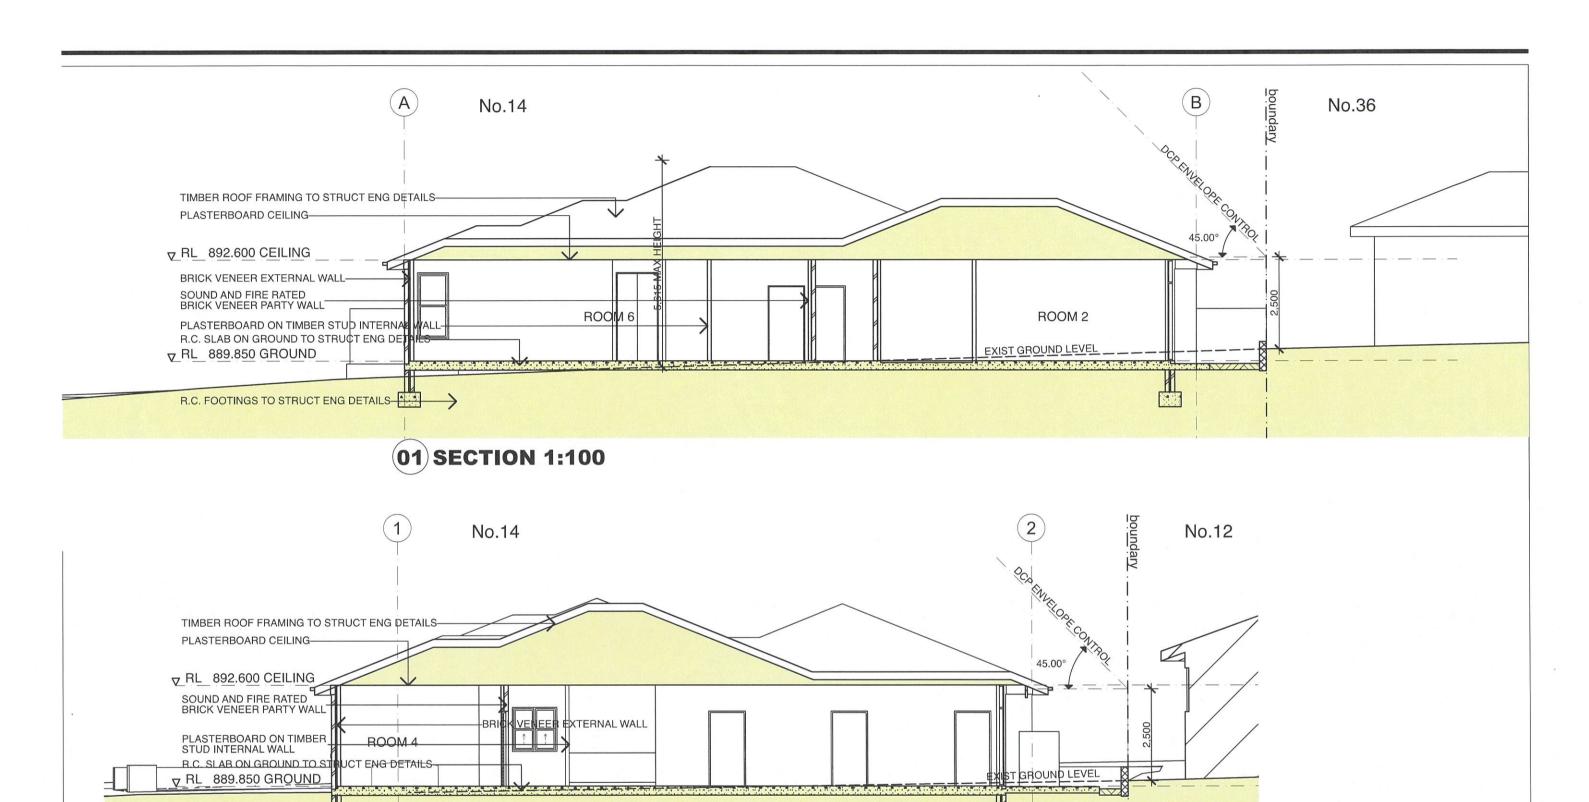

**(02) SECTION 1:100** 



Assessor Name: Accreditation no.: Certificate date: 4 Nyrang Road Orange, NSW

0005225690 Ailin Zhang VIC/BDAV/19/1894 24 Sep 2021



#### Amendments

ROOM NUMBERS INCREASED TO 8 01/06/19 C OUTDOOR SPACE RELOCATED 25/03/20 20/07/20 D ROOM NUMBERS REDUCED TO 6 28/06/21 E BINS RELOCATED OPEN SPACE RELOCATED TO NORTHWEST 23/08/21

R.C. FOOTINGS TO STRUCT ENG DETAILS

Architect

Fortey + Grant Architecture Suite 3/ Level 1, 1141 Botany Lane Mascot NSW 2020 mob: 0401 822 223 email: james@fgarch.com.au

#### **Project Details**

**NEW BOARDING HOUSE AT** 

**14 NYRANG ROAD ORANGE NSW 2800** 

reports and drawings . All dimensions used to be figured dimensions only. Do not scale from drawings. Report any discepencies to the Architect for a decision before

Date Printed Drawn Approved JG JG 23/8/21 Job Number 1917 Scale

As shown @ A3

Drawing name

### **SECTIONS**

Drawing Number


**DA-05** 

Amendment **F** 



(01) MATERIALS VIEW

2-**GUTTERS AND WINDOW FRAMES** COLOURBOND SURFMIST

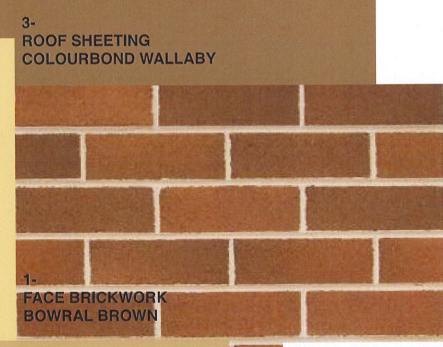

PAINTED TIMBER **DULUX MILTON MOON** 



Ailin Zhang VIC/BDAV/19/1894 24 Sep 2021 Certificate date: Dwelling Address 14 Nyrang Road Orange, NSW 2800



#### Amendments

B ROOM NUMBERS INCREASED TO 8 01/06/19 C OUTDOOR SPACE RELOCATED 25/03/20 D ROOM NUMBERS REDUCED TO 6 20/07/20

E BINS RELOCATED

F OPEN SPACE RELOCATED TO NORTHWEST

Architect

28/06/21

23/08/21

Fortey + Grant Architecture Suite 3/ Level 1, 1141 Botany Lane Mascot NSW 2020 mob: 0401 822 223 email: james@fgarch.com.au

**Project Details** 

**NEW BOARDING HOUSE AT** 

**14 NYRANG ROAD ORANGE NSW 2800**  reports and drawings. All dimensions used to be figured dimensions only. Do not scale from drawings. Report any discepencies to the Architect for a decision before


Date Printed 23/8/21 Drawn Approved JG JG Job Number

1917 Scale As shown @ A3 Drawing name

# **MATERIALS AND FINISHES**

Drawing Number

**DA-06** 

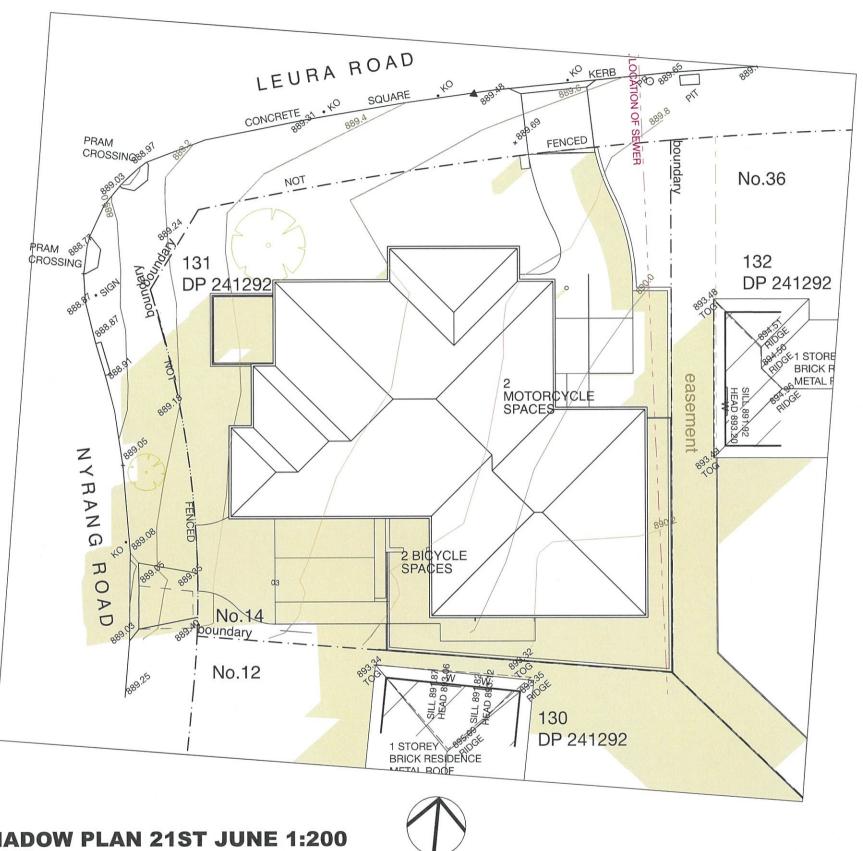

3 PM 9 AM **12 NOON** 



Ailin Zhang VIC/BDAV/19/1894 24 Sep 2021



# **(02) SHADOW PLAN 21ST JUNE 1:200**

28/06/21

23/08/21

Amendments B ROOM NUMBERS INCREASED TO 8 01/06/19 25/03/20 C OUTDOOR SPACE RELOCATED 20/07/20 D ROOM NUMBERS REDUCED TO 6

E BINS RELOCATED

F OPEN SPACE RELOCATED TO NORTHWEST

**Architect** 

Fortey + Grant Architecture Suite 3/ Level 1, 1141 Botany Lane Mascot NSW 2020 mob: 0401 822 223 email: james@fgarch.com.au

#### **Project Details**

**NEW BOARDING HOUSE AT** 

**14 NYRANG ROAD ORANGE NSW 2800** 

# reports and drawings. All dimensions used to be figured dimensions only. Do not scale from drawings. Report any discepencies to the Architect for a decision before

Drawn <b>JG</b>	Approved <b>JG</b>	Date Printed 23/8/21	
Job Number	1917		
Scale	As show	vn @ A3	


### Drawing name

## **SHADOW DIAGRAM JUNE 21ST 9 AM**

Drawing Number

**DA-07** 



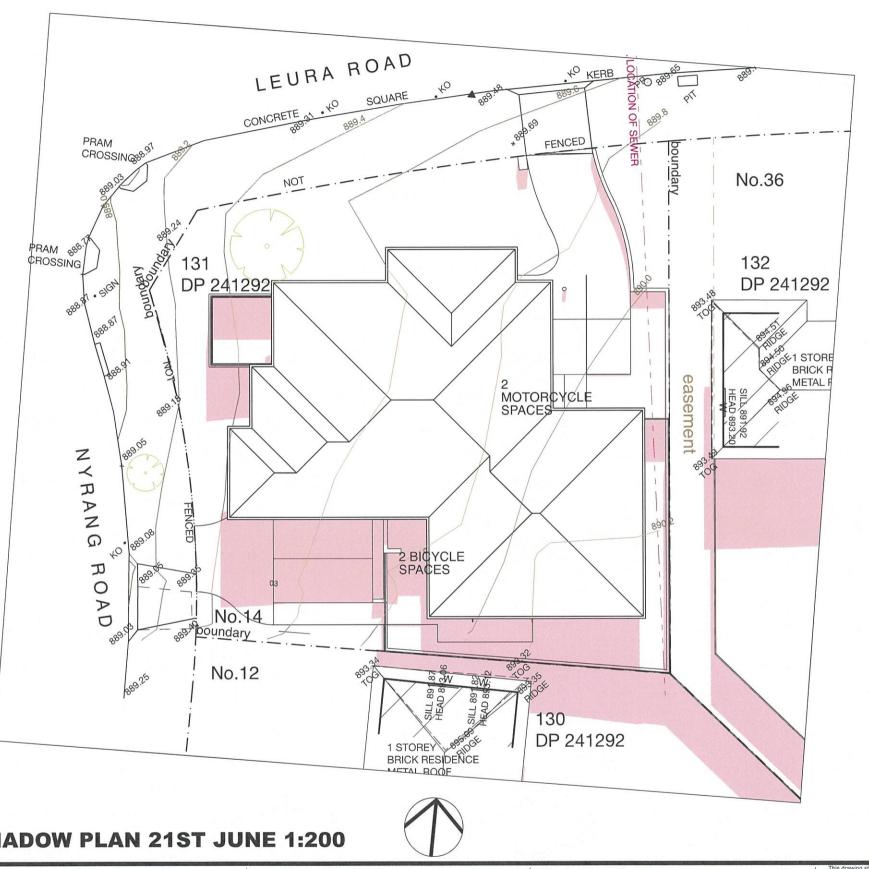

9 AM **3 PM 12 NOON** 



0005225690 Ailin Zhang VIC/BDAV/19/1894 24 Sep 2021



(02) SHADOW PLAN 21ST JUNE 1:200

01/06/19

25/03/20

20/07/20

28/06/21

23/08/21

Amendments

B ROOM NUMBERS INCREASED TO 8

C OUTDOOR SPACE RELOCATED D ROOM NUMBERS REDUCED TO 6

E BINS RELOCATED

F OPEN SPACE RELOCATED TO NORTHWEST

**Architect** 



**Project Details** 

**NEW BOARDING HOUSE AT** 

**14 NYRANG ROAD ORANGE NSW 2800**  This drawing should be read in conjunction with all relevant contracts, specifications reports and drawings. All dimensions used to be figured dimensions only. Do not scale from drawings. Report any discepencies to the Architect for a decision before

Scale

Date Printed 23/8/21 Drawn Approved JG JG Job Number 1917


As shown @ A3

Drawing name

**SHADOW DIAGRAM JUNE 21ST 12 NOON** 

Drawing Number

**DA-08** 

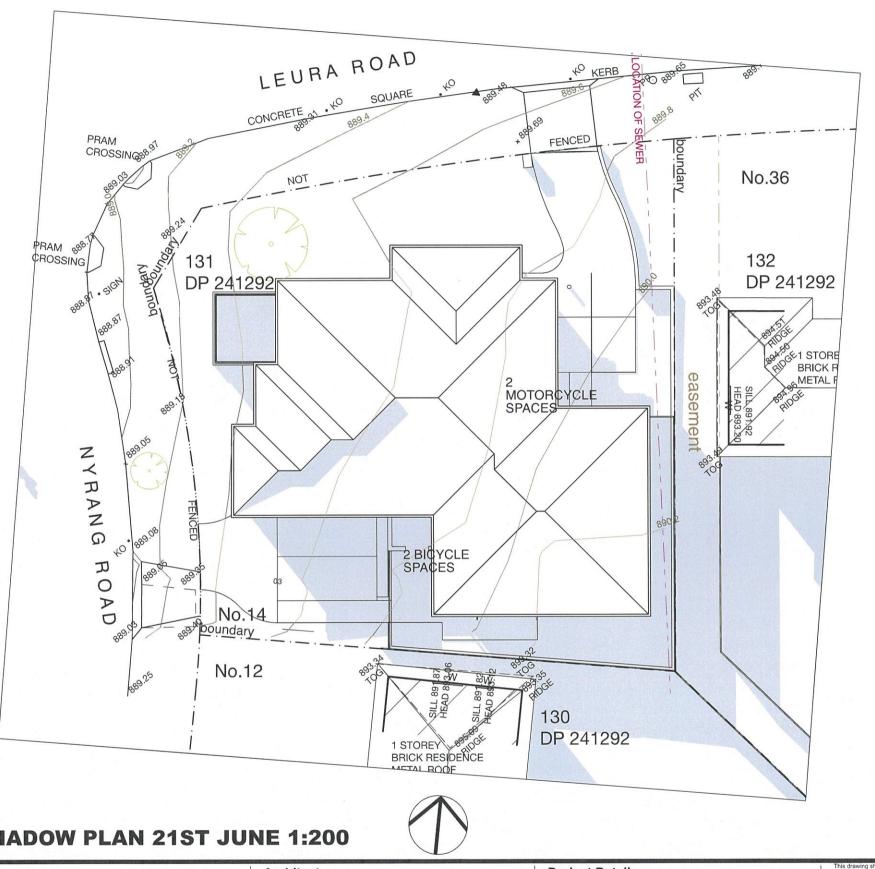

**3 PM** 9 AM **12 NOON** 



Certificate date: Dwelling Address 14 Nyrang Road Orange, NSW

Ailin Zhang VIC/BDAV/19/1894

# (02) SHADOW PLAN 21ST JUNE 1:200

01/06/19

25/03/20

20/07/20

28/06/21

23/08/21

Amendments

ROOM NUMBERS INCREASED TO 8 C OUTDOOR SPACE RELOCATED

D ROOM NUMBERS REDUCED TO 6

E BINS RELOCATED

F OPEN SPACE RELOCATED TO NORTHWEST

**Architect** 



#### **Project Details**

**NEW BOARDING HOUSE AT** 

**14 NYRANG ROAD ORANGE NSW 2800** 

# This drawing should be read in conjunction with all relevant contracts, specifications reports and drawings. All dimensions used to be figured dimensions only. Do not scale from drawings. Report any discepencies to the Architect for a decision before


Date Printed 23/8/21 Drawn Approved JG JG Job Number 1917

Scale As shown @ A3 Drawing name


# **SHADOW DIAGRAM JUNE** 21ST 3 PM

Drawing Number


**DA-09** 

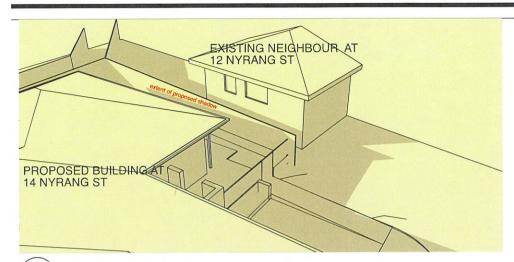

# (01) VIEW JUNE 21ST 9 AM

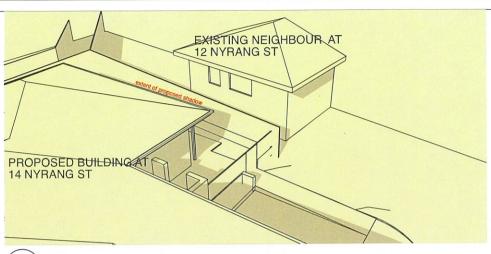


# (05) **VIEW JUNE 21ST 1 PM**

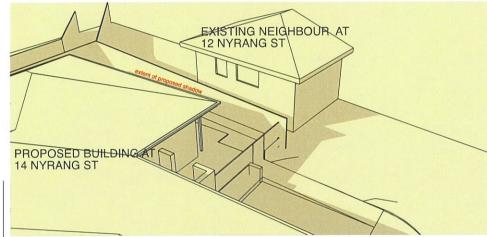



PROPOSED BUILDING AT 14 NYRANG ST

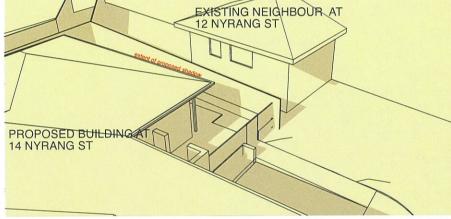


# **(04) VIEW JUNE 21ST 12 NOON**

#### **CONCLUSION-**


THE SHADOWS FROM THE PROPOSED DEVELOPMENT HAVE NO EFFECT ON THE SOUTHERN NEIGHBOUR. THIS IS OBVIOUS AS THE PROPOSED DEVELOPMENT IS A ONE STOREY BUILDING WHOSE SHADOWS DO NOT GO HIGHER THAN THE BOUNDARY FENCE. THE NEIGHBOUR'S DAYLIGHT IS SIMILARLY UNAFFECTED

**CALCULATIONS-**

SOUTHERN NEIGHBOUR SOLAR ACCESS LOSS 0% SOUTHERN NEIGHBOUR DAYLIGHT ACCESS LOSS 0%

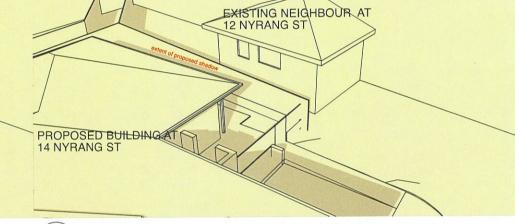

# (06) VIEW JUNE 21ST 2 PM

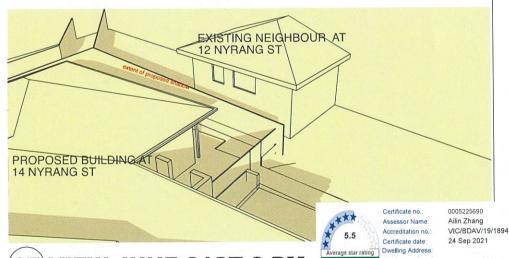

(07) VIEW JUNE 21ST 3 PM

	5.5	Accreditation
	*	Certificate date
	Average star rating NATIONWIDE HOUSE	14 Nyrang R Orange, NS\
_	ENERGY RATING SCHEME	2800
	www.nathers.gov.au	www.nathe

#### Amendments

B ROOM NUMBERS INCREASED TO 8 01/06/19 C OUTDOOR SPACE RELOCATED 25/03/20 D ROOM NUMBERS REDUCED TO 6 20/07/20

(03) VIEW JUNE 21ST 11 AM

- E BINS RELOCATED
- F OPEN SPACE RELOCATED TO NORTHWEST

#### Architect

28/06/21

23/08/21

Fortey + Grant Architecture Suite 3/ Level 1, 1141 Botany Lane Mascot NSW 2020 mob: 0401 822 223 email: james@fgarch.com.au

### **Project Details**

**NEW BOARDING HOUSE AT** 

**14 NYRANG ROAD ORANGE NSW 2800** 

# reports and drawings. All dimensions used to be figured dimensions only. Do not scale from drawings. Report any discepencies to the Architect for a decision before

proceeding with work. Date Printed Drawn Approved 23/8/21 JG JG Job Number 1917


Scale

**DA-10** As shown @ A3

### **SHADOW VIEWS**

Drawing Number

Drawing name

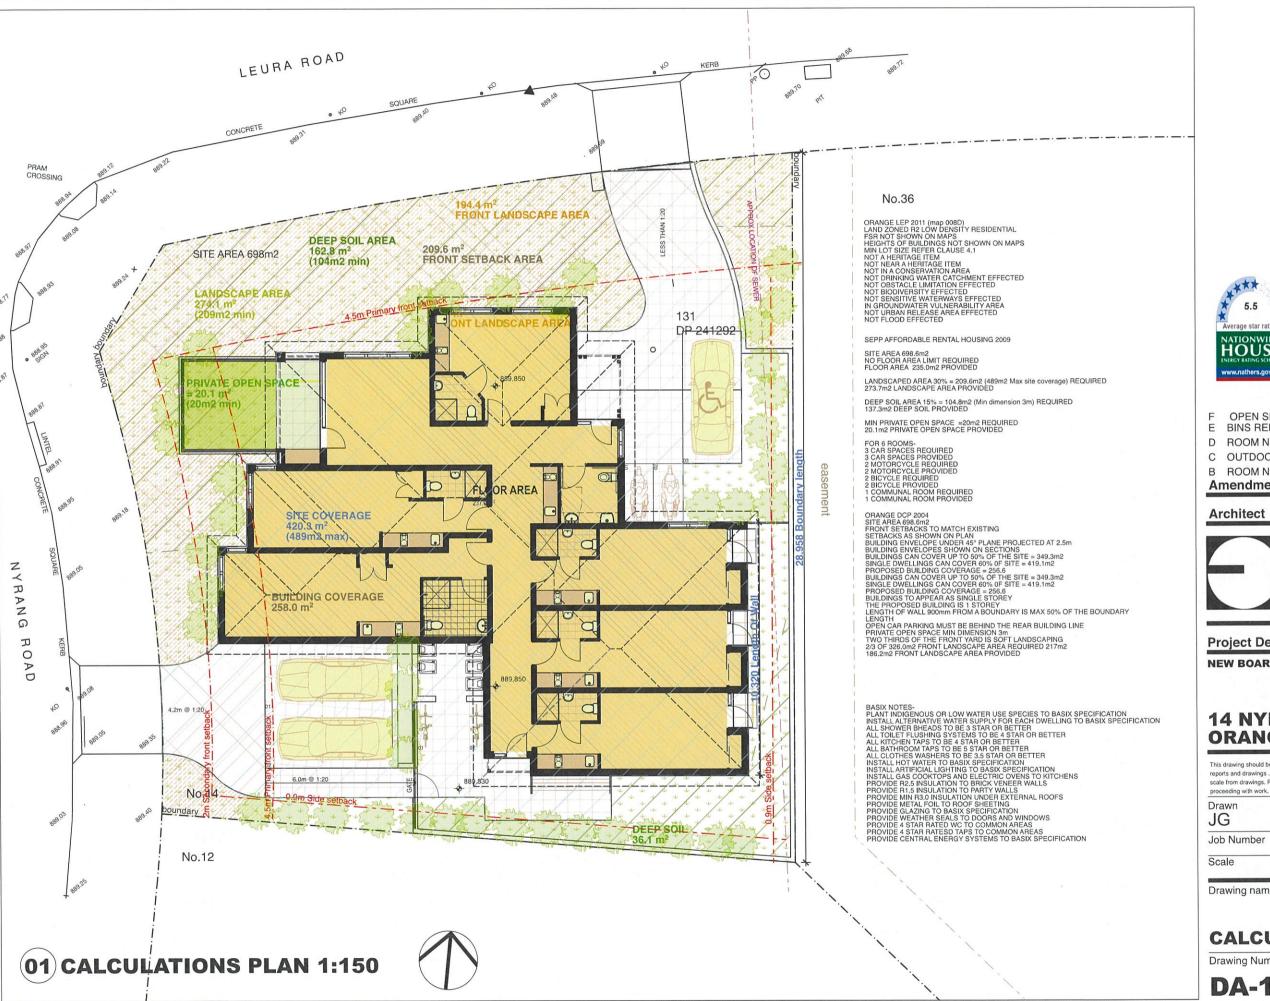



Certificate no.: Assessor Name: Accreditation no Certificate date: Dwelling Address: 14 Nyrang Road Orange, NSW

0005225690 Ailin Zhang VIC/BDAV/19/1894 24 Sep 2021

2800

www.nathers.gov.au

OPEN SPACE RELOCATED TO NORTH 2025 08721 E BINS RELOCATED

D ROOM NUMBERS REDUCED TO 6 C OUTDOOR SPACE RELOCATED

B ROOM NUMBERS INCREASED TO 8

### Amendments

#### Fortey + Grant Architecture

Suite 3/ Level 1, 1141 Botany Lane Mascot NSW 2020 mob: 0401 822 223

email: james@fgarch.com.au

#### **Project Details**

**NEW BOARDING HOUSE AT** 

### **14 NYRANG ROAD ORANGE NSW 2800**

reports and drawings. All dimensions used to be figured dimensions only. Do not scale from drawings. Report any discepencies to the Architect for a decision before proceeding with work.

Date Printed Drawn Approved JG 23/8/21 JG Job Number 1917 Scale As shown @ A3

Drawing name

### **CALCULATIONS**

Drawing Number

Amendment

**DA-11**