

## S96 + CONSTRUCTION CERTIFICATE ISSUE

ALTERATIONS & ADDITIONS TO EXISTING DWELLING FOR DANIEL SCARLET

LOT 222, D.P. 208479 47 ANDERSON STREET PORT MACQUARIE, NSW, 2444

### ARCHITECTURAL DRAWING INDEX:

Rev B B
В
А
В
В
В
В
В
В
В
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В
В
В
В
В
А
А

### NOTES:

### **GENERAL NOTES:**

ALL WORKS TO BE CARRIED OUT IN ACCORDANCE WITH THE NCC, AUSTRALIAN STANDARDS, LOCAL AUTHORITY REQUIREMENTS AND ALL RELEVANT STATUTORY CONTROLS.

ALL DRAWINGS TO BE ACKNOWLEDGED IN CONJUNCTION WITH SPECIFICATIONS AND CONSULTANT DOCUMENTATION. ANY DISCREPANCIES SHOULD BE NOTIFIED AND BROUGHT TO THE ATTENTION OF THE ARCHITECT.

CONTRACTOR IS RESPONSIBLE FOR ACKNOWLEDGEMENT OF ALL EXISTING SERVICES ON SITE AND IS TO SATISFY THEMSELVES THAT RELEVANT SERVICES HAVE BEEN DECOMMISSIONED PRIOR TO COMMENCING WORKS.

CONTRACTOR TO OBTAIN ALL REQUIRED CERTIFICATES OF COMPLIANCE, INCLUDING, BUT NOT LIMITED TO: STRUCTURAL, ELECTRICAL, PLUMBING, WATERPROOFING, TERMITE PROTECTION, GLAZING, ETC, FOR ISSUE AND ACKNOWLEDGEMENT OF THE OWNER PRIOR TO COMPLETION.

### **DEMOLITION:**

DEMOLITION TO BE CARRIED OUT IN ACCORDANCE WITH AS2601-2001 - THE DEMOLITION OF STRUCTURES.

### TERMITE CONTROL MANAGEMENT:

CONTRACTOR TO CHECK, VERIFY AND PROVIDE AN APPROPRIATE TERMITE MANAGEMENT SYSTEM, TO ALL AREAS OF DEMOLITION AND NEW WORKS IN ACCORDANCE WITH NCC REGULATIONS AND AS3660.

### DAMP-PROOFING, FLASHING, WATERPROOFING:

INSTALL FLASHINGS, DRIPS, WEATHER SEALS, CAULKING, POINTING OR THE LIKE SO THAT WATER IS PREVENTED FROM ENTERING THE BUILDING. ALL WATERPROOFING TO BE IN ACCORDANCE WITH AS3740. ALL WET AREAS TO BE CERTIFIED BY AN ACCREDITED CERTIFIER.

### **CONCRETE, SLABS AND FOOTINGS:**

ALL SLABS AND FOOTINGS TO BE IN ACCORDANCE WITH AS2870. CONCRETE AND WORKMANSHIP TO BE IN ACCORDANCE WITH THE NCC AND AS3600 - CONCRETE STRUCTURES. FORMWORK AND SCAFFOLDING IS THE RESPONSIBILITY OF THE CONTRACTOR, WHICH SHALL COMPLY WITH THE REQUIREMENTS OF AS3610 AND AS1576 RESPECTIVELY.

### PLUMBING:

PLUMBING WORK TO BE CARRIED OUT BY A LICENSED CONTRACTOR IN ACCORDANCE WITH THE AUTHORITIES HAVING JURISDICTION OVER THE WORKS. DEVELOPMENT WORKS ARE NOT TO PROCEED PAST THE NOTIFIABLE HOLD POINTS WITHOUT APPROVAL BY COUNCIL. PROVIDE TO COUNCIL CERTIFICATE OF COMPLIANCE AND SEWER SERVICE DIAGRAM. ALL NEW HOT WATER SERVICE PIPES TO NCC AND AS3500.

### SEWER

CONTRACTOR TO LOCATE EXISTING SEWER LINE PRIOR TO UNDERTAKING ANY WORKS. NEW SEWER WORKS / LINES TO CONNECT TO EXISTING.

### STORMWATER

CONTRACTOR TO LOCATE EXISTING STORMWATER LINE AND KERB OUTLET PRIOR TO UNDERTAKING ANY WORKS. NEW STORMWATER TO CONNECT TO EXISTING KERB OUTLET.

### CARPENTRY

TIMBERS SHALL BE BEST QUALITY OF THEIR RESPECTIVE SELECTION AND GRADE CONFORMING WITH AS1684 - RESIDENTIAL TIMBER-FRAMED CONSTRUCTION.

### STEELWORK:

ALL STRUCTURAL STEELWORK TO BE IN ACCORDANCE WITH STRUCTURAL ENGINEERS DESIGN AND SPECIFICATION AND COMPLY WITH AS4100 - STEEL STRUCTURES.

# BRICKWORK:

ALL MATERIALS AND WORKMANSHIP TO COMPLY WITH AS3700, AS2699 AND THE NCC. BRICKWORK TO BE LEVEL, STRAIGHT AND PLUMB AND PERFECTLY BONDED. BUILD IN ALL DPC'S, ARCH BARS, WALL TIES, AND THE LIKE.

**BASIX** Certificate

Building Sustainability Index www.basix.nsw.gov.au

222

0

42 Anderson Street

Deposited Plan 208479

Separate dwelling house

42 Anderson Street Port Macquarie 2444

Port Macquarie-Hastings Council

**Alterations and Additions** 

Certificate number: A221853

Local Government Area

Plan type and number

Type of alteration and

Project address

Project name

Street address

Lot number
Section number

Project type

Dwelling type

addition

### **EROSION & SEDIMENT CONTROL NOTES:**

ALL WORK SHALL GENERALLY BE CARRIED OUT AND MAINTAINED IN ACCORDANCE WITH:

- LOCAL AUTHORITY REQUIREMENTS
- EPA POLLUTION CONTROL FOR URBAN STORMWATER
- DEPARTMENT OF CONSERVATION & LAND MANAGEMENT MANUAL "URBAN EROSION & SEDIMENT CONTROL"

SITE WORKS ARE NOT TO START UNTIL EROSION AND SEDIMENT CONTROL MEASURES ARE INSTALLED AND FUNCTIONAL. ALL SOIL AND WATER CONTROL MEASURES ARE TO BE PUT BACK IN PLACE AT THE END OF EACH WORKING DAY AND MODIFIED TO BEST SUIT CONDITIONS.

MINIMISE THE AREA OF SITE BEING DISTURBED AT ANY ONE TIME AND CONTROL WATER FROM UPSTREAM OF THE SITE SUCH THAT IT DOES NOT ENTER THE DISTURBED SITE.

PROTECT ALL STOCKPILES OF MATERIAL FROM SCOUR AND EROSION. DO NOT STOCKPILE LOOSE MATERIAL IN ROADWAYS, NEAR DRAINAGE PITS OR IN WATERCOURSES. STOCKPILES TO BE RETAINED ON-SITE WITH PROTECTIVE COVERING OR TO BE SURROUNDED BY AN APPROPRIATELY LOCATED FILTER FENCE TO CHECK EROSION.

SPOIL AND TOPSOIL STOCKPILES SHALL BE LOCATED AWAY FROM DRAINAGE LINE AND AREAS WHERE WATER MAY CONCENTRATE.

FOLLOWING CONSTRUCTION, TOPSOIL SHALL BE RE-SPREAD AND ALL DISTURBED AREAS STABILISED AND REVEGETATED WITHIN 20 DAYS OF COMPLETION OF WORKS GUTTERING TO CONNECT TO THE STORMWATER SYSTEM OR RAINWATER HARVESTING SYSTEM AS SOON AS PRACTICABLE AND BEFORE ROOFING MATERIAL IS INSTALLED. MAINTAIN ALL STORMWATER PIPES AND PITS CLEAR OF DEBRIS AND SEDIMENT, INSPECT STORMWATER SYSTEM AND CLEAN OUT AFTER EACH STORM EVENT.

### **WASTE MANAGEMENT NOTES:**

My renovation work is valued at \$50,000 or more,

and does not include a pool (and/or spa).


### CONSTRUCTION


WASTE SHALL BE STORED AND STOCKPILED SEPARATELY. APPROVED BINS FOR BUILDING, CONCRETE AND MORTAR SLURRIES, PAINTS, ACID WASHINGS AND LITTER TO BE PROVIDED AND ARRANGEMENTS MADE FOR REGULAR COLLECTION AND DISPOSAL. REDUCE WASTE, REUSE AND RECYCLE MATERIALS WHERE APPROPRIATE.

### OCCUPATION

WASTE SHALL BE STORED IN ACCORDANCE WITH PORT MACQUARIE-HASTINGS COUNCIL'S POLICY FOR WASTE MINIMISATION. GENERAL WASTE, GREEN WASTE AND COMBINED RECYCLABLES SHALL BE STORED IN SEPARATE MOBILE GARBAGE BINS AND SHALL BE PLACED KERBSIDE WEEKLY FOR COLLECTION IN ACCORDANCE WITH COUNCIL'S STANDARD RESIDENTIAL COLLECTION SERVICES

### SILT FENCE DETAIL:

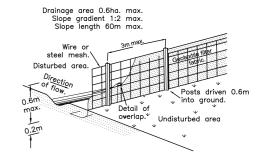

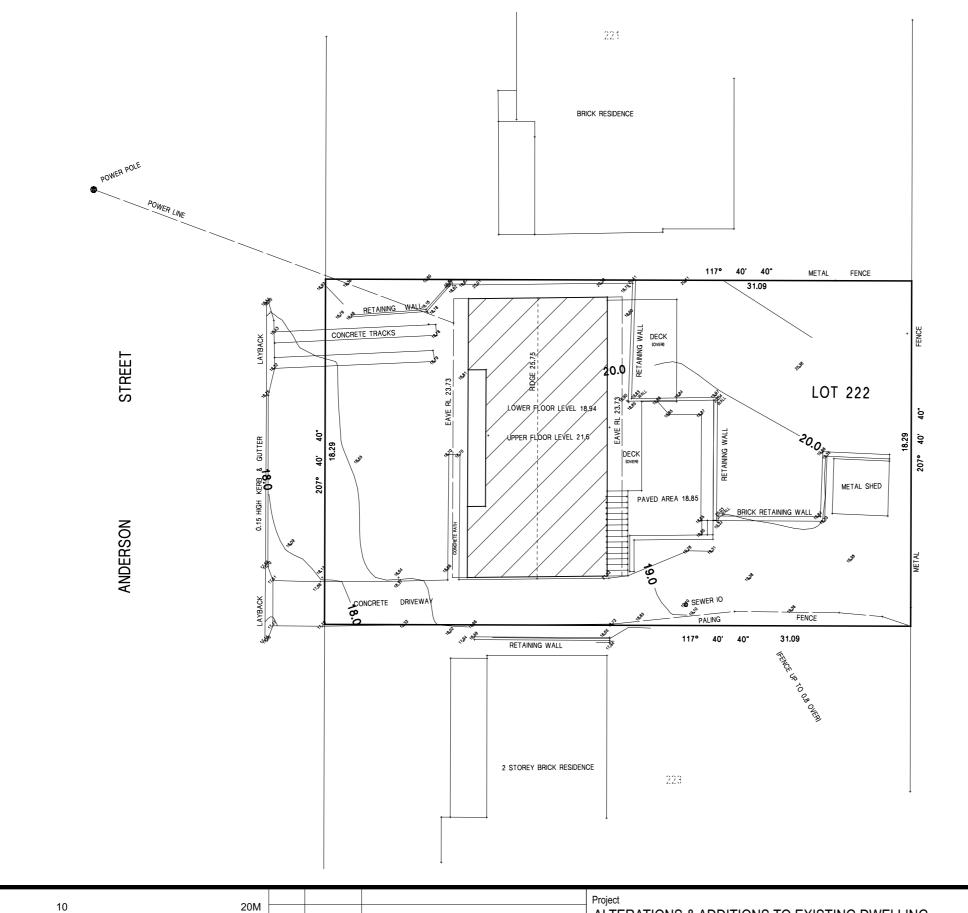

DESCRIPTION

REV DATE

TO APPLY STANDARD BUILDING TOLERANCES.



# FRANK O'ROURKE, REGISTERED SURVEYOR CONSULTING SURVEYORS

37 GRANDVIEW PARADE, PORT MACQUARIE. P.O. BOX 1387, PORT MACQUARIE. 2444.

Telephone: 02 65 822861

Facsimile: 02 65 826241


E-mail: surveyor@midcoast.com.au

Drawing Title 20M ALTERATIONS & ADDITIONS TO EXISTING DWELLING **SURVEY EXISTING** LOT 222, D.P. 208479, ANDERSON STREET PORT MACQUARIE, NSW, 2444 Drawn Scale AS SHOWN @ A3 | Date 29/5/19 DESIGN AND DRAWING ARE COPYRIGHT AND CANNOT BE USED WITHOUT PERMISSION. USE FIGURED DIMENSIONS IN PREFERENCE TO SCALED DIMENSIONS. CONTRACTOR MUST VERIFY ALL DIMENSIONS ON SITE BEFORE PREPARING SHOP DRAWINGS OR COMMENCING WORK. THE DIMENSIONS SHOWN ARE COMPUTER GENERATED AND THE CONTRACTOR IS Checked Project Number DANIEL SCARLET S96 + CONSTRUCTION CERTIFICATE ISSUE 29.5.19

KEY:

WATER METRE POWER POLE ELECTRICAL PILLAR ΕP TELSTRA PIT

ΤP HYD **HYDRANT** 

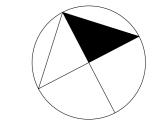


### KEY:

DENOTES GROUND FLOOR\_GARAGE AND UPPER FLOOR BALCONY ADDITIONS

DENOTES FIRST FLOOR\_DECK EXTENSION

DENOTES EXISTING RESIDENCE

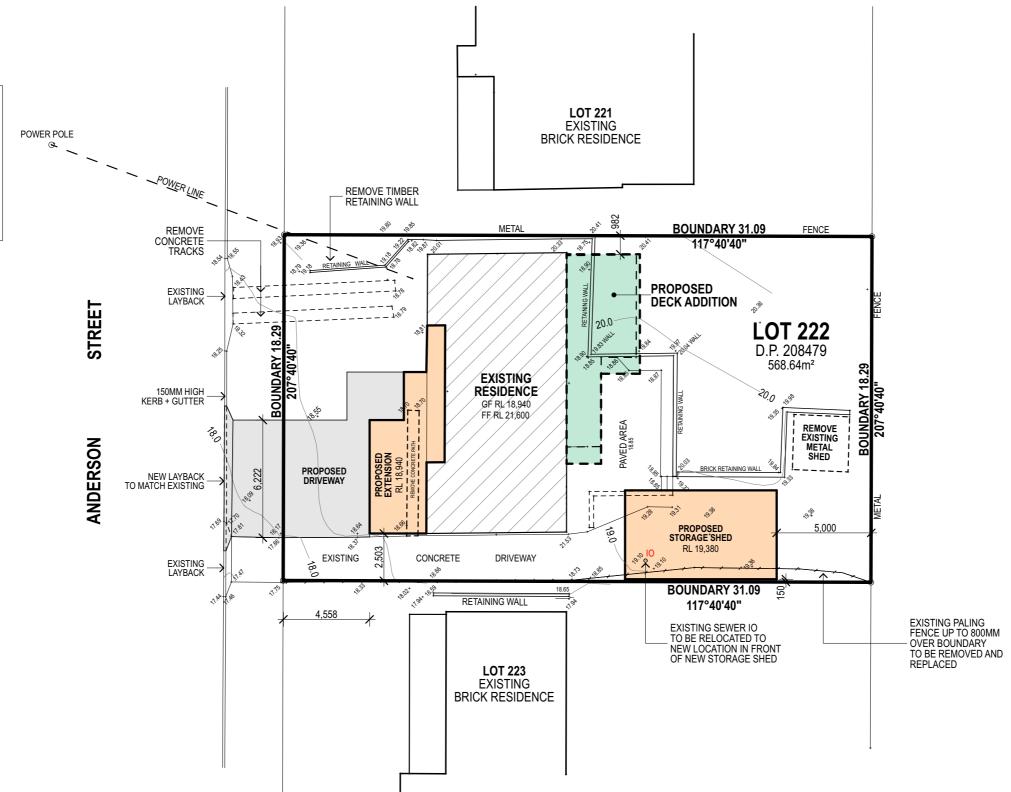

AREAS: SITE: 568.64 M<sup>2</sup> **GROUND FLOOR EXISTING:** 102.65 M<sup>2</sup> 130.62 M<sup>2</sup> **GROUND FLOOR PROPOSED:** FIRST FLOOR EXISTING: 109.59 M<sup>2</sup> FIRST FLOOR PROPOSED: 112.72 M<sup>2</sup> FIRST FLOOR DECK: 33.17 M<sup>2</sup> FIRST FLOOR BALCONY: 17.89 M<sup>2</sup> STORAGE SHED: 37.69 M<sup>2</sup>

SITE PLAN Scale 1:200

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MC			
JST			
NG	В	29.5.19	S96 + CONSTRUCTION CERTIFICATE ISSUE
RIS	Α	28.12.14	TENDER ISSUE
	REV	DATE	DESCRIPTION

ALTERATIONS & ADDITIONS TO EXISTING DWELLING LOT 222, D.P. 208479, ANDERSON STREET PORT MACQUARIE, NSW, 2444 DANIEL SCARLET


Drawing Title SITE PLAN


Drawn Scale **AS SHOWN @ A3** Date **29/5/19** Checked Project Number

1403

Revision (B)

Dwg No.

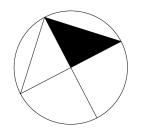

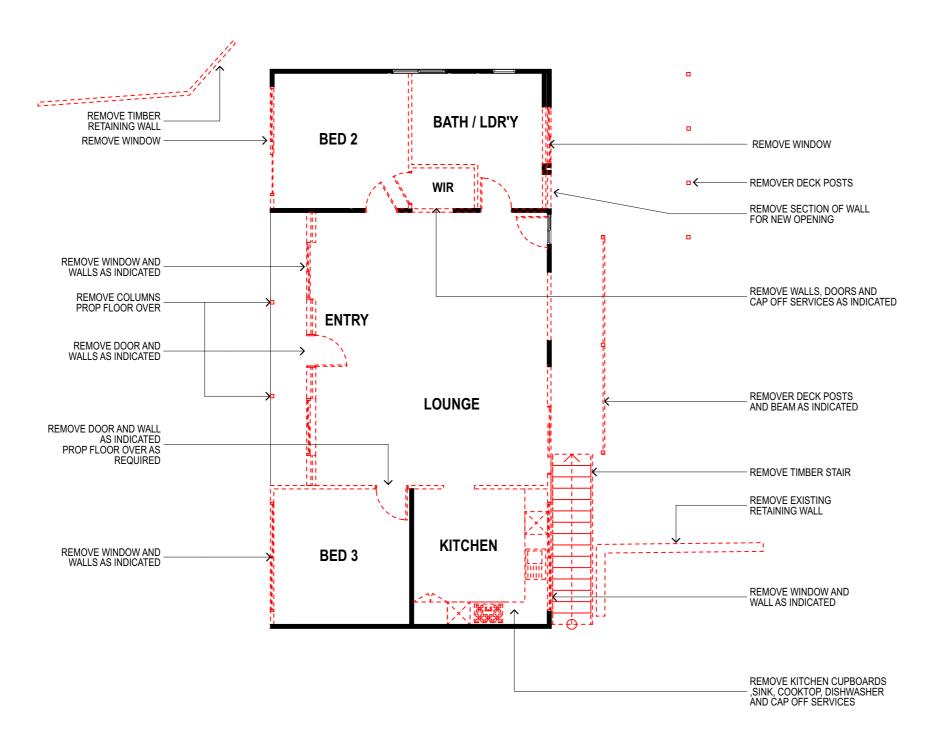


KEY:

WALLS + FLOOR EXISTING (TO BE RETAINED)

- WALLS, WINDOWS, DOORS AND ELEMENTS
(TO BE DEMOLISHED)

### **GROUND FLOOR - DEMOLITION PLAN** Scale 1:100


0 5 10M				Project ALTERATIONS & ADDITIONS TO EXISTING DWELLING LOT 222, D.P. 208479, ANDERSON STREET	Drawing Ti		LOOR - DEMOLITIC	ON PLAN	
DESIGN AND DRAWING ARE COPYRIGHT AND CANNOT BE USED WITHOUT PERMISSION. USE FIGURED DIMENSIONS IN PREFERENCE TO SCALED DIMENSIONS. CONTRACTOR MUST				PORT MACQUARIE, NSW, 2444	Drawn	JJR	Scale AS SHOWN @ A3	Date <b>29/5/19</b>	Dwg No.
VERIFY ALL DIMENSIONS ON SITE BEFORE PREPARING SHOP DRAWINGS OR COMMENCING	_	29.5.19	S96 + CONSTRUCTION CERTIFICATE ISSUE	Client	Checked		Project Number	4 4 0 0	CC-04
WORK. THE DIMENSIONS SHOWN ARE COMPUTER GENERATED AND THE CONTRACTOR IS	Α	28.12.14	TENDER ISSUE	DANIEL SCARLET				1403	
TO APPLY STANDARD BUILDING TOLERANCES.	REV	DATE	DESCRIPTION					1 100	Revision B

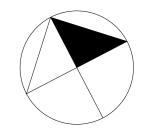

KEY:


WALLS + FLOOR EXISTING (TO BE RETAINED)


- WALLS, WINDOWS, DOORS AND ELEMENTS
(TO BE DEMOLISHED)

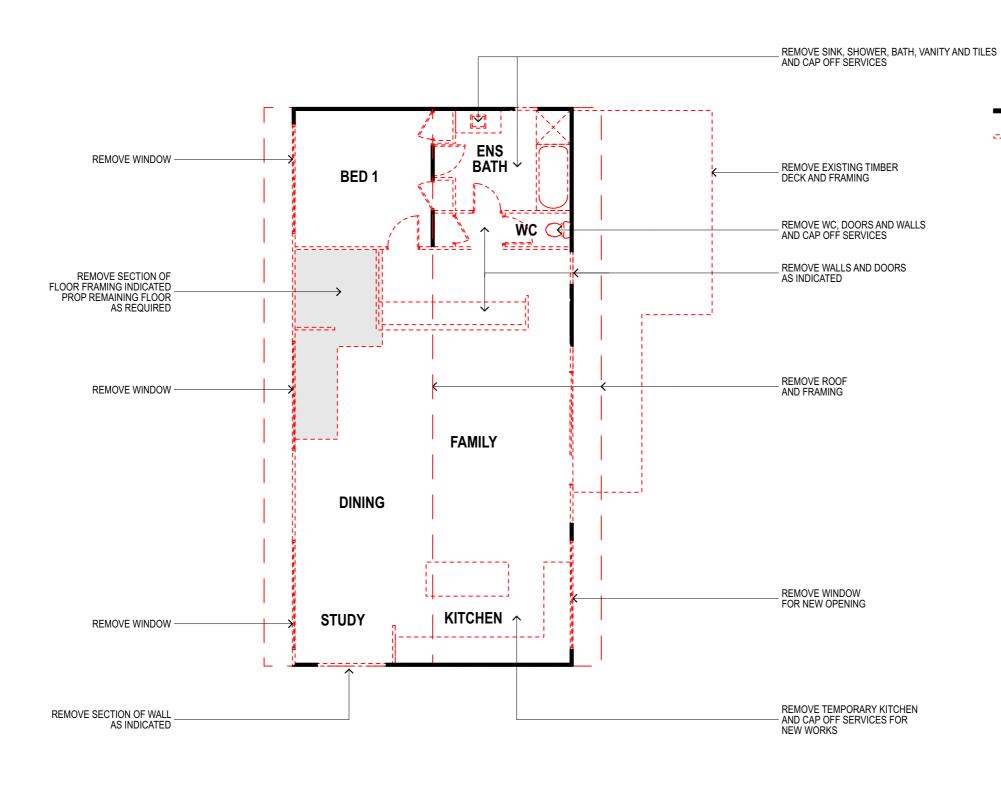


### UPPER FLOOR - DEMOLITION PLAN Scale 1:100

0 5 10M				Project ALTERATIONS & ADDITIONS TO EXISTING DWELLING LOT 222, D.P. 208479, ANDERSON STREET	Drawing T		OR DEMOLITION P	LAN	
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WORK. THE DIMENSIONS SHOWN ARE COMPUTER GENERATED AND THE CONTRACTOR IS	Α	28.12.14	TENDER ISSUE	DANIEL SCARLET				1403	
TO APPLY STANDARD BUILDING TOLERANCES.	REV	/ DATE	DESCRIPTION					1 100	Revision B

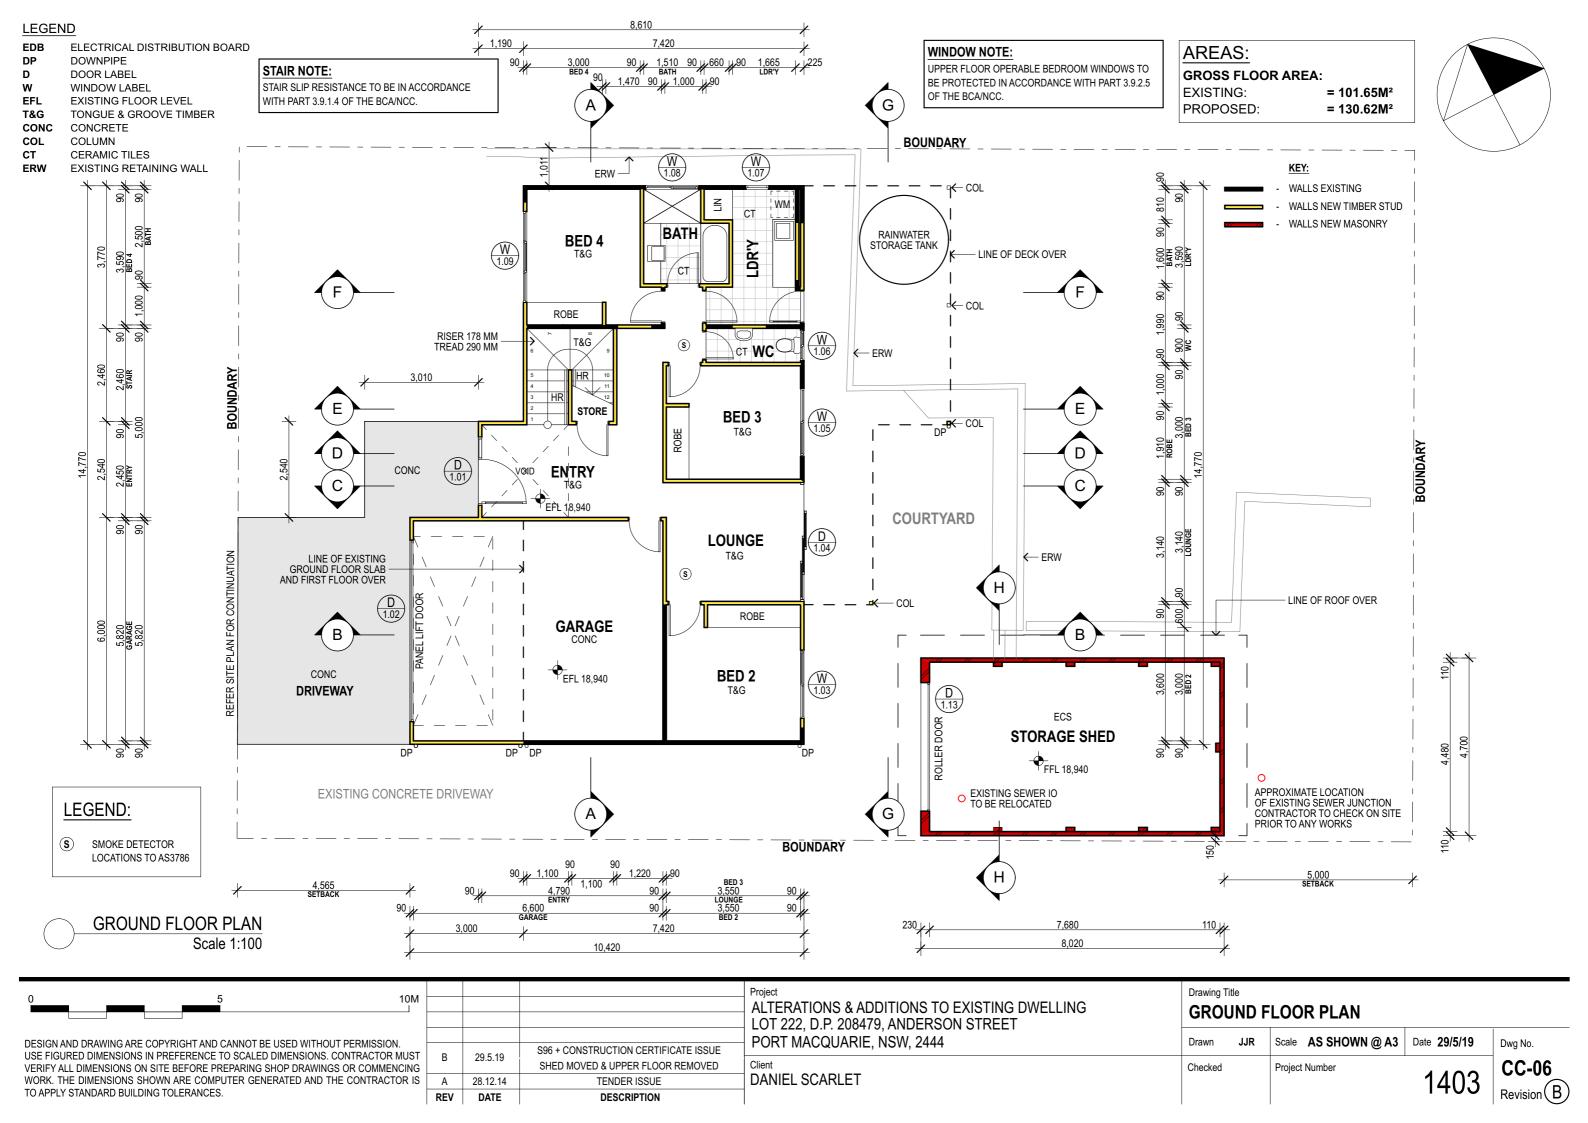

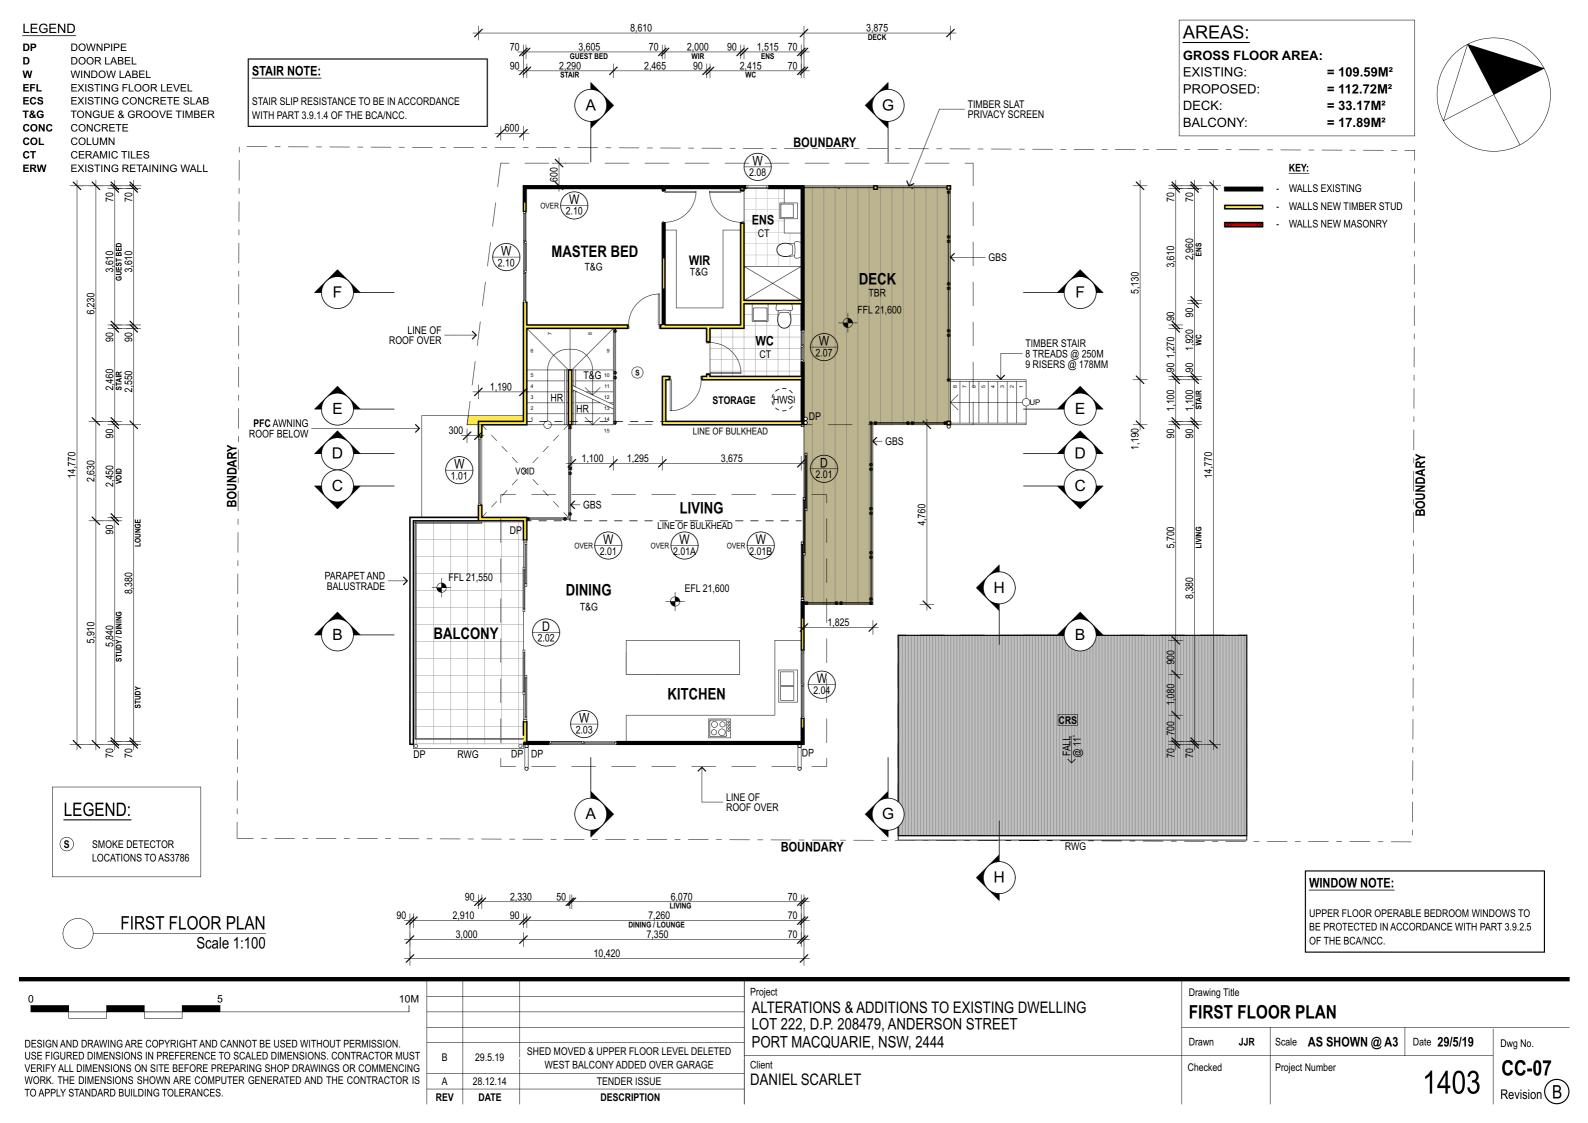

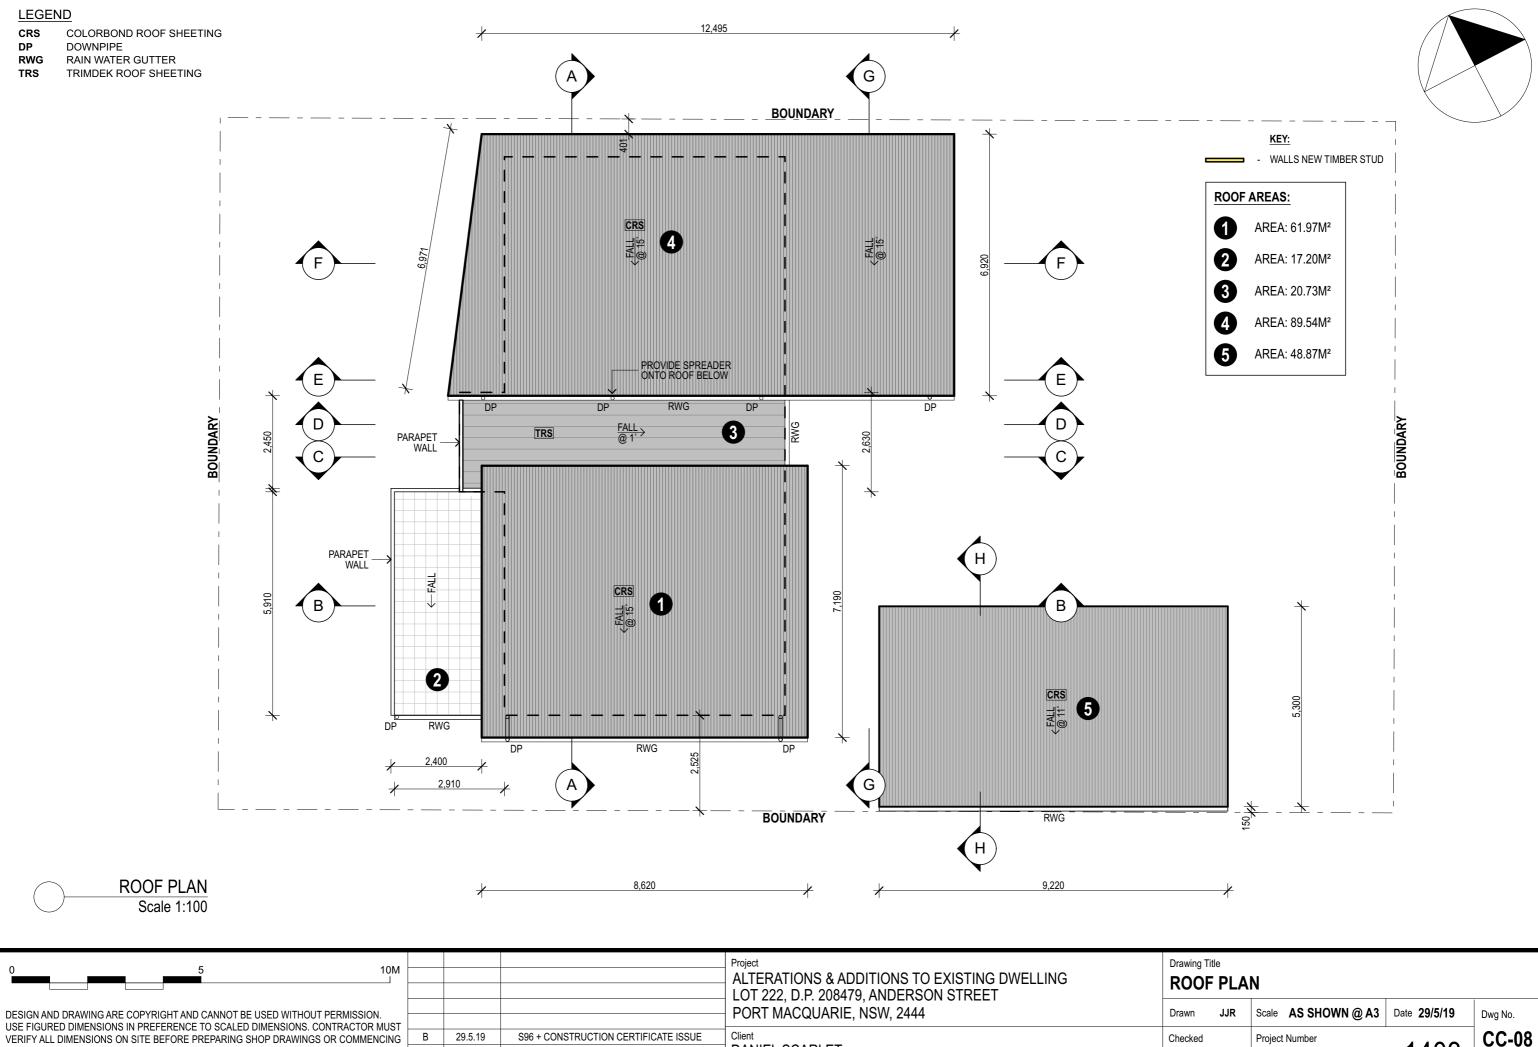

DANIEL SCARLET

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TO APPLY STANDARD BUILDING TOLERANCES.

28.12.14


REV DATE

TENDER ISSUE

DESCRIPTION


1403

Revision B

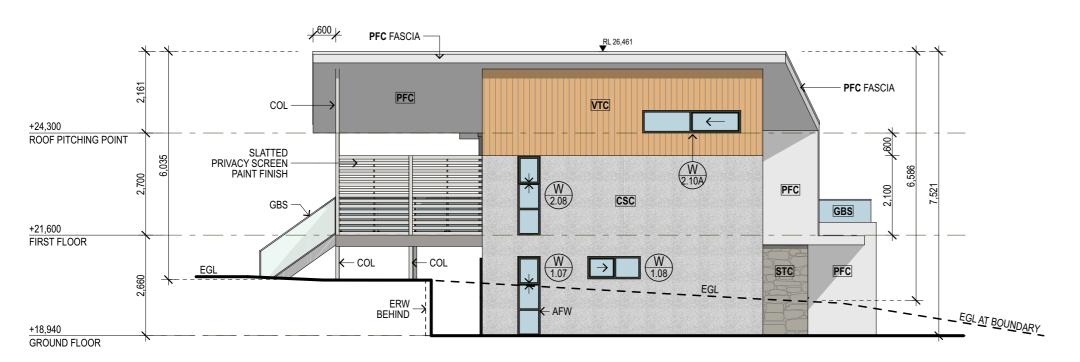


LEGEND: AFW ALUMINIUM FRAMED WINDOWS AFD ALUMINIUM FRAMED DOORS COL COLUMN CRS COLORBOND ROOF SHEETING DP DOWN PIPE D DOOR LABLE ERW EXISTING RETAINING WALL EGL EXISTING GROUND LINE GBS GLAZED BALUSTRADE TFD TIMBER FRAMED DECK PAINTED FIBRE CEMENT PFC RWG RAINWATER GUTTER STC STONE TILE CLADDING WBC WEATHERBOARD CLADDING VTC VERTICAL TIMBER CLADDING WINDOW LABLE

NORTH EAST ELEVATION
Scale 1:100

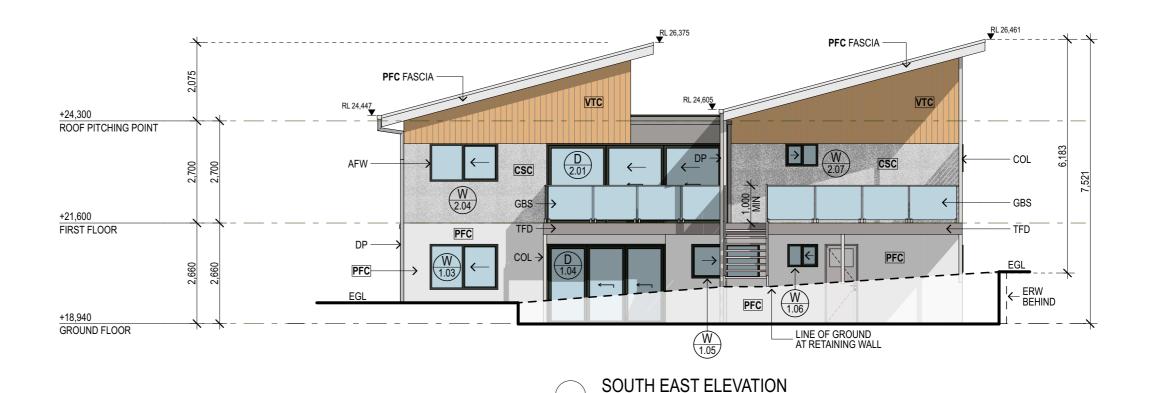

Scale 1:100

Drawing Title 10M ALTERATIONS & ADDITIONS TO EXISTING DWELLING NORTH EAST + SOUTH EAST ELEVATIONS LOT 222, D.P. 208479, ANDERSON STREET PORT MACQUARIE, NSW, 2444 Drawn Scale AS SHOWN @ A3 Date 29/5/19 Dwg No. DESIGN AND DRAWING ARE COPYRIGHT AND CANNOT BE USED WITHOUT PERMISSION. USE FIGURED DIMENSIONS IN PREFERENCE TO SCALED DIMENSIONS. CONTRACTOR MUST S96 + CONSTRUCTION CERTIFICATE ISSUE 29.5.19 VERIFY ALL DIMENSIONS ON SITE BEFORE PREPARING SHOP DRAWINGS OR COMMENCING Checked Project Number 1403 WORK. THE DIMENSIONS SHOWN ARE COMPUTER GENERATED AND THE CONTRACTOR IS DANIEL SCARLET 28.12.14 Α TENDER ISSUE TO APPLY STANDARD BUILDING TOLERANCES. REV DATE DESCRIPTION

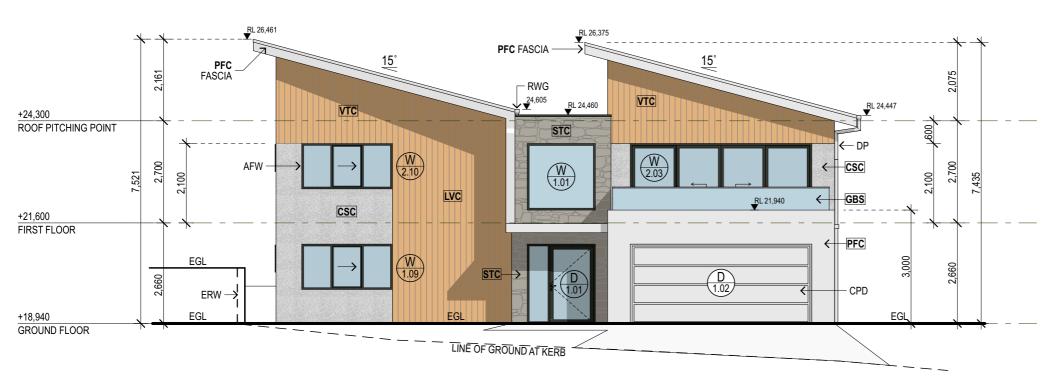



LEGEND: AFW ALUMINIUM FRAMED WINDOWS AFD ALUMINIUM FRAMED DOORS COL COLUMN CRS COLORBOND ROOF SHEETING DP DOWN PIPE D DOOR LABLE ERW EXISTING RETAINING WALL EGL EXISTING GROUND LINE GBS GLAZED BALUSTRADE TFD TIMBER FRAMED DECK PFC PAINTED FIBRE CEMENT RWG RAINWATER GUTTER STC STONE TILE CLADDING WBC WEATHERBOARD CLADDING VTC VERTICAL TIMBER CLADDING WINDOW LABLE

NORTH WEST ELEVATION
Scale 1:100



Drawing Title 10M ALTERATIONS & ADDITIONS TO EXISTING DWELLING NORTH WEST + SOUTH WEST ELEVATIONS LOT 222, D.P. 208479, ANDERSON STREET PORT MACQUARIE, NSW, 2444 Drawn Scale AS SHOWN @ A3 Date 29/5/19 Dwg No. DESIGN AND DRAWING ARE COPYRIGHT AND CANNOT BE USED WITHOUT PERMISSION. USE FIGURED DIMENSIONS IN PREFERENCE TO SCALED DIMENSIONS. CONTRACTOR MUST S96 + CONSTRUCTION CERTIFICATE ISSUE 29.5.19 VERIFY ALL DIMENSIONS ON SITE BEFORE PREPARING SHOP DRAWINGS OR COMMENCING Checked Project Number 1403 WORK. THE DIMENSIONS SHOWN ARE COMPUTER GENERATED AND THE CONTRACTOR IS DANIEL SCARLET 28.12.14 Α TENDER ISSUE TO APPLY STANDARD BUILDING TOLERANCES. REV DATE DESCRIPTION

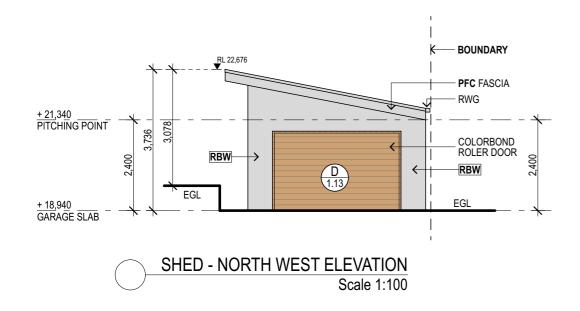


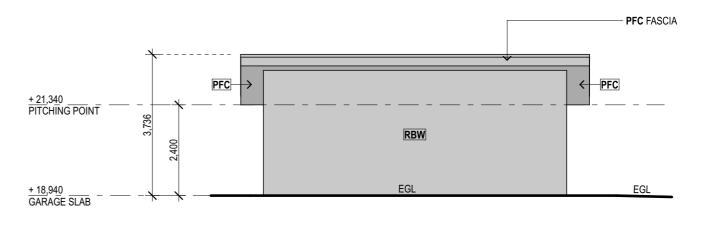


SHED - NORTH EAST ELEVATION
Scale 1:100

## LEGEND:


EGL EXISTING GROUND LINE
RBW RENDERED BRICKWORK
PFC PAINTED FIBRE CEMENT
CRS COLORBOND ROOF SHEETING

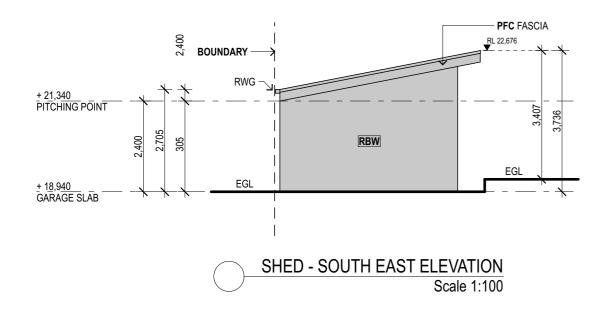


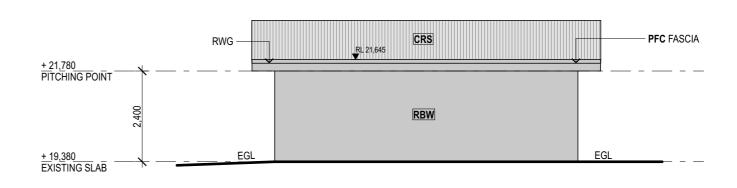

SHED - SOUTH WEST ELEVATION
Scale 1:100


0 5 10M				Project ALTERATIONS & ADDITIONS TO EXISTING DWELLING LOT 222, D.P. 208479, ANDERSON STREET	Drawing T		SHED ELEVATIONS	3	
DESIGN AND DRAWING ARE COPYRIGHT AND CANNOT BE USED WITHOUT PERMISSION. USE FIGURED DIMENSIONS IN PREFERENCE TO SCALED DIMENSIONS. CONTRACTOR MUST				PORT MACQUARIE, NSW, 2444	Drawn	JJR	Scale AS SHOWN @ A3	Date 29/5/19	Dwg No.
VERIFY ALL DIMENSIONS ON SITE BEFORE PREPARING SHOP DRAWINGS OR COMMENCING	_	29.5.19	S96 + CONSTRUCTION CERTIFICATE ISSUE	Client	Checked		Project Number		CC-11
WORK. THE DIMENSIONS SHOWN ARE COMPUTER GENERATED AND THE CONTRACTOR IS	Α	28.12.14	TENDER ISSUE	DANIEL SCARLET				1403	
TO APPLY STANDARD BUILDING TOLERANCES.	REV	DATE	DESCRIPTION					1 100	Revision B

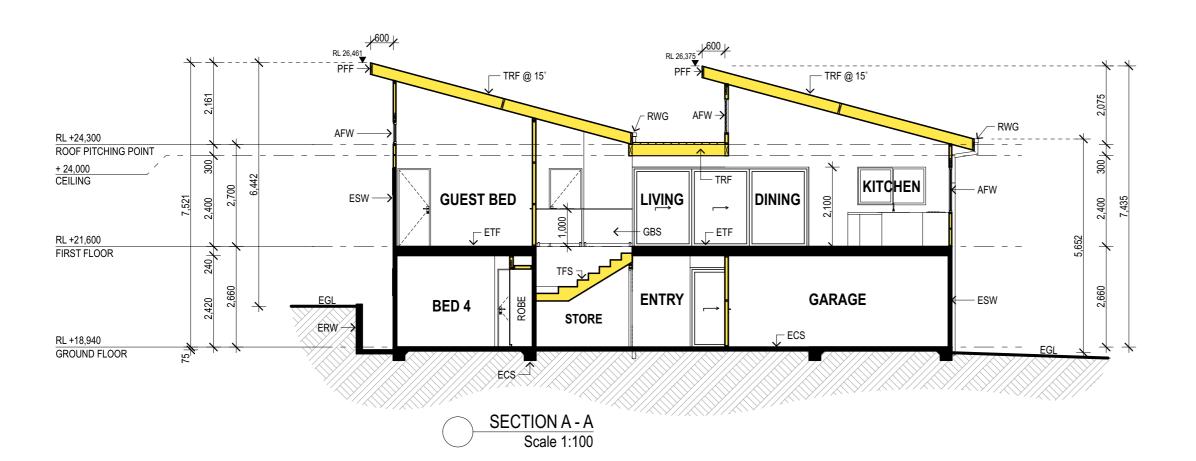


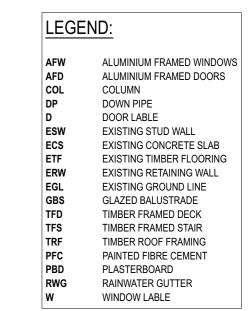



W 2.01 W 2.01B 1600 CRS RL +24,300 ROOF PITCHING POINT + 24,000 CEILING LIVING DINING 2,400 **BALCONY** 1,000 – ETF - GBS -RL +21,600 FIRST FLOOR 240 / 2,660 2,420 **GARAGE** BED 2 - TSW ECS-RL +18,940 GROUND FLOOR -ZA-V-J-A-EGL SECTION B - B Scale 1:100


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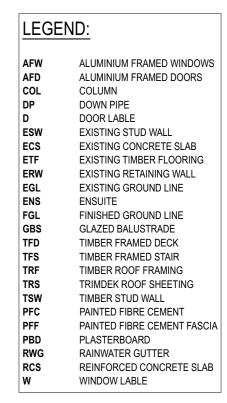


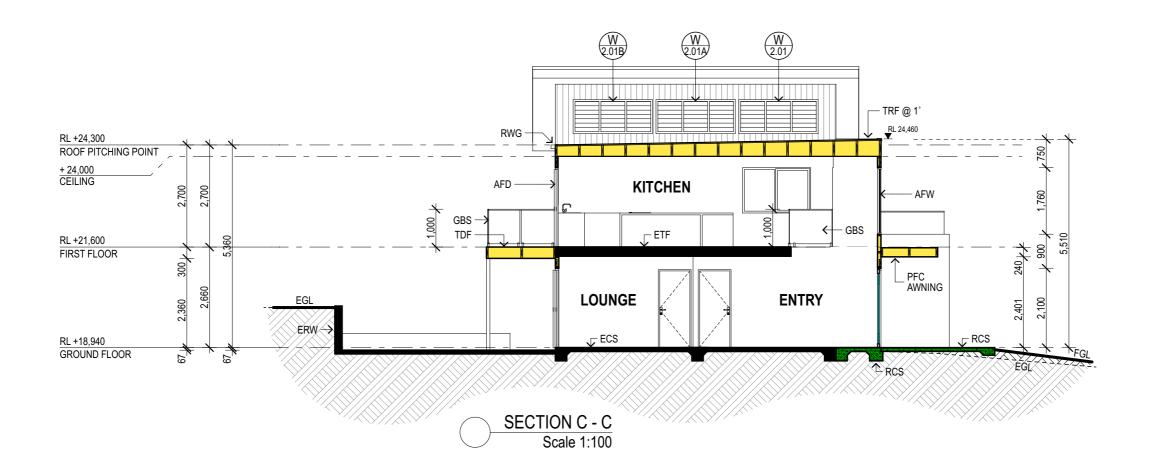


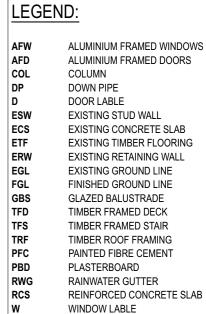


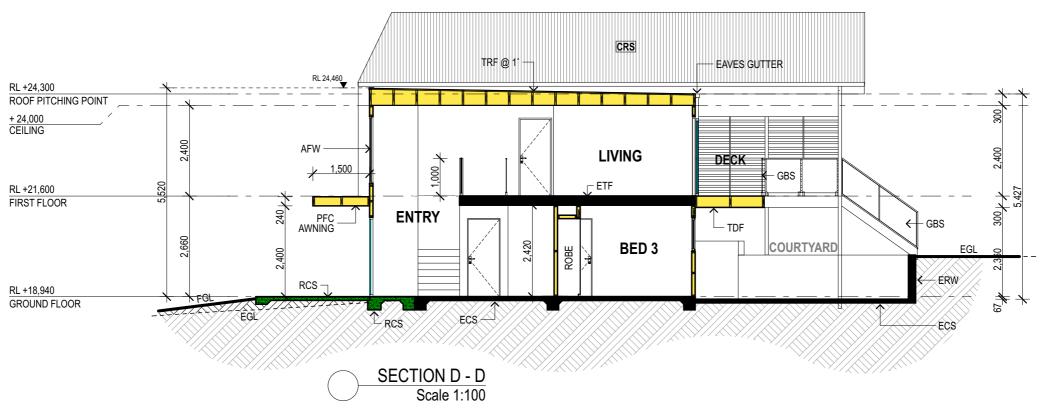


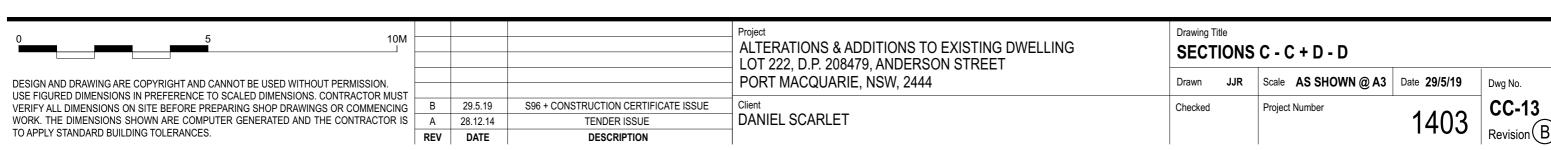

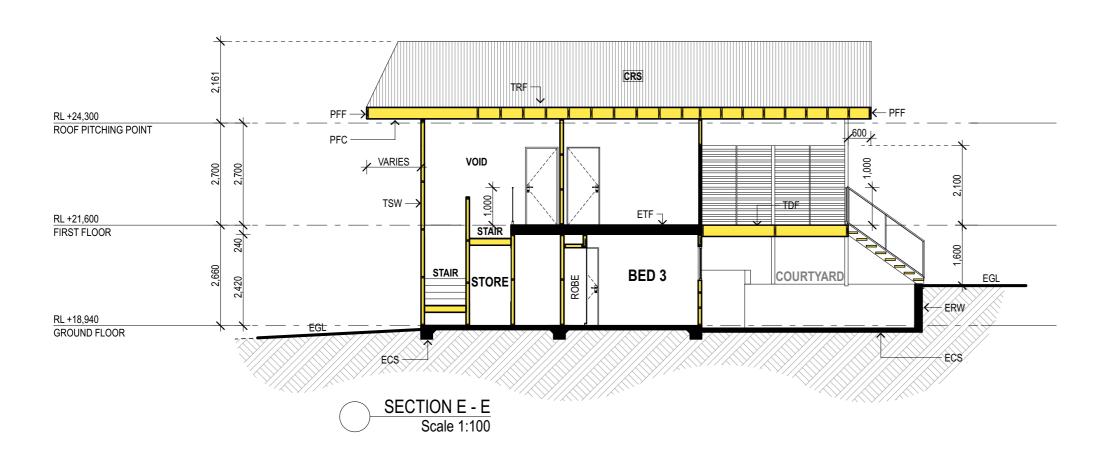

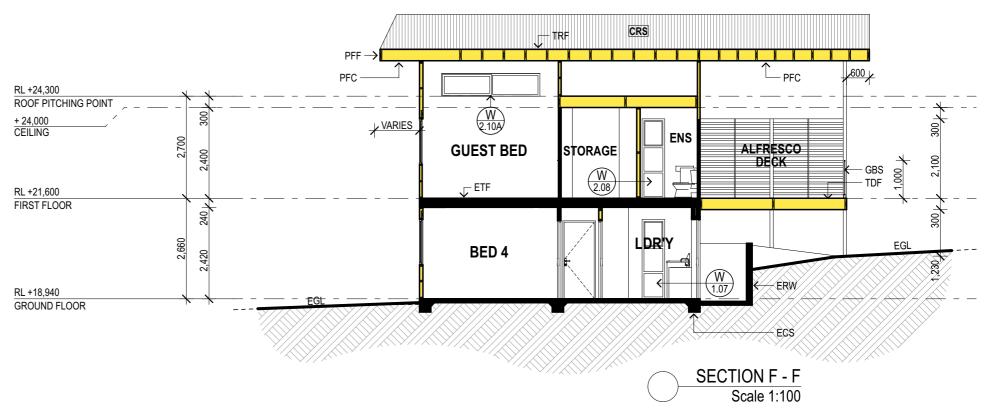

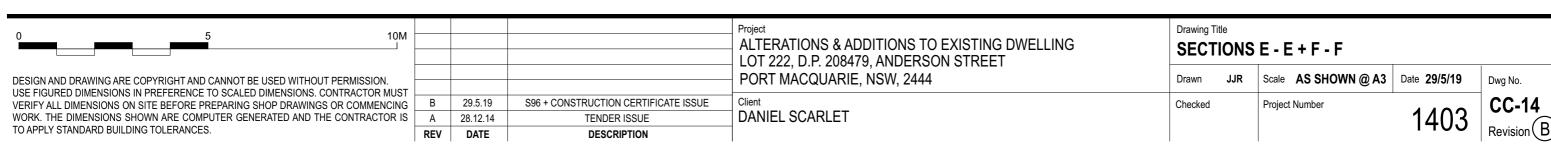

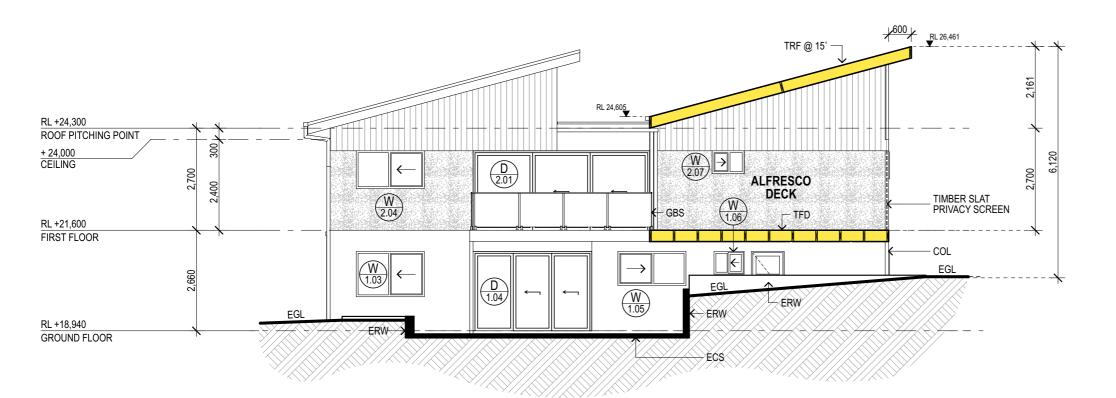

LEGEND:

ALUMINIUM FRAMED WINDOWS

ALUMINIUM FRAMED DOORS

COLUMN

DOWN PIPE

DOOR LABLE

EXISTING STUD WALL

EXISTING CONCRETE SLAB

EXISTING TIMBER FLOORING

EXISTING RETAINING WALL

EXISTING GROUND LINE

GLAZED BALUSTRADE

TIMBER FRAMED DECK

TIMBER FRAMED STAIR

TIMBER ROOF FRAMING

TIMBER FLOOR FRAMING

PAINTED FIBRE CEMENT

PAINTED FIBRE CEMENT FASCIA

TIMBER STUD WALL

PLASTERBOARD

WINDOW LABLE

RAINWATER GUTTER

AFW

AFD

COL

DP

D

ESW

ECS

ETF

ERW

EGL

GBS

TFD

TFS

TRF

TFF

TSW


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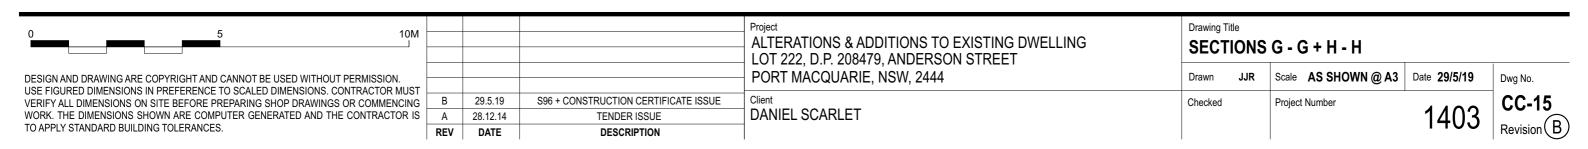
PFF

PBD

RWG

SECTION G - G Scale 1:100



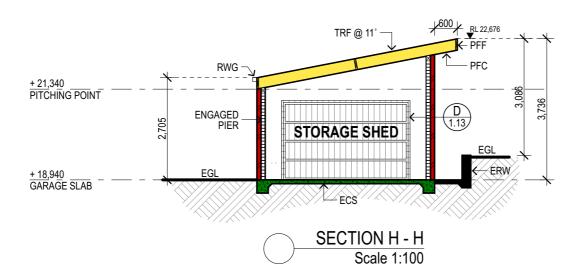

			DOOR SCHEDULE		
ID:	HEIGHT (MM)	WIDTH (MM)	ELEVATION:	ORIENTATION:	AREA: M2
D1.01	2,100	1,800		NW	3.78
D1.02	2,100	4,800		NW	10.08
D1.04	2,100	3,140		SE	6.59
D1.13	2,100	3,400		NW	7.14
D2.01	2,100	4,670		SE	9.81
D2.02	2,100	4,800		NW	10.08

0 5 10M				Project ALTERATIONS & ADDITIONS TO EXISTING DWELLING LOT 222, D.P. 208479, ANDERSON STREET	Drawing Ti		IEDULE		
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VERIFY ALL DIMENSIONS ON SITE BEFORE PREPARING SHOP DRAWINGS OR COMMENCING	_	29.5.19	S96 + CONSTRUCTION CERTIFICATE ISSUE	Client	Checked		Project Number		CC-16
WORK. THE DIMENSIONS SHOWN ARE COMPUTER GENERATED AND THE CONTRACTOR IS		28.12.14	TENDER ISSUE	DANIEL SCARLET				1403	
TO APPLY STANDARD BUILDING TOLERANCES.	REV	DATE	DESCRIPTION					1 100	Revision B

			WINDOW SCHEDULE		
ID:	HEIGHT: (MM)	WIDTH: (MM)	ELEVATION:	ORIENTATION:	AREA: (M2)
W1.01	1,760	1,800		NW	3.17
W1.03	1,200	1,800		SE	2.16
W1.05	900	1,800		SE	1.62
W1.06	600	800		SE	0.48
W1.07	2,100	600		NE	1.26
W1.08	600	1,400		NE	0.84
W1.09	1,200	2,400		NW	2.88

			WINDOW SCHEDULE		
ID:	HEIGHT: (MM)	WIDTH: (MM)	ELEVATION:	ORIENTATION:	AREA: (M2)
W2.01	900	2,100		NE	1.89
W2.01A	900	2,100		NE	1.89
W2.01B	900	2,100		NE	1.89
W2.03	1,200	1,800		SW	2.16
W2.04	1,000	1,800		SE	1.80
W2.07	600	850		SE	0.51
W2.08	2,100	600		NE	1.26
W2.10	1,200	2,400		NW	2.88
W2.10A	600	2,600		NE	1.56

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0	5	10M		
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DECICAL AND DRAWING	ADE CODVEICHT AND CANNOT BE HEED W	ITHOUT DEDMICCION		
DESIGN AND DRAWING	ARE COPYRIGHT AND CANNOT BE USED W	HITOUT PERIVISSION.		

USE FIGURED DIMENSIONS IN PREFERENCE TO SCALED DIMENSIONS. CONTRACTOR MUS VERIFY ALL DIMENSIONS ON SITE BEFORE PREPARING SHOP DRAWINGS OR COMMENCING WORK. THE DIMENSIONS SHOWN ARE COMPUTER GENERATED AND THE CONTRACTOR IS TO APPLY STANDARD BUILDING TOLERANCES.

CARLET
CQUARIE
ONS & AI ).P. 2084
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ALTERATIONS & ADDITIONS TO EXISTING DWELLING LOT 222, D.P. 208479, ANDERSON STREET PORT MACQUARIE, NSW, 2444

WINDOW SCHEDULE Drawn Checked Project Number

Drawing Title

Scale AS SHOWN @ A3 Date 29/5/19

Dwg No.