PROPOSED DUAL OCCUPANCY No. 4 GWANDALAN ROAD PADSTOW

Schedule of BASIX commitments - UNIT 01

The commitments set out below regulate how the proposed development is to be carried out. It is a condition of any development consent granted, or complying

development certificate issued, for the proposed development, that BASIX commitments be complied with.

Fixtures

The applicant must install showerheads with a minimum rating of 4 star (> 4.5 but <= 6 L/min plus spray force and/or coverage tests) in all showers in the development

The applicant must install a toilet flushing system with a minimum rating of 6 star in each toilet in the development

The applicant must install taps with a minimum rating of 6 star in the kitchen in the development.

The applicant must install basin taps with a minimum rating of 6 star in each bathroom in the development.

Alternative water

Rainwater tank

The applicant must install a rainwater tank of at least 2000 litres on the site. This rainwater tank must meet, and be installed in accordance with, the requirements of all applicable regulatory authorities.

The applicant must configure the rainwater tank to collect rain runoff from at least 100 square metres of the roof area of the development (excluding the area of the roof which drains to any stormwater tank or private dam).

The applicant must connect the rainwater tank to:

- · all toilets in the development
- at least one outdoor tap in the development (Note: NSW Health does not recommend that rainwater be used for human consumption in areas with potable water supply.)

General features

The dwelling must be a Class 1 dwelling according to the Building Code of Australia, and must not have more than 2 storeys. The conditioned floor area of the dwelling must not exceed 300 square metres.

The dwelling must not contain open mezzanine area exceeding 25 square metres.

The dwelling must not contain third level habitable attic room.

Floor, walls and ceiling/roof

The applicant must construct the floor(s), walls, and ceiling/roof of the dwelling in accordance with the specifications listed in the table **Thermal Comfort Commitments**

Windows, glazed doors and skylights

The applicant must install the windows, glazed doors and shading devices described in the table below, in accordance with the specifications listed in the table. Relevant overshadowing specifications must be satisfied for each window and glazed door.

The dwelling may have 1 skylight (<0.7 square metres) which is not listed in the table.

The following requirements must also be satisfied in relation to each window and glazed door:

- For the following glass and frame types, the certifier check can be performed by visual inspection.
- Aluminium single clear
- Aluminium double (air) clear
- Timber/uPVC/fibreglass single clear
- Timber/uPVC/fibreglass double (air) clear

• For other glass or frame types, each window and glazed door must be accompanied with certification showing a U value no greater than that listed and a Solar Heat Gain Coefficient (SHGC) within the range of those listed. Total system U values and SHGC must be calculated in accordance with National Fenestration Rating Council (NFRC) conditions. Frame and glass types shown in the table below are for reference only.

· Overshadowing buildings/vegetation must be of the height and distance from the centre and the base of the window and glazed door, as specified in the 'overshadowing' column.

Energy Commitments

The applicant must install the following hot water system in the development, or a system with a higher energy rating; gas instantaneous with a performance of 6 stars.

Cooling system

The applicant must install the following cooling system, or a system with a higher energy rating, in at least 1 living area: 1-phase airconditioning; Energy rating: 5 Star

The applicant must install the following cooling system, or a system with a higher energy rating, in at least 1 bedroom: 1-phase airconditioning; Energy rating: 5 Star

The cooling system must provide for day/night zoning between living areas and bedrooms.

Heating system

The applicant must install the following heating system, or a system with a higher energy rating, in at least 1 living area: 1-phase airconditioning; Energy rating: 5 Star

The applicant must install the following heating system, or a system with a higher energy rating, in at least 1 bedroom: 1-phase airconditioning; Energy rating: 5 Star

The heating system must provide for day/night zoning between living areas and bedrooms.

Ventilation

The applicant must install the following exhaust systems in the development:

At least 1 Bathroom: no mechanical ventilation (ie. natural); Operation control: n/a

Kitchen: no mechanical ventilation (ie. natural); Operation control: n/a Laundry: natural ventilation only, or no laundry; Operation control: n/a

Artificial lighting

The applicant must ensure that the "primary type of artificial lighting" is fluorescent or light emitting diode (LED) lighting in each of the following rooms, and where the word "dedicated" appears, the fittings for those lights must only be capable of accepting fluorescent or light emitting diode (LED) lamps:

- at least 4 of the bedrooms / study; dedicated
- at least 3 of the living / dining rooms; dedicated
- the kitchen: dedicated
- · all bathrooms/toilets: dedicated
- · the laundry; dedicated all hallways; dedicated
- Natural lighting

The applicant must install a window and/or skylight in 3 bathroom(s)/toilet(s) in the development for natural lighting.

The applicant must install a gas cooktop & electric oven in the kitchen of the dwelling.

The applicant must construct each refrigerator space in the development so that it is "well ventilated", as defined in the BASIX

The applicant must install a fixed outdoor clothes drying line as part of the development.

Schedule of BASIX commitments - UNIT 01

The commitments set out below regulate how the proposed development is to be carried out. It is a condition of any development consent granted. or complying development certificate issued, for the proposed development, that BASIX commitments be complied with.

Water Commitments

Fixtures

The applicant must install showerheads with a minimum rating of 4 star (> 4.5 but <= 6 L/min plus spray force and/or coverage tests) in all showers in the development

The applicant must install a toilet flushing system with a minimum rating of 6 star in each toilet in the development.

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The applicant must connect the rainwater tank to:

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Thermal Comfort Commitments

General features

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Floor, walls and ceiling/roof

The applicant must construct the floor(s), walls, and ceiling/roof of the dwelling in accordance with the specifications listed in the table Windows, glazed doors and skylights

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Energy Commitments

Hot water

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The heating system must provide for day/night zoning between living areas and bedrooms.

The applicant must install the following exhaust systems in the development:

At least 1 Bathroom: no mechanical ventilation (ie. natural); Operation control: n/a

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The applicant must ensure that the "primary type of artificial lighting" is fluorescent or light emitting diode (LED) lighting in each of the following rooms, and where the word "dedicated" appears, the fittings for those lights must only be capable of accepting fluorescent or light emitting diode (LED) lamps:

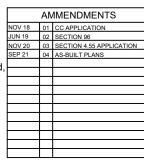
- · at least 4 of the bedrooms / study; dedicated
- · at least 3 of the living / dining rooms; dedicated
- · the kitchen; dedicated
- · all bathrooms/toilets: dedicated
- · the laundry; dedicated
- · all hallways; dedicated Natural lighting

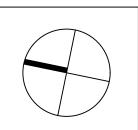
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The applicant must install a fixed outdoor clothes drying line as part of the development.





THE WORK IS TO COMPLY WITH THE BIULDING CODE OF AUSTRALIA, SAA CODES, AND OTHER BY-LAWS

SHALL CHECK AND VERIFY ALL DIMENSIONS.RL'S AND CONSTRUCTON METHODS PRIOR TO THE START OF ANY WORK ON SITE. IF THERE ARE ANY DOUBTS ASK. DIMENSIONS ON THE DRAWING

THE BUILDER/MANUFACTURER

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PROJECT PROPOSED DUAL OCCUPANCY

ADDRESS

No 4 **GWANDALAN ROAD PADSTOW**

CLIENT

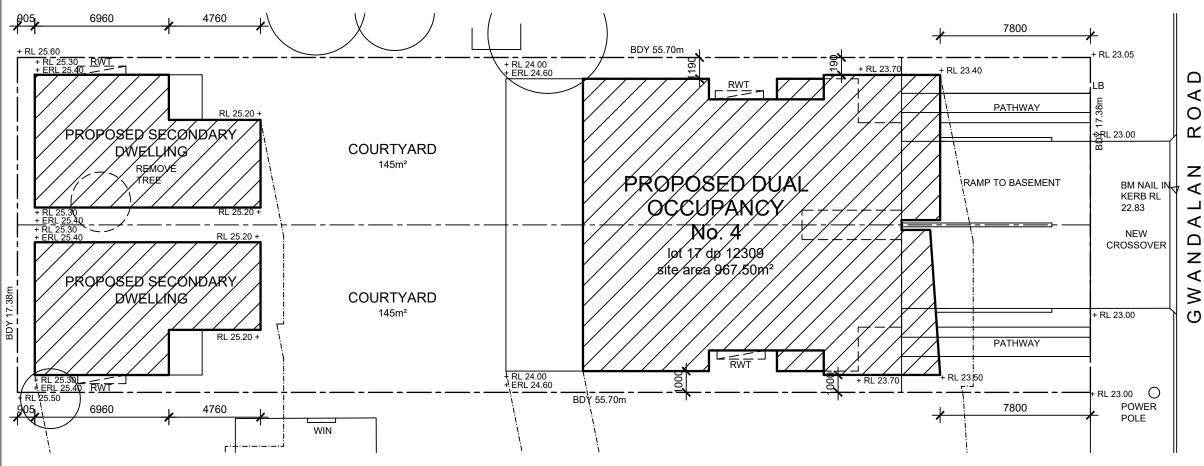
MR & MRS EL FELAK

DATE 29.05.18 DWG No.

SHOWN JOB No.

SCALE

A01



SITE PLAN

SCALE 1:200

GENERAL NOTES

DO NOT SCALE PLANS, USE WRITTEN DIMENSIONS ONLY. IF IN DOUBT, ASK.

THE OWNER/BUILDER SUBCONTRACTOR SHALL VERIFY ALL DIMENSIONS, LEVELS, SETBACKS AND SPECIFICATIONS PRIOR TO COMMENCING WORKS OR ORDERING MATERIALS AND SHALL BE RESPONSIBLE FOR ENSURING THAT ALL BUILDING WORKS CONFORM TO THE BUILDING CODE OF AUSTRALIA, CURRENT AUSTRALIAN STANDARDS, BUILDING REGULATIONS AND TOWN PLANNING REQUIREMENTS, REPORT ANY DISCREPANCIES TO THE OWNER OR CONTRACTOR.

ALL WORKS SHALL COMPLY WITH BUT NOT LIMITED TO THE BUILDING CODE OF AUSTRALIAN AND THE AUSTRALIAN STANDARDS LISTED.

AS 1288 - 1994 GLASS IN BUILDINGS - SELECTION AND INSTALLATION AS 1562 - 1992 DESIGN AND INSTALLATION OF SHEET ROOF AND WALL CLADDING

AS 1684 - 1999 NATIONAL TIMBER FRAMING CODE

AS 2049 - 1992 ROOF TILES

AS 2050 - 1995 INSTALLATION OF ROOF TILES

AS 2870 - 1996 RESIDENTIAL SLAB AND FOOTINGS - CONSTRUCTION

AS/NZS 2904 - 1995 DAMP-PROOF COURSES AND FLASHINGS

AS 3600 - 1994 CONCRETE STRUCTURES

AS 3660 - 2004 BARRIERS FOR SUBTERRANEAN TERMITES

AS 3700 - 1998 MASONRY IN BUILDINGS

AS 3740 - 1994 WATERPROOFING OF WET AREAS IN RESIDENTIAL BUILDINGS

AS 3786 - 1993 SMOKE ALARMS

AS 4055 - 1992 WIND LOADINGS FOR HOUSING

AS 4100 - 1996 STEEL STRUCTURES

THESE PLANS SHALL BE READ IN CONJUNCTION WITH ANY SOIL, STRUCTURAL AND CIVIL ENGINEERING CALCULATIONS AND DRAWINGS.

ALL BUILDINGS SHALL BE PROTECTED AGAINST TERMITE ATTACK IN ACCORDANCE WITH AS 3660.1 AND A DURABLE NOTICE SHALL BE PLACED IN THE METER BOX INDICATING TYPE OF BARRIER AND REQUIRED PERIODICAL INSPECTIONS.

SAFETY GLAZING TO BE USED IN THE FOLLOWINGS CASES -

i) ALL ROOMS - WITHIN 500mm VERTICAL OF THE FLOOR

ii) BATHROOMS - WITHIN 1500mm VERTICAL OF THE BATH BASE

iii) FULLY GLAZED DOORS

iv) SHOWER SCREENS

v) WITHIN 300mm OF A DOOR AND <1200mm ABOVE FLOOR LEVEL vi) WINDOW SIZES ARE NOMINAL ONLY, ACTUAL SIZES WILL VARY WITH MANUFACTURER, AND ARE TO BE VERIFIED WITH SAME. FLASHING ALL

TILED DECKS OVER LIVABLE AREAS ARE TO BE, IN THE FOLLOWING ORDER

OVER THE FLOOR JOISTS: 19mm COMPRESSED FIBRE CEMENT SHEET, WITH ONE LAYER OF PARCHEM EMERPROOF 750 WITH A SECOND LAYER OF SAND SEED WITH A DFT OF 1300 MICRON, INSTALLED TO MANUF. SPECIFICATIONS, AND FLOOR TILES OVER, ALL CORNERS TO HAVE 20mm MASTIC SEALANT UNDER THE PARCHEM EMERPROOF 750.

FOOTINGS ARE TO BE WHOLLY WITHIN TITLE BOUNDARIES AND ARE NOT TO ENCROACH EASEMENTS. IT IS RECOMMENDED THAT WHERE BUILDINGS ARE TO BE LOCATED IN CLOSE PROXIMITY OF BOUNDARIES, A CHECK SURVEY BE CONDUCTED BY A LICENSED SURVEYOR.

ALL STEELWORK IN MASONRY TO BE HOT DIP GALVANISED.

ALL WET AREAS TO COMPLY WITH BCA 3.8.1.2 AND AS 3740. SPLASH BACKS SHALL BE IMPERVIOUS FOR 150mm ABOVE SINKS, TROUGHS AND HAND BASINS WITHIN 75mm OF THE WALL.

PROVIDE WALL TIES AT 600mm SPACINGS BOTH VERTICAL AND HORIZONTAL AND WITHIN 300mm OF ARTICULATION JOINTS. BRICK TIES TO BE STAINLESS

SUB-FLOOR VENTILATION MINIMUM 7500mm/sq FOR EXTERNAL WALLS AND 1500mm/sq FOR INTERNAL WALLS BELOW BEARER.

SAFETY GLAZING TO BE USED IN THE FOLLOWINGS CASES -

i) ALL ROOMS - WITHIN 500mm VERTICAL OF THE FLOOR

ii) BATHROOMS - WITHIN 1500mm VERTICAL OF THE BATH BASE

iii) FULLY GLAZED DOORS

iv) SHOWER SCREENS

v) WITHIN 300mm OF A DOOR AND <1200mm ABOVE FLOOR LEVEL vi) WINDOW SIZES ARE NOMINAL ONLY, ACTUAL SIZES WILL VARY WITH MANUFACTURER, AND ARE TO BE VERIFIED WITH SAME. FLASHING ALL THERMAL INSULATION TO BE PROVIDED TO ACHIEVE MINIMUM REQUIREMENTS AS SPECIFIED BY LICENSED ASSESSOR.

STAIR REQUIREMENTS: MIN. TREAD 240mm, MIN. RISER 115mm, MAX. RISER 190mm, SPACE BETWEEN OPEN TREADS MAX. 125mm. TREADS TO BE NON SLIP SURFACE.

BALUSTRADES: MIN. 1000mm ABOVE LANDINGS WITH MAX. OPENING OF 125mm AND IN ACCORDANCE WITH BCA 3.9.2

FOR STAINLESS STEEL BALUSTRADE, REFER TO Table 3.9.2.1 (WIRE BALUSTRADE CONSTRUCTION - REQUIRED WIRE TENSION AMD MAXIMUM PERMISSIBLE DEFLECTION) OF THE BCA.

THE BUILDER SHALL TAKE ALL STEPS NECESSARY TO ENSURE THE STABILITY OF EXISTING AND NEW STRUCTURES THROUGH-OUT CONSTRUCTION.

SMOKE DETECTORS (refer electrical layout plans), TO BE HARD WIRED WITH EMERGENCY BACK-UP AND COMPLY WITH AS

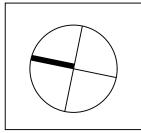
PROVIDE LIFT OFF HINGES, OPEN OUT DOOR OR MIN 1200mm CLEARANCE FROM DOOR TO PAN IN WATER CLOSETS.

EXHAUST FANS FROM SANITARY COMPARTMENTS ARE TO BE DUCTED EXTERNALLY OR TO A VENTED ROOF SPACE IN COMPLIANCE WITH AS 1668.2

THESE NOTES ARE NEITHER EXHAUSTIVE NOR A SUBSTITUTE FOR REGULATIONS, STATUTORY REQUIREMENTS, BUILDING PRACTICE OR CONTRACTUAL OBLIGATIONS.

THESE PLANS ARE PROTECTED BY COPY RIGHT AND ARE THE PROPERTY OF THE AUTHOR

AMMENDMENTS			
NOV 18	01	CC APPLICATION	
JUN 19	02	SECTION 96	
NOV 20	03	SECTION 4.55 APPLICATION	
SEP 21	04	AS-BUILT PLANS	
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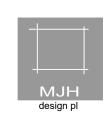
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PROJECT PROPOSED DUAL OCCUPANCY

ADDRESS

GWANDALAN ROAD PADSTOW

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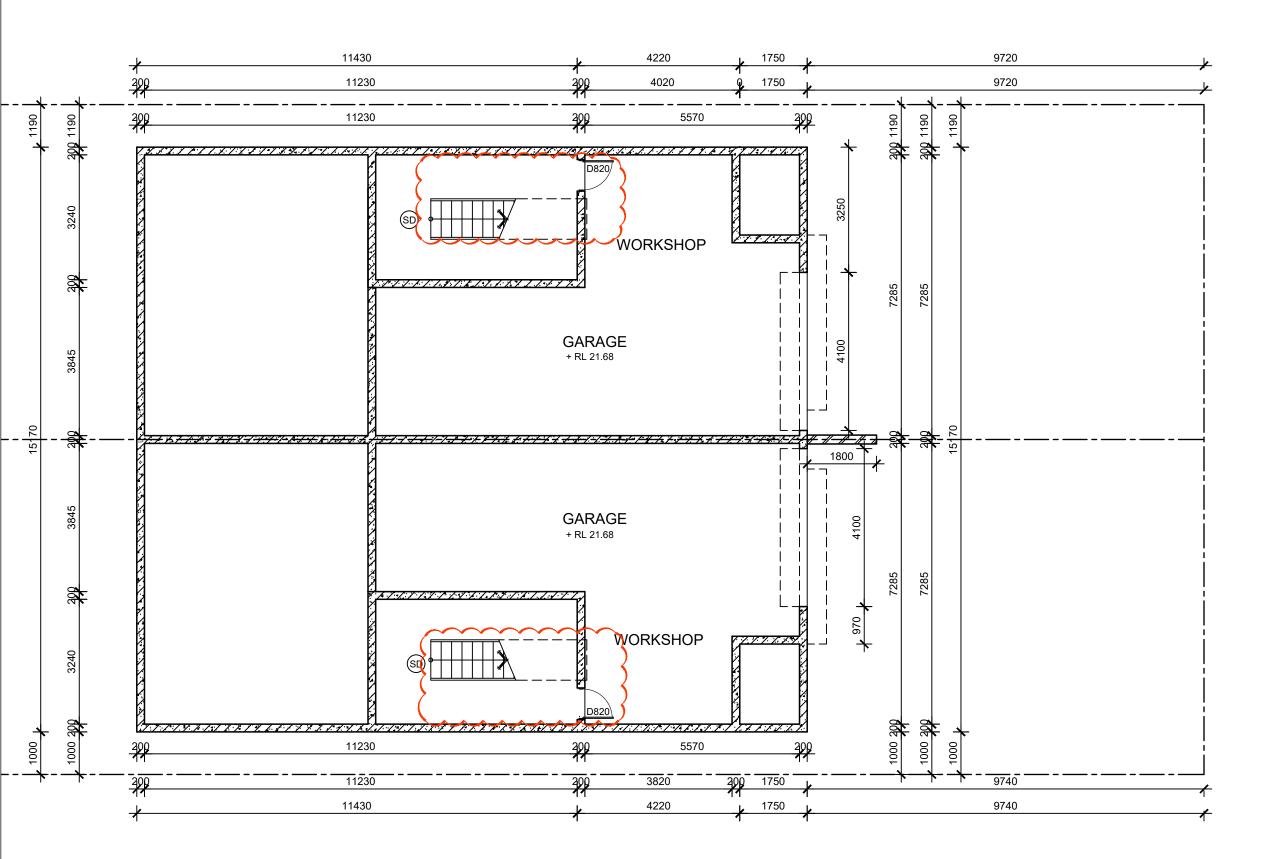
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DATE 29.05.18 DWG No.

A01

SHOWN JOB No.

SCALE



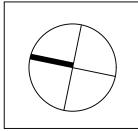
CONSTRUCTION TO COMPLY WITH PART 3.8.6 SOUND INSULATION AND TO ACHIEVE A MINIMUM LEVEL OF Rw + Ctr 50

ALL WORKS TO COMPLY WITH BUILDING CODE OF AUSTRALIA

ALL BEDROOM WINDOWS TO COMPLY WITH PART 3.9.2.5 PROTECTION OF OPENABLE WINDOWS

BASEMENT FLOOR PLAN

AMMENDMENTS		
NOV 18	01	CC APPLICATION
JUN 19	02	SECTION 96
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SEP 21	04	AS-BUILT PLANS
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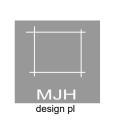
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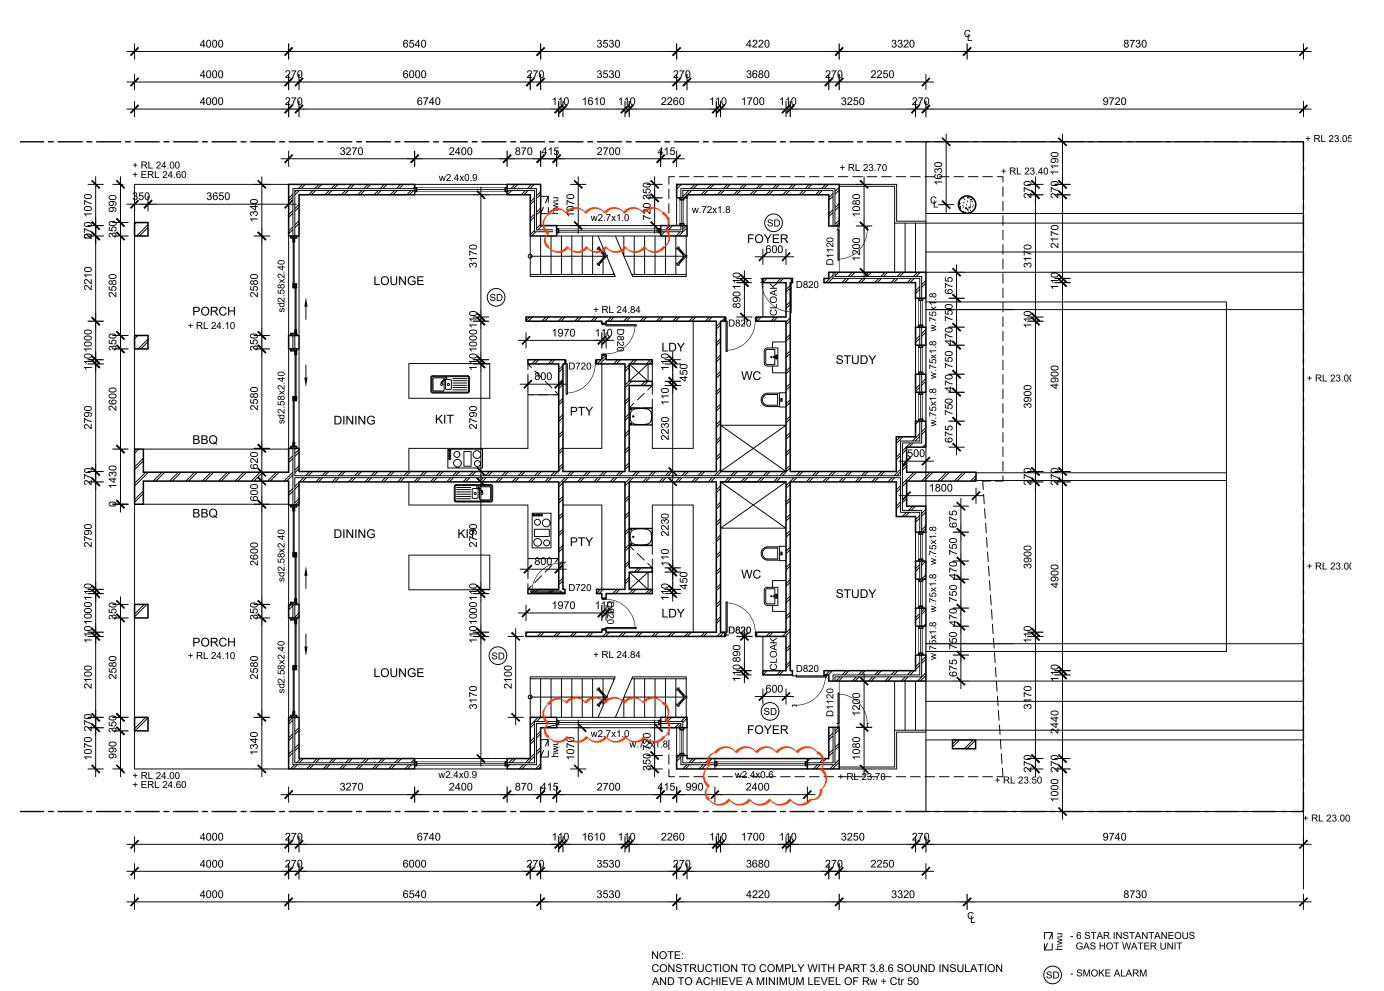
MR & MRS EL FELAK

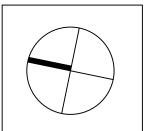
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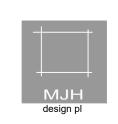
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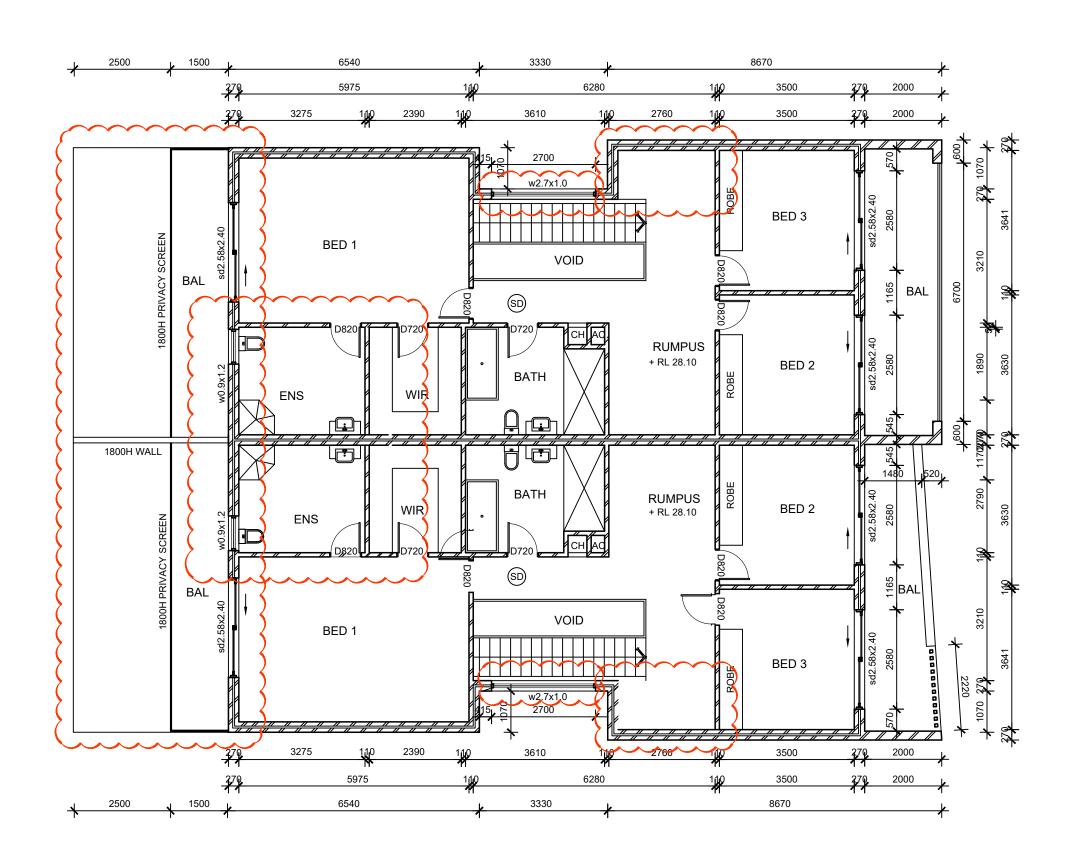
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ALL BEDROOM WINDOWS TO COMPLY WITH PART 3.9.2.5 PROTECTION OF OPENABLE WINDOWS

ALL WORKS TO COMPLY WITH BUILDING CODE OF AUSTRALIA



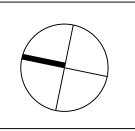
FIRST FLOOR PLAN **SCALE 1:100**

CONSTRUCTION TO COMPLY WITH PART 3.8.6 SOUND INSULATION AND TO ACHIEVE A MINIMUM LEVEL OF Rw + Ctr 50

ALL WORKS TO COMPLY WITH BUILDING CODE OF AUSTRALIA

ALL BEDROOM WINDOWS TO COMPLY WITH PART 3.9.2.5 PROTECTION OF OPENABLE WINDOWS

AMMENDMENTS			
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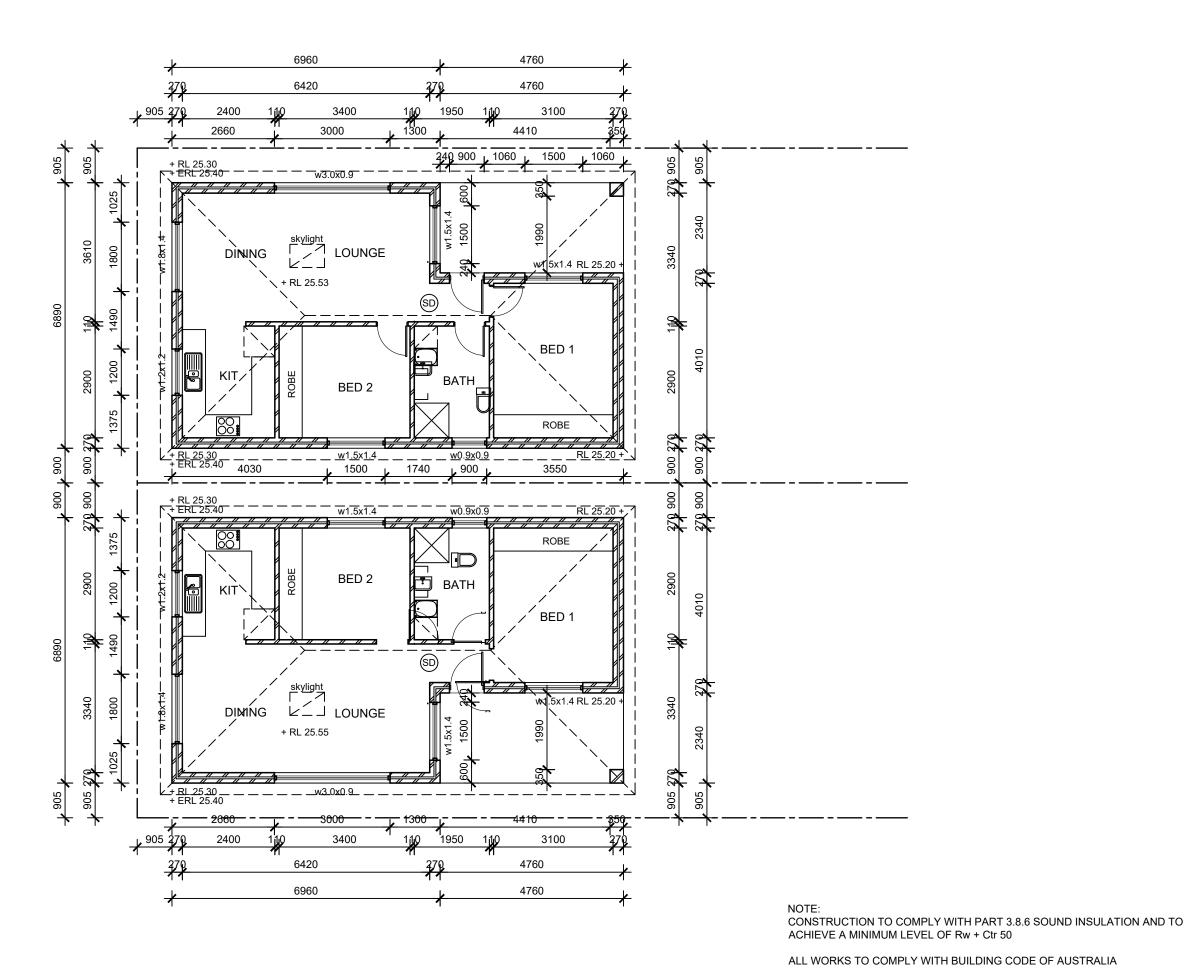
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DATE 29.05.18 DWG No.

JOB No.

SCALE

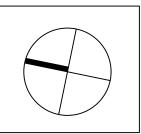
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SECONDARY DWELLING FLOOR PLAN SCALE 1:100

ALL BEDROOM WINDOWS TO COMPLY WITH PART 3.9.2.5 PROTECTION OF OPENABLE WINDOWS

AMMENDMENTS			
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JUN 19	02	SECTION 96	
NOV 20	03	SECTION 4.55 APPLICATION	
SEP 21	04	AS-BUILT PLANS	
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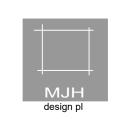
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MR & MRS EL FELAK

DATE 29.05.18 DWG No.

No. JOB No.

SCALE SHOWN



SOUTH ELEVATION

SCALE 1:100

ALUMINIUM LOUVRE PRIVACY SCREEN				RL 31.12	CEILING RL 30.82
008 P	RP1	RP1	RP2		FIRST FLOOR RL 28.10
RP1	ALW	ALW RP1	FB1	RP1	GROUND FLOOR RL 24.84

WEST ELEVATION

SCALE 1:100

CONSTRUCTION TO COMPLY WITH PART 3.8.6 SOUND INSULATION AND TO ACHIEVE A MINIMUM LEVEL OF Rw + Ctr 50

FINISHES SCHEDULE

ALW FB1

GLB

MDR

QGR

PLD

RP1

RP1

VLS

SSC

OP

SUNSHADE HOOD

AWNING WINDOW

GLASS BALUSTRADE

METAL DECK ROOF

OPAQUE GLASS

PANEL LIFT DOOR

RENDER AND PAINT 1

RENDER AND PAINT 1

VERTICAL LOUVRE

STANDING SEAM CLADDING

QUAD GUTTER

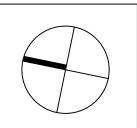
SCREEN

FACE BRICK 1

ALL WORKS TO COMPLY WITH BUILDING CODE OF AUSTRALIA

ALL BEDROOM WINDOWS TO COMPLY WITH PART 3.9.2.5 PROTECTION OF OPENABLE WINDOWS

AMMENDMENTS			
NOV 18	01	CC APPLICATION	
JUN 19	02	SECTION 96	
NOV 20	03	SECTION 4.55 APPLICATION	
SEP 21	04	AS-BUILT PLANS	



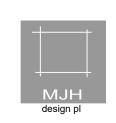
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PROJECT PROPOSED DUAL OCCUPANCY

ADDRESS

No. 4 GWANDALAN ROAD PADSTOW

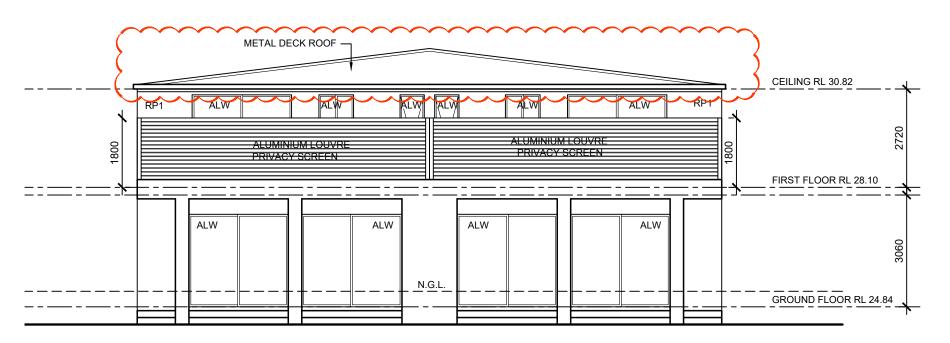
CLIENT

MR & MRS EL FELAK

DATE 29.05.18 DWG No.

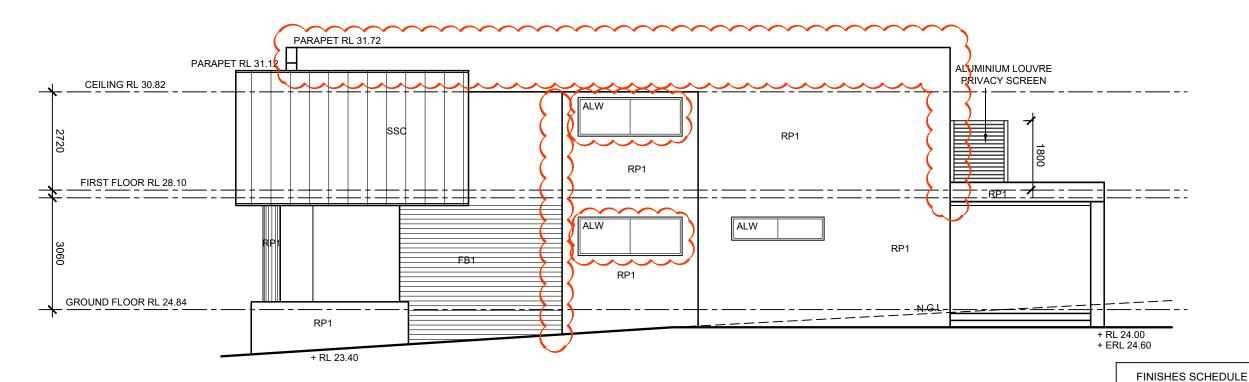
SCALE SHOWN JOB No.

No. JOB



NORTH ELEVATION

SCALE 1:100



EAST ELEVATION

SCALE 1:100

CONSTRUCTION TO COMPLY WITH PART 3.8.6 SOUND INSULATION AND TO ACHIEVE A MINIMUM LEVEL OF Rw + Ctr 50

ALL WORKS TO COMPLY WITH BUILDING CODE OF AUSTRALIA

ALL BEDROOM WINDOWS TO COMPLY WITH PART 3.9.2.5 PROTECTION OF OPENABLE WINDOWS

ALW	AWNING WINDOW
FB1	FACE BRICK 1
GLB	GLASS BALUSTRADE
MDR	METAL DECK ROOF
OP	OPAQUE GLASS
QGR	QUAD GUTTER
PLD	PANEL LIFT DOOR
RP1	RENDER AND PAINT 1
RP1	RENDER AND PAINT 1

SCREEN

CLADDING

VERTICAL LOUVRE

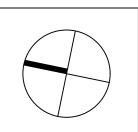
STANDING SEAM

VLS

SSC

SUNSHADE HOOD

AMMENDMENTS			
NOV 18	01	CC APPLICATION	
JUN 19	02	SECTION 96	
NOV 20	03	SECTION 4.55 APPLICATION	
SEP 21	04	AS-BUILT PLANS	
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PROJECT PROPOSED DUAL OCCUPANCY

ADDRESS

No. 4 **GWANDALAN ROAD PADSTOW**

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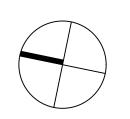
MR & MRS EL FELAK

DATE **SCALE** 29.05.18 DWG No. A07

SHOWN JOB No.



OPENABLE WINDOWS



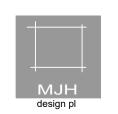
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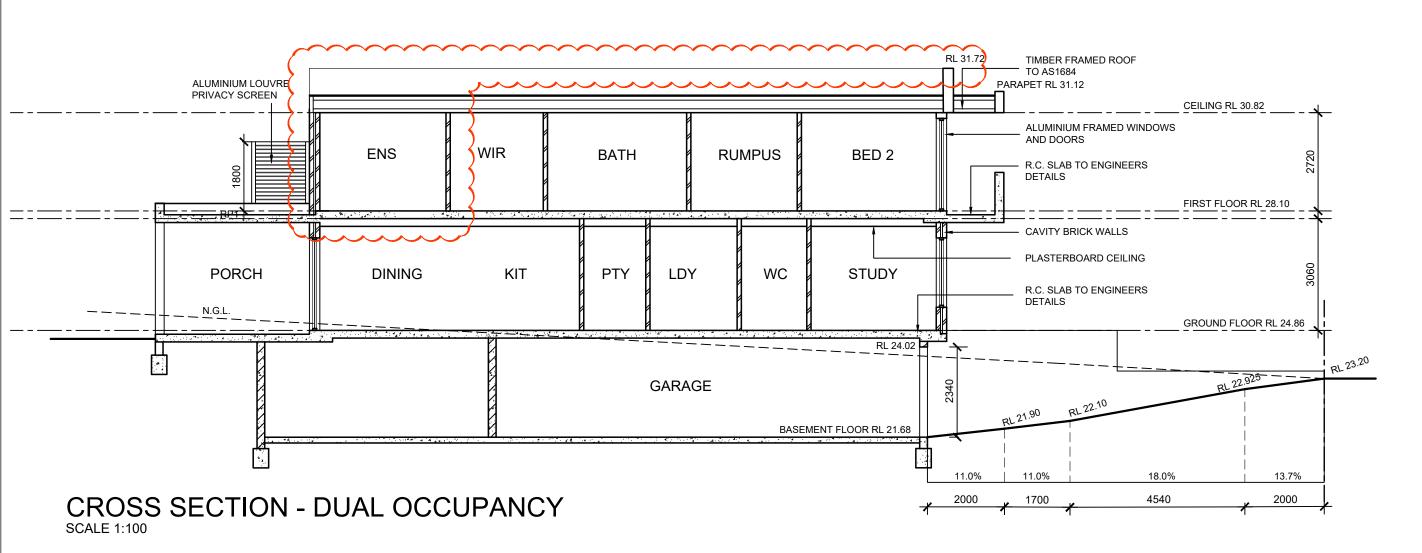
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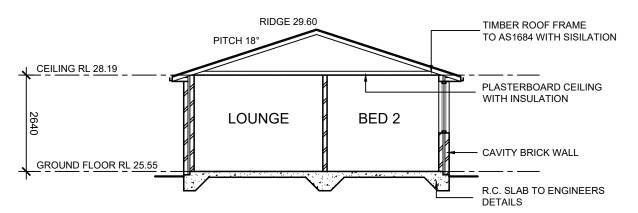
DATE 29.05.18 DWG No.

CLADDING

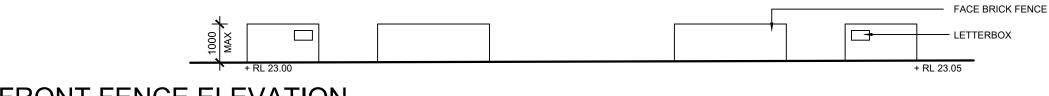
18 SHOWN
G No. JOB No.

SCALE





CROSS SECTION - SECONDARY DWELLING SCALE 1:100



FRONT FENCE ELEVATION

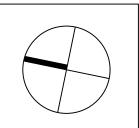
SCALE 1:100

CONSTRUCTION TO COMPLY WITH PART 3.8.6 SOUND INSULATION AND TO ACHIEVE A MINIMUM LEVEL OF Rw + Ctr 50

ALL WORKS TO COMPLY WITH BUILDING CODE OF AUSTRALIA

ALL BEDROOM WINDOWS TO COMPLY WITH PART 3.9.2.5 PROTECTION OF **OPENABLE WINDOWS**

AMMENDMENTS			
NOV 18	01	CC APPLICATION	
JUN 19	02	SECTION 96	
NOV 20	03	SECTION 4.55 APPLICATION	
SEP 21	04	AS-BUILT PLANS	
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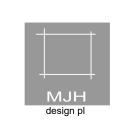
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No. 4 GWANDALAN ROAD **PADSTOW**

CLIENT

MR & MRS EL FELAK

DATE 29.05.18 DWG No.

JOB No. A09

SCALE SHOWN